

Date: October 16, 2025 Case/File Helix Water Wireless:

No.: PDS2022-ZAP-96-035W2;

PDS2022-ER-96-14-027B

Place: County Conference Center

5520 Overland Avenue

San Diego, CA 92123 T

Project:

existing Wireless Telecommunication

Removal/relocation of

Facility

Time: 8:30 a.m. Location: 13002 I-8 Business,

El Cajon, CA 91906

Agenda Item: #1 General Plan: Semi-Rural Residential

(SR-4)

Appeal Status: Appealable to the Planning

Commission

Zoning: Rural Residential (RR)

Applicant/Owner: T-Mobile Community: Lakeside Community

Planning Area

Environmental: CEQA §15301 Exemption **APN:** 400-060-03-00

A. OVERVIEW

The purpose of this staff report is to provide the Zoning Administrator with the information necessary to make a finding that the proposed Minor Use Permit (ZAP) Modification to remove an existing T-Mobile monopole and equipment and mount new antennas onto an existing Helix Water District water tank and update to new equipment, conditions of approval and findings, and environmental findings prepared in accordance with the California Environmental Quality Act.

B. REQUESTED ACTIONS

This is a request for the Zoning Administrator to evaluate the proposed ZAP Modification to remove an existing T-Mobile monopole and equipment and mount new antennas onto an existing Helix Water District water tank, determine if the required findings can be made and, if so, take the following actions:

- a. Grant ZAP modification PDS2022-ZAP-96-035W2, make the findings and impose the requirements and conditions as set forth in the Form of Decision (Attachment B).
- b. Adopt the Environmental Findings included in Attachment D, which includes a finding that the project is exempt from the California Environmental Quality Act (CEQA).

C. BACKGROUND

On October 4, 1996, the Zoning Administrator approved a ZAP to authorize the operation of a wireless communication antenna facility on a 50 foot,5-inch tall monopole and equipment adjacent to an existing Helix Water storage reservoir in the Lakeside Community Planning Area.

On August 27, 2020, the Zoning Administrator approved a Modification to the Minor Use Permit to convert the monopole to a 50 foot, 5-inch tall faux monopalm wireless telecommunications facility and equipment. This modification was never built.

D. DEVELOPMENT PROPOSAL

1. Project Description

The proposed project is a ZAP Modification to remove an existing T-Mobile monopole and equipment and mount new equipment onto an existing Helix Water District water tank. The modification includes the installation of new antennas and associated equipment. Access to the site will be through a private road easements that connect onto I-8 Business.



Figure 1: Existing Southwest view of existing monopole and antennas



Figure 2: Proposed Southwest view of proposed antennas

2. Project Description

The project is located on a site owned by the Helix Water District within the Lakeside Community Plan area. The site is accessed by a private road easement that connects to Highway 8 business a County-maintained Road (Figure 1). The site is used by Helix Water District and contains two, 35 foot tall water storage tanks. The project site is zoned Rural Residential (RR) and the general plan designation is Semi-Rural Residential (SR-4).

Please refer to Attachment A – Planning Documentation, for maps of surrounding land uses and zoning designations.

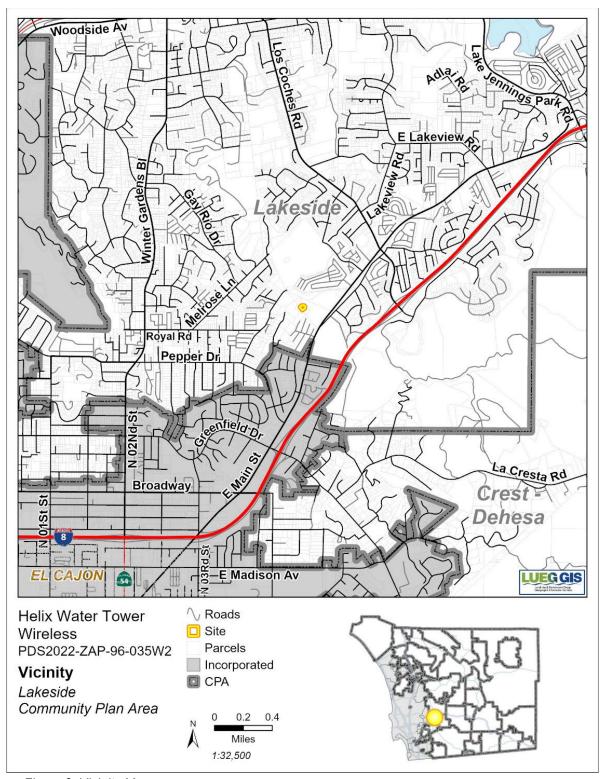


Figure 3: Vicinity Map

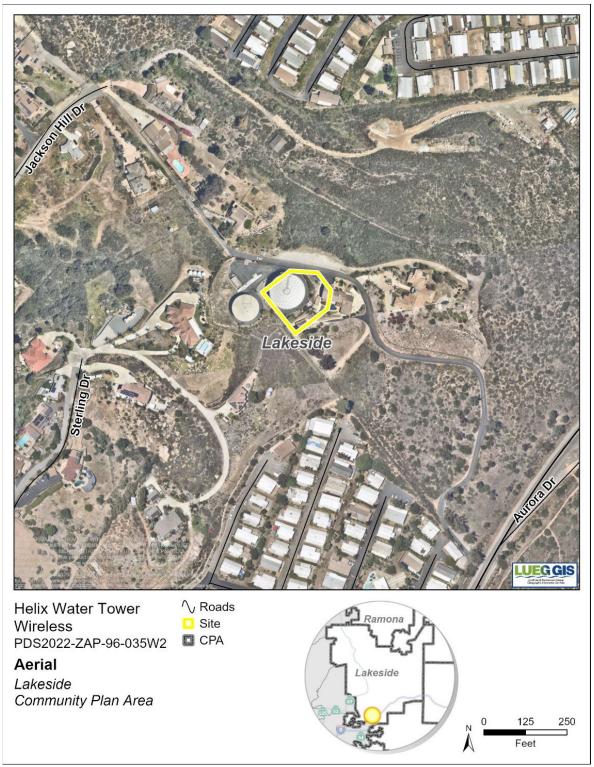


Figure 4: Aerial and adjacent properties

Table D-1: Surrounding Zoning and Land Uses

Location	General Plan	Zoning	Adjacent Streets	Description
North	Semi-Rural Residential (SR-4)	Rural Residential (RR)	Jackson Hill Dr	Residential
East	Semi-Rural Residential (SR-4)	Rural Residential (RR)	N/A	Residential
South	Village Residential (VR-2), Village Residential (VR-15)	Rural Residential (RR), Residential Mobile Home (RMH)	I-8 Business	Residential, Mobile Home Park
West	Public/Semi-Public Facilities, Village Residential (VR-2)	Rural Residential (RR)	N/A	Residential

E. ANALYSIS AND DISCUSSION

1. Key Requirements for Requested Action

The Zoning Administrator should consider the requested actions and determine if the following findings can be made:

- a) The project is consistent with the vision, goals and policies of the General Plan?
- b) Does the project comply with the policies set forth under the Lakeside Community Plan?
- c) Is the project consistent with the County's Zoning Ordinance?
- d) Is the project consistent with the County's Wireless Ordinance?
- e) Does the project comply with CEQA?

2. Project Analysis

The proposed wireless telecommunication facility is in a non-preferred zone but preferred location and is classifies as a "high visibility". The proposal is to modify ZAP-96-035 which was approved prior to the amortization schedule. A \$150,000 fair market value has been given by the applicant which falls under the guise of 10-year amortization schedule.

Amortization

The existing wireless telecommunication facility is in a residential zone and is defined as "low visibility" in accordance with 6985 and 6991 of the zoning ordinance. The project will modify ZAP-96-035 which was approved prior to the adoption of the Wireless Ordinance. ZAP findings have been made to support the renewal of existing wireless facility. In accordance with Section 6991 of the Zoning Ordinance, the applicant has submitted a valuation letter stating that the facility is valued at \$150,000 resulting in a 10-year permit. This time may be extended for an additional period of time by modifying the permit, if it is found that no smaller or less visible technology is available or feasible to replace the facility at the time of the request for a modification.

Site Planning Analysis

The proposed wireless telecommunication facility modification is compatible with the surrounding land uses, existing structures, vegetation, and topography. The proposed antennas will be painted to match existing water tower and keep the nature of the water tank in effect (Figure 2).

Community Compatibility/Visual impacts

The surrounding area has a topography of hills, mature trees and existing water tanks. The existing wireless facility and monopole would be taken down and the wireless antennas would be placed on a water tank which is a preferred location and will reduce the visual impact of the existing monopole. The proposed facility would be painted to match the existing water tank and reduce any visual impacts (Figure 2).

Alternate Site Analysis (ASA)

The proposed wireless telecommunication facility is designed to continue to provide cellular service coverage in Lakeside from between Los Coches Road to the northeast, Melrose Lane to the west, and Pepper Drive to the south. The site is zoned RR (Rural Residential), which is a nonpreferred zone, and therefore requires an ASA. The Applicant reviewed other potential sites within the area to demonstrate that the coverage objective could not be met in a preferred zone.

The tower is to complete a ring (Figure 5) where no industrial or commercial options existed in the highly concentrated residential location the wireless facilities aim to cover. T-Mobile will be removing an existing monopole wireless facility which is a non-preferred location and placing new facility onto a water tank which is a preferred location defined within Section 6869 of the San Diego County Zoning Ordinance in the same location, no other candidates or facilities were considered. The proposed wireless facility will minimize overall visual impact. The site has been designed and engineered to allow for future collocation and reduce the need for future facilities in the surrounding area.

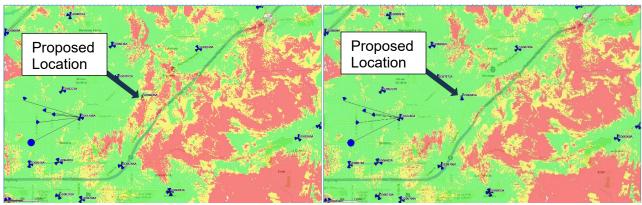


Figure 5: Coverage without project (left) and coverage with project (right)

3. General Plan Consistency

The proposed project is consistent with the following relevant General Plan goals, policies, and actions as described in Table E-1.

Table E-1: General Plan Conformance

General Plan Policy	Explanation of Project Conformance
GOAL S-1 - Public Safety. Enhanced	The Project will provide continued coverage
public safety and the protection of public and	throughout the area, which is essential in the event
private property.	of an emergency. The wireless telecommunication
	facility will minimize telecommunication
GOAL S-2 – Emergency Response.	interruptions by continuing to provide service and
Effective emergency response to disasters	coverage in the area.
that minimizes the loss of life and damage to	
property, while also reducing disruption in	
the delivery of vital public and private	
services during and following a disaster	
Policy LU 15.2 - Co-Location of	1
Telecommunication Facilities. Encourage	coverage especiates of the carrent offer the caspect
wireless telecommunication services	i additty will allow do lodation with other damiero to the
providers to co-locate their facilities whenever	i Calcili icadibic.
appropriate, consistent with the Zoning Ordinance	
Ordinance	

4. Zoning Ordinance Consistency

a. Development Regulations

The project complies with all applicable zoning requirements of the Rural Residential (RR) zone with the incorporation of conditions of approval (See Table E -2).

Table E-2: Zoning Ordinance Development Regulations

CURRENT ZONING		CONSISTENT?
REGULATIONS		
Use Regulation:	RR	Yes, upon approval of Minor Use Permit Modification
Animal Regulation:	J	N/A
Density:	-	N/A
Lot Size:	1AC	N/A
Building Type:	С	Yes
Height:	G	Yes, upon approval of a Minor Use Permit Modification
Lot Coverage:	-	N/A
Setback:	В	Yes
Open Space:	-	N/A
Special Area Regulations:	-	N/A

Development Standard	Proposed/Provided	Complies?
Section 4600 of the Zoning Ordinance sets the maximum height requirements. This parcel has a designated height of "G" which requires structures to be no more than 35 feet in height.	The project will be a maximum height of 36 feet. The existing monopole currently exceeds the 35 foot height limit as it is 50 feet, 5 inches. This ZAP Modification will bring the facility into closer compliance with the height limit.	Yes No 🗆
Section 4800 of the Zoning Ordinance requires that the project meet the "B" setback requirements of a 60-foot front yard setback, 15-foot interior side yard setback, 35-foot exterior side yard setback, and a 50-foot rear yard setback.	the front, rear, or side yard setbacks. Therefore, the proposed facility will meet the "B" setback requirements per	Yes⊠No □

5. Wireless Ordinance Consistency

By federal law, the County is prohibited from regulating the placement, construction and modification of personal wireless service facilities on the basis of the environmental effects of radio frequency (RF) emissions, if the facilities comply with the Federal Communication Commission (FCC) regulations concerning RF emissions. Therefore, County decision makers do not consider comments or information concerning potential health effects or other environmental effects when determining

whether to approve permits for cellular facilities. Also, staff does not require information from the Applicant concerning such effects from RF emissions associated with the Project. Information regarding potential health effects is available from the cellular providers upon request as required by the FCC

The County is preempted by the Federal Telecommunication Act from considering Electric Magnetic Radiation (EMR) when reviewing the proposed location of cellular facilities. Therefore, staff does not require information from the Applicant on potential health effects from EMR associated with the Project. Generally, this information is available from the cellular providers upon request as it is also required from the FCC.

Table E-3: Wireless Ordinance Consistency

Development Standard	Proposed/Provided	Complies?
Section 6985.C.2 of the Wireless Telecommunication Ordinance requires that the equipment accessory to a facility not exceed 10 feet in height unless a greater height is necessary to maximize architectural integration, and the facility is screened by landscaping.	The equipment does not exceed 10 ft in height.	Yes⊠No □
Section 6985.C.5 of the Wireless Telecommunication Ordinance prohibits the placement of a telecommunication tower or equipment in the front, rear, or side yard setback. Section 6985.C.6 of the Wireless Telecommunication Ordinance states that noise from any equipment supporting the facility shall meet the requirements of the County's Noise Ordinance on an average hourly basis.	The proposed wireless telecommunications facility and existing equipment enclosure are located outside all required setbacks including front, rear, and side yard No new noise-producing equipment or operational uses are proposed as part of the Project. The Project will not create a change in the existing noise environment and is therefore anticipated to comply with the County of San Diego Noise Ordinance Section(s)	Yes⊠No ☐ Yes⊠No ☐
Section 6985.C.11 of the Wireless Telecommunication Ordinance limits the term of a "high visibility" facility, depending on the valuation of the wireless facility.	36.404 The Project is considered a "high visibility" facility because the facility is in a residential zone. Since the proposed Project has a valuation of \$150,000, the ZAP has been conditioned to have a maximum term of 10 years.	Yes No 🗆

Section 6987.D of the Wireless	,	
Telecommunication Ordinance	Scenic Highway.	Yes⊠No □
states that sites visible from a		
Scenic Highway, as identified in		
the General Plan, shall be		
designed in such a manner as to		
avoid adverse visual impacts and		
does not permit the use of		
monopoles, lattice towers, or		
guyed towers.		

6. California Environmental Quality Act (CEQA) Compliance

The project has been reviewed for compliance with CEQA and the proposed project qualifies for a categorical exemption under CEQA Section 15301 (b). Section 15301 (b) exempts existing facilities with minor alterations to both public and private facilities with negligible expansion of existing use.

F. PUBLIC INPUT

At the time of application submittal and in accordance with Board Policy I-49, public notices were sent to property owners surrounding the project site until at least 20 different property owners were noticed within approximately 500 feet of the project site. No comments or concerns were received during the processing of the permit. Prior to the Zoning Administrator hearing, public notices were sent to a minimum of 20 property owners within approximately 500 feet of the project site.

G. LAKESIDE COMMUNITY PLANNING GROUP

On October 5, 2022, the Lakeside Community Planning Group (CPG) recommended the approval of the project without any conditions by a vote of 13-0-2 (Ayes- 13, Noes- 0, Absent- 2). The CPG 534 form is included in Attachment E.

H. STAFF RECOMMENDATIONS

Staff recommends that the Zoning Administrator take the following actions:

- 1. Approve PDS2022-ZAP-96-035W2, make the findings, and impose the requirements and conditions as set forth in the Form of Decision in Attachment B
- 2. Adopt the Environmental Findings included in Attachment D, which includes a finding that the project is exempt from further environmental review pursuant to §15301 of CEQA.

Report Prepared By:	Report Approved By:
Andrew Holtz, Project Manager	Vince Nicoletti, Director
619-458-2038	858-694-2962
Andrew.Holtz@sdcounty.ca.gov	Vince.Nicoletti@sdcounty.ca.gov
- 	

AUTHORIZED REPRESENTATIVE: ASHLEY SMITH, CHIEF

ATTACHMENTS:

Attachment A – Planning Documentation

Attachment B – Form of Decision approving PDS2022-ZAP-96-035W2

Attachment C – Environmental Findings

Attachment D – Public Documentation

Attachment E- Photo-Simulations, Geographical Service Area Maps, and Alternative Site Analysis

Attachment F – Ownership Disclosure Form

Attachment A Planning Documentation



ANCHOR/L600 MODIFICATION SITE ID: SD06045A SD045 HELIX WATER DISTRICT 13002 HIGHWAY 8 BUSINESS **EL CAJON, CA 92021**

SITE INFORMATION

PROPERTY OWNER:

LATITUDE

HELIX WATER DISTRICT 7811 UNIVERSITY AVE LA MESA, CA 91942 PH: (619) 466-0585

1441 MONTIEL RE

ESCONDIDO, CA 92026 LAT/LONG TYPE

32° 49' 34.70" N LONGITUDE: 116° 54' 52.79" W COUNTY OF SAN DIEGO ZONING JURISDICTION:

ZONING CLASSIFICATION: CURRENT USE: UNMANNED TELECOMMUNICATIONS FACILITY

ASSESSOR'S PARCEL NO.: 400-060-03

PROPOSED USE: UNMANNED TELECOMMUNICATIONS FACILITY

TYPE OF CONSTRUCTION: OCCUPANCY GROUP

PROJECT TEAM

REAL ESTATE PROJECT MANAGER: SMARTLINK 3300 IRVINE AVE, 300 IRVINE, CA 92660

ENGINEER: M SQUARED WIRELESS 1387 CALLE AVANZADO SAN CLEMENTE, CA 92673 CONTACT: VINCE VOSS
PHONE: (630) 220-8156
EMAIL: Vincent.Voss@smartlinkgroup.com CONTACT: MICHAEL MONTELLO PHONE: (619) 997-4012

1441 MONTIEL RD ESCONDIDO, CA 92026 CONTACT: PEDRO ABE PHONE: (858) 334-2128 EMAIL: pedro.abe@T-Mobile.com

VICINITY MAP

DRIVING DIRECTIONS

DIRECTIONS FROM SAN DIEGO INTERNATIONAL AIRPORT

- HEAD EAST ON N HARBOR DR TOWARD MCCAIN RD
 USE THE LEFT 3 LANES TO TURN LEFT ONTO W GRAPE ST
 USE THE RIGHT 2 LANES TO TAKE THE RAMP ONTO LS S
 MERGE ONTO LS S
 MERGE ONTO LS S
 TAKE EXIT 158 FOR CA-94 E/M L KING JR FWY
 TAKE THE CALIFORNIA 94 E/CALIFORNIA 125 N EXIT ON THE LEFT TOWARD LA
 MESALSPRING ST
- TAKE THE CALIFORNIA 94 E/GALIFUKNIA 120 N EATL ON MESA/SPRING ST MESA/SPRING ST KEEP LEFT AT THE FORK TO CONTINUE ON EXIT 9B, FOLLOW SIGNS FOR CA-125 INSANTEE TAKE EXIT 18B TO MERGE ONLO 1-8 E TAKE EXIT 20 FOR GREENFIELD DR TOWARD CREST USE THE LEFT 2 LANES TO TURN LEFT ONTO HWY 8 BUSINESS/GREENFIELD DR TURN RIGHT ONTO HWY 8 BUSINESS/E MAIN ST

SDC PDS RCVD 04-18-25

PROJECT DESCRIPTION

REMOVE (1) EXISTING MONOPOLE
REMOVE (1) EXISTING MONOPOLE
REMOVE (1) EXISTING T-MOBILE FRAME MOUNT FROM CHAIN LINK FENCE POSTS
REMOVE (2) EXISTING T-MOBILE FTAMS @ ANTENNAL EVEL
REMOVE (2) EXISTING T-MOBILE FTAMS @ ANTENNAL EVEL
REMOVE (2) EXISTING T-MOBILE FTAMS @ ANTENNAL EVEL
REMOVE (2) EXISTING T-MOBILE CASINETS @ EQUIPMENT AREA
REMOVE (1) EXISTING T-MOBILE CASINETS @ EQUIPMENT AREA
REMOVE (1) EXISTING T-MOBILE EXIST BLUTT @ EQUIPMENT AREA
REMOVE (6) EXISTING T-MOBILE EXIST BLUTT @ EQUIPMENT AREA
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RELOCATE (1) EXISTING T-MOBILE EXIST BLUTT & CASINET TO (N) 6160 @ EQUIPMENT AREA
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INSTALL (3) NEW T-MOBILE EXIST BLUTT & CASILET TRAYS
INSTALL (3) NEW T-MOBILE EXIST BLUTT & COUPMENT AREA
INSTALL (1) NEW T-MOBILE EXIST BLUTT & COUPMENT AREA
INSTALL (1) NEW T-MOBILE EXIST BLUTT & COUPMENT AREA
INSTALL (1) NEW T-MOBILE EXIST BLUTT & (N) 6160 CABINET @ EQUIPMENT AREA
INSTALL (2) NEW T-MOBILE EXIST BLUTT & (N) 6160 CABINET @ EQUIPMENT AREA
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INSTALL (1) NEW T-MOBILE EXES BOYLET & (N) 6160 CABINET @ EQUIPMENT AREA
INSTALL (1) NEW T-MOBILE EXES BOYLET & (R) 6160 CABINET & EQUIPMENT AREA
INSTALL (1) NEW T-MOBILE EXES BOYLET & (

RETS WILL BE CONTROLLED BY 4480 AND 4460 SEPARATELY UPGRADE AC POWER, IF NOT DONE ALREADY

GENERAL NOTES

THE FACILITY IS UNMANNED AND NOT FOR HUMAN HABITATION, HANDICAPPED ACCES REQUIREMENTS ARE NOT REQUIRED IN ACCORDANCE WITH THE 2022 CALIFORNIA BUILDING CODE. TECHNICIAN WILL VISIT THE STIE AS REQUIRED FOR ROUTINE MAINTENANCE. THE PROJECT WILL NOT STATE OF THE PROJECT WILL NOT SERVICE OF THE PROJECT WILL NOT POTABLE WATER, OR TRASH DISPOSAL IS REQUIRED AND NO COMMERCIAL SIGNAGE IS NEW.

ENGINEERING

ALL WORK AND MATERIALS SHALL BE PERFORMED AND INSTALLED IN ACCORDANCE WITH

- DI HORRITES.
 2022 CALIFORNIA BUILDING CODE
 CITY/COUNTY ORDINANCES
 BUILDING OFFICIALS & CODE ADMINISTRATORS (BOCA)
- 2022 CALIFORNIA MECHANICAL CODE 2022 CALIFORNIA FIRE CODE
- 2022 CALIFORNIA PLUMBING CODE

DO NOT SCALE DRAWINGS

SUBCONTRACTOR SHALL VERIFY ALL PLANS, EXISTING DIMENSIONS & FIELD CONDITIONS ON THE JOB SITE & SHALL IMMEDIATELY NOTIFY THE ENGINEER IN WRITING OF ANY DISCREPANCIES BEFORE PROCEEDING WITH THE WORK OR BE



DECLARATION OF RESPONSIBLE CHARGE

LOYALL A. WHARTON, REGISTERED PROFESSIONAL ENGINEER IN THE STATE OF CALIFORNIA, HAVE EXERCISED RESPONSIBLE CHARGE OVER THE WIRELESS DESIGN SHOWN ON THESE PLANS. THE WIRELESS DESIGN SHOWN ON THESE PLANS IS IN ACCORDANCE WITH CALIFORNIA BUILDING CODES. I UNDERSTAND THAT THE CITY OF EL CAJON DOES NOT DETERMINE WHETHER ALL ASPECTS OF CALIFORNIA BUILDING CODES HAVE BEEN INCORPORATED

RESPONSIBLE CHARGE OVER THE DESIGN OF THE PROJECT AS DEFINED IN SECTION 6703 OF THE BUSINESS AND PROFESSIONAL CODE, AND THE DESIGN IS CONSISTENT WITH CURRENT STANDARDS.

I UNDERSTAND THAT THE CHECK OF PROJECT DRAWINGS AND SPECIFICATIONS BY THE CITY OF EL CAJON AND HEL' WATER DISTRICT IS CONFINED TO A REVIEW ONLY AND DOES NOT RELIEVE ME, AS ENGINEER OF WORK, OF M'RESPONSIBILITIES FOR PROJECT DESIGN.

LOYALL A. WHARTON R.C.E. NO. C50547 EXP. 06-21-23

CONSTRUCTION DRAWING

IF USING 11"X17" PLOT, DRAWINGS WILL BE HALF SCALE

DRAWING INDEX SHEET NO: TITLE SHEET GN-1 A-1 SITE PLAN A-1.1 ENLARGED SITE PLAN A-2 EQUIPMENT LAYOU ANTENNA LAYOUT ELEVATIONS A-5 ELEVATIONS DETAILS D-2 DETAILS D-3 DETAILS GROUNDING DETAILS RF-1 CABLE LINE DIAGRAM UTILITY SITE PLAN & EQUIPMENT SITE DIAGRAM E-1

APPROVALS

SINGLE LINE DIAGRAM AND PANEL SCHEDULE

ELECTRICAL METER ROOM & ELECTRICAL NOTES

E-2

E-3

E-4

THE FOLLOWING PARTIES HEREBY APPROVE AND ACCEPT THESE DOCUMENTS & AUTHORIZE THE SUBCONTRACTOR TO PROCEED WITH THE CONSTRUCTION DESCRIBED HEREIN. ALL DOCUMENTS ARE SUBJECT TO REVIEW BY THE LOCAL BUILDING DEPARTMENT & MAY IMPOSE CHANGES OR MODIFICATIONS.

T-MOBILE RF ENGINEER:	DATE:
T-MOBILE OPERATIONS:	DATE:
SITE ACQUISITION:	DATE:
CONSTRUCTION MANAGER:	DATE:
PROPERTY OWNER:	DATE:
ZONING:	DATE:
PROJECT MANAGER:	DATE:







DRAWN BY: CHECKED BY

5	01/31/2025	100% CD'S FOR SUBMITTAL
4	01/03/2025	100% CD'S FOR SUBMITTAL
3	04/06/2023	100% CD'S PER NEW DESIGN
2	03/22/2023	100% CD'S FOR SUBMITTAL
1	01/04/2023	100% ZD'S PER JX COMMENTS
0	05/12/2022	100% ZD'S FOR REVIEW
Α	04/13/2022	90% ZD'S FOR REVIEW
REV	DATE	DESCRIPTION

IT IS A VIOLATION OF LAW FOR ANY PERSON, UNLESS THEY ARE ACTING UNDER THE DIRECTION OF A LICENST PROFESSIONAL ENGINEER, TO ALTER THIS DOCUMENT.

ANCHOR/L600 MODIFICATION SITE ID: SD06045A SD045 HELIX WATER DISTRICT 13002 HIGHWAY 8 BUSINESS WATER TANK

SHEET TITLE

TITLE SHEET

T-1

ZAP96-035W2

GENERAL CONSTRUCTION NOTES:

1. FOR THE PURPOSE OF CONSTRUCTION DRAWINGS, THE FOLLOWING DEFINITIONS SHALL APPLY:
GENERAL CONTRACTOR - GENERAL CONTRACTOR
SUBCONTRACTOR - CONTRACTOR (CONSTRUCTION)

- ALL SITE WORK SHALL BE COMPLETED AS INDICATED ON THE DRAWINGS AND T-MOBILE PROJECT SPECIFICATIONS. GENERAL CONTRACTOR AND SUBCONTRACTOR SHALL VISIT THE SITE AND SHALL FAMILIARIZE HIMSELF WITH ALL CONDITIONS AFFECTING THE PROPOSED WORK AND SHALL MAKE PROVISIONS, GENERAL CONTRACTOR AND CONDITIONS AFFECTING THE PROPOSED WORK AND SHALL MAKE PROVISIONS, GENERAL CONTRACTOR AND SUBCONTRACTOR SHALL BE RESPONSIBLE FOR FAMILLARIZING HIMSELF WITH ALL CONTRACT DOCUMENTS, FIELD CONDITIONS, DIMENSIONS, AND CONFIRMING THAT THE WORK MAY BE ACCOMPLISHED AS SHOWN PRIOR TO PROCEEDING WITH CONSTRUCTION. ANY DISCREPANCIES SHALL BE BROUGHT TO THE ATTENTION OF THE ARCHITECT/ENGINEER PRIOR TO THE COMMENCEMENT OF WORK.

 ALL MATERIALS FURNISHED AND INSTALLED SHALL BE IN STRICT ACCORDANCE WITH ALL APPLICABLE CODES, REGULATIONS, AND ORDINANCES, GENERAL CONTRACTOR SHALL ISSUE ALL APPROPRIATE NOTICES AND COMPLY
- WITH ALL T-MOBILE, ORDINANCES, RULES, REGULATIONS, AND LAWFUL ORDERS OF ANY PUBLIC AUTHORIT
- WITH ALL T-MOBILE, ORDINANCES, RULES, REGULATIONS, AND LAWFUL ORDERS OF ANY PUBLIC AUTHORITY REGARDING THE PERFORMANCE OF WORK.

 5. ALL WORK CARRIED OUT SHALL COMPLY WITH ALL APPLICABLE MUNICIPAL AND UTILITY COMPANY SPECIFICATIONS AND LOCAL JURISDICTIONAL CODES, ORDINANCES, AND APPLICABLE REGULATIONS.

 6. UNLESS NOTED OTHERWISE, THE WORK SHALL INCLUDE FURNISHING MATERIALS, EQUIPMENT, APPURTENANCES, AND LABOR NECESSARY TO COMPLETE ALL INSTALLATIONS AS INDICATED ON THE DRAWINGS.
- AND LABOR NECESSARY TO COMPLETE ALL INSTALLATIONS AS INDICATED ON THE DRAWINGS.

 PLANS ARE NOT TO BE SCALED. THESE PLANS ARE INTENDED TO BE A DIAGRAMMATIC OUTLINE ONLY UNLESS
 OTHERWISE NOTED, DIMENSIONS SHOWN ARE TO FINISH SURFACES UNLESS OTHERWISE NOTED, SPACING BETWEEN
 EQUIPMENT IS THE MINIMUM REQUIRED CLEARANCE. THEREFORE, IT IS CRITICAL TO FIELD VERIFY DIMENSIONS,
 SHOULD THERE BE ANY QUESTIONS REGARDING THE CONTRACT DOCUMENTS, THE SUBCONTRACTOR SHALL BE
 RESPONSIBLE FOR OBTAINING A CLARIFICATION FROM THE ARCHITECT/ENGINEER PRIOR TO PROCEEDING WITH THE
 WORK, DETAILS ARE INTENDED TO SHOWN DESIGN INTENT. MODIFICATIONS MAY BE REQUIRED TO SUIT JOB
 DIMENSIONS OR CONDITIONS AND SUCH MODIFICATIONS SHALL BE INCLUDED AS PART OF WORK AND PREPARED BY THE ARCHITECT/ENGINEER PRIOR TO PROCEEDING WITH WORK

- THE ARCHITECT/ENGINEER PRIOR TO PROCEEDING WITH WORK

 8. THE SUBCONTRACTOR SHALL INSTALL ALL EQUIPMENT AND MATERIALS IN ACCORDANCE WITH MANUFACTURER'S
 RECOMMENDATIONS UNLESS SPECIFICALLY STATED OTHERWISE.

 9. IF THE SPECIFIED EQUIPMENT CANNOT BE INSTALLED AS SHOWN ON THESE DRAWINGS. THE SUBCONTRACTOR
 SHALL PROPOSE AN ALTERNATIVE SPACE FOR APPROVAL BY THE ARCHITECT/ENGINEER PRIOR TO PROCEEDING,
 10. GENERAL CONTRACTOR SHALL BE RESPONSIBLE FOR THE SAFETY OF WORK AREA, ADJACENT AREAS AND BUILDING
 OCCUPANTS THAT ARE LIKELY TO BE AFFECTED BY THE WORK UNDER THIS CONTRACT, WORK SHALL CONFORM TO
 ALL OSALD BEDILBERENTS AND THE LOCAL INDEPCHAND.
- OCCUPANTS THAT ARE LIKELY TO BE AFFECTED BY THE WORK UNDER THIS CONTRACT, WORK SHALL CONFORM TO ALL OSHA REQUIREMENTS AND THE LOCAL JURISDICTION.

 11. GENERAL CONTRACTOR SHALL ED DONE IN A WORK AND SCHEDULE WORK ACTIVITIES WITH OTHER DISCIPLINES. CONFORM TO ACCORDANCE WITH APPLICABLE CODES AND THE BEST ACCEPTED PRACTICE. ALL MEMBERS SHALL BE LAID PLUMB AND TRUE AS INDICATED ON THE DRAWINGS.

 13. SEAL PENETRATIONS THROUGH FIRE RATED AREAS WITH UL LISTED MATERIALS APPROVED BY LOCAL JURISDICTION.
- SUBCONTRACTOR SHALL KEEP AREA CLEAN, HAZARD FREE, AND DISPOSE OF ALL DEBRIS.
- SUBCONTRACTOR SHALL KEEP AREA CLEAN, HAZARD FREE, AND DISPOSE OF ALL DEBRIS.
 14. WORK PREVIOUSLY COMPLETED IS REPRESENTED BY LIGHT SHADED LINES AND NOTES. THE SCOPE OF WORK FOR THIS PROJECT IS REPRESENTED BY DARK SHADED LINES AND NOTES. SUBCONTRACTOR SHALL NOTIFY THE GENERAL CONTRACTOR OF ANY (E) CONDITIONS THAT DEVIATE FROM THE DRAWINGS PRIOR TO THE BEGINNING
- CONSTRUCTION. 15. SUBCONTRACTOR SHALL PROVIDE WRITTEN NOTICE TO THE CONSTRUCTION MANAGER 48 HOURS PRIOR TO
- COMMENCEMENT OF WORK.

 16. THE SUBCONTRACTOR SHALL PROTECT (E) IMPROVEMENTS, PAVEMENTS, CURBS, LANDSCAPING AND STRUCTURES.
- ANY DAMAGED PART SHALL BE REPAIRED AT SUBCONTRACTOR'S EXPENSE TO THE SATISFACTION OF THE OWNER.

 17. THE SUBCONTRACTOR SHALL CONTACT UTILITY LOCATING SERVICES PRIOR TO THE START OF CONSTRUCTION.

 18. GENERAL CONTRACTOR SHALL COORDINATE AND MAINTAIN ACCESS FOR ALL TRADES AND SUBCONTRACTORS TO
- THE SITE AND/OR BUILDING.

 19. THE GENERAL CONTRACTOR SHALL BE RESPONSIBLE FOR SECURITY OF THE SITE FOR THE DURATION OF

- 19. THE GENERAL CONTRACTOR SHALL BE RESPONSIBLE FOR SECURITY OF THE STIE FOR THE DURATION OF CONSTRUCTION UNTIL JOB COMPLETION.

 20. THE GENERAL CONTRACTOR SHALL MAINTAIN IN GOOD CONDITION ONE COMPLETE SET OF PLANS WITH ALL REVISIONS, ADDENDA, AND CHANGE ORDERS ON THE PREMISES AT ALL TIMES.

 21. THE GENERAL CONTRACTOR AND SUBCONTRACTOR SHALL PROVIDE PORTABLE FIRE EXTINGUISHERS WITH A RATING OF NOT LESS THAN 2-A OT 2-A:10-B:C AND SHALL BE WITHIN 25 FEET OF TRAVEL DISTANCE TO ALL PORTIONS OF WHERE THE WORK IS BEING CONDITIONED CONTRICTION.

 22. ALL (E) ACTIVE SEWER, WATER, GAS, ELECTRIC, AND OTHER UTILITIES SHALL BE PROTECTED DURING.
- ALL (E) ACTIVE SEWER, WATER, GAS, ELECTRIC, AND OTHER UTILITIES SHALL BE RELOCATED AS DIRECTED BY THE
 ARCHITECT/ENGINEER. EXTREME CAUTION S THE WORK, SHALL BE RELOCATED AS DIRECTED BY THE
 ARCHITECT/ENGINEER. EXTREME CAUTION SHOULD BE USED BY THE SUBCONTRACTOR WHEN EXCAVATING OR
 DRILLING PIERS AROUND OR NEAR UTILITIES, SUBCONTRACTOR SHALL PROVIDE SAFTY TRAINING FOR THE
 WORKING CREW. THIS SHALL INCLUDE BUT NOT BE LIMITED TO A) FALL PROTECTION, B) CONFINED SPACE, C)
 ELECTRICAL SAFETY, D) TRENCHING & EXCAVATION.
 ALL (E) INACTIVE SEWER, WATER, GAS, ELECTRIC, AND OTHER UTILITIES, WHICH INTERFERE WITH THE EXECUTION OF
 THE WORK OF THE PROPERTY OF ADDITIONAL PROCEDURE OF THE PROPERTY OF THE P
- 23. ALL (E) INACITIES SEWER, WATER, GAS, ELECTRIC, AND OTHER OTH INTERFERE WITH THE EXECUTION OF THE WORK, SHALL BE REMOVED, CAPPED, PLUGGED OR OTHERWISE DISCONNECTED AT POINTS WHICH WILL NOT INTERFERE WITH THE EXECUTION OF THE WORK, AS DIRECTED BY THE RESPONSIBLE ARCHITECT/ENGINEER, AND SUBJECT TO THE APPROVAL OF THE OWNER AND/OR LOCAL UTILITIES.

 24. THE AREAS OF THE OWNER'S PROPERTY DISTURBED BY THE WORK AND NOT COVERED BY THE TOWER, EQUIPMENT OR DRIVEWAY, SHALL BE GRADED TO A UNIFORM SLOPE, AND STABILIZED TO PREVENT EROSION,

 25. SUBCONTRACTOR SHALL MINIMIZE DISTURBANCE TO THE (E) SITE DURING CONSTRUCTION, EROSION CONTROL
- MEASURES, IF REQUIRED DURING CONSTRUCTION, SHALL BE IN CONFORMANCE WITH THE FEDERAL AND LOCAL JURISDICTION FOR EROSION AND SEDIMENT CONTROL.
- JURISDICTION FOR EROSION AND SEDIMENT CONTROL.

 26. NO FILL OR EMBANKMENT MATERIAL SHALL BE PLACED ON FROZEN GROUNDING, FROZEN MATERIALS, SNOW OR ICE SHALL NOT BE PLACED IN ANY FILL OR EMBANKMENT.

 27. THE SUBGRADE SHALL BE BROUGHT TO A SMOOTH UNIFORM GRADE AND COMPACTED TO 95 PERCENT STANDARD PROCTOR DENSITY UNDER PAVEMENT AND STRUCTURES AND 80 PERCENT STANDARD PROCTOR DENSITY IN OPEN SPACE, ALL TRENCHES IN PUBLIC RIGHT OF WAY SHALL BE BACKFILLED WITH FLOWABLE FILL OR OTHER MATERIAL
- SPACE, ALL TRENCHES IN PUBLIC RIGHT OF WAY SHALL BE BACKFILLED WITH FLOWABLE FILL OR OTHER MATERIAL PRE-APPROVED BY THE LOCAL JURISDICTION.

 28. ALL NECESSARY RUBBISH, STUMPS, DEBRIS, STICKS, STONES, AND OTHER REFUSE SHALL BE REMOVED FROM THE SITE AND DISPOSED OF IN A LAWFUL MANNER.

 29. ALL BROCHURES, OPERATING AND MAINTENANCE MANUALS, CATALOGS, SHOP DRAWINGS, AND OTHER DOCUMENTS SHALL BE TURNED OVER TO THE GENERAL CONTRACTOR AT COMPLETION OF CONSTRUCTION AND PRIOR TO ADMENS.
- 30. SUBCONTRACTOR SHALL SUBMIT A COMPLETE SET OF AS-BUILT REDLINES TO THE GENERAL CONTRACTOR UPON COMPLETION OF PROJECT AND PRIOR TO FINAL PAYMENT
- 31. SUBCONTRACTOR SHALL LEAVE PREMISES IN A CLEAN CONDITION.
 32. THE PROPOSED FACILITY WILL BE UNMANNED AND DOES NOT REQUIRE POTABLE WATER OR SEWER SERVICE, AND IS NOT FOR HUMAN HABITAT (NO HANDICAP ACCESS REQUIRED).
 33. OCCUPANCY IS LIMITED TO PERIODIC MAINTENANCE AND INSPECTION, APPROXIMATELY 2 TIMES PER MONTH, BY
- T-MOBILE TECHNICIANS.
- 34. NO OUTDOOR STORAGE OR SOLID WASTE CONTAINERS ARE PROPOSED.
- NO OUTDOOR STORAGE OR SOLID WASTE CONTAINERS ARE PROPOSED.
 ALL MATERIAL SHALL BE FURNISHED AND WORK SHALL BE PERFORMED IN ACCORDANCE WITH THE LATEST REVISION
 T-MOBILE GROUNDING STANDARD "TECHNICAL SPECIFICATION FOR CONSTRUCTION OF GSM/GPRS WIRELESS SITES"
 AND "TECHNICAL SPECIFICATION FOR FACILITY GROUNDING". IN CASE OF A CONFLICT BETWEEN THE CONSTRUCTION
 SPECIFICATION AND THE DRAWINGS. THE DRAWINGS SHALL GOVERN.
 SUBCONTRACTORS SHALL BE RESPONSIBLE FOR OBTAINING ALL PERMITS AND INSPECTIONS COUNTED FOR CONSTRUCTION.
- CONSTRUCTION. IF SUBCONTRACTOR CANNOT OBTAIN A PERMIT, THEY MUST NOTIFY THE GENERAL CONTRACTOR 37 SUBCONTRACTOR SHALL REMOVE ALL TRASH AND DEBRIS FROM THE SITE ON A DAILY BASIS.
- SUBCONTING TO STAILS TERMINE ALL TRANSHAND DEBTIS FROM THE SITE OWN DAILT BASIS.
 INFORMATION SHOWN ON THESE DRAWINGS WAS OBTAINED FROM SITE VISITS AND/OR DRAWINGS PROVIDED BY THE SITE OWNER. CONTRACTORS SHALL NOTIFY THE ENGINEER OF ANY DISCREPANCIES PRIOR TO ORDERING MATERIAL OR PROCEEDING WITH CONSTRUCTION.
 NO WHITE STROBIC LIGHTS ARE PERMITTED. LIGHTING IF REQUIRED, WILL MEET FAA STANDARDS AND
- REQUIREMENTS.
- 40. ALL COAXIAL CABLE INSTALLATIONS TO FOLLOW MANUFACTURER'S INSTRUCTIONS AND RECOMMENDATIONS 41. NO NOISE, SMOKE, DUST, OR VIBRATIONS WILL RESULT FROM THIS FACILITY. (DISREGARD THIS NOTE IF THIS SITE HAS
- A GENERATOR)

 A GENERATOR)

 A GENERATOR

 A G

- ELECTRICAL NOTES:

 1. ELECTRICAL CONTRACTOR SHALL SUPPLY AND INSTALL ANY/ALL ELECTRICAL WORK INDICATED, ANY/ALL CONSTRUCTION SHALL BE IN ACCORDANCE WIDRAWINGS AND ANY/ALL APPLICABLE SPECIFICATIONS. IF ANY PROBLEMS ARE ENCOUNTERED BY COMPLYING WITH THESE REQUIREMENTS, CONTRACTOR SHALL NOTIFY 'CONSTRUCTION MANAGER' AS SOON AS POSSIBLE, AFTER THE DISCOVERY OF THE PROBLEMS, AND SHALL NOT PROCEED WITH THAT PORTION OF WORK, UNTIL THE 'CONSTRUCTION MANAGER' HAS DIRECTED THE CORRECTIVE ACTIONS TO BE TAKEN.
- 2. ELECTRICAL CONTRACTOR SHALL VISIT THE JOB SITE AND FAMILIARIZE HIMSELF WITH ANY/ALL CONDITIONS AFFECTING ELECTRICAL AND COMMUNICATION INSTALLATION AND MAKE PROVISIONS AS TO THE COST THEREOF, ALL (E) CONDITIONS OF ELECTRICAL EQUIP. LIGHT FIXTURES, ETC., THAT ARE PART OF THE FINAL SYSTEM, SHALL BE VERIFIED BY THE CONTRACTOR, PRIOR TO THE SUBMITTING OF HIS BID, FAILURE TO COMPLY WITH HIS PARAGRAPH WILL IN NO WAY RELIEVE CONTRACTOR OF PERFORMING ALL WORK NECESSARY FOR A COMPLETE AND WORKING
- 3. ALL WORK SHALL BE PERFORMED IN ACCORDANCE WITH THE LATEST EDITION OF THE NEC AND ALL CODES AND LOCAL ORDINANCES OF THE LOCAL POWER & TELEPHONE COMPANIES HAVING JURISDICTION AND SHALL INCLUDE BUT NOT BE LIMITED TO:

- I NOT be LIMITED TO:

 C NATIONAL FIRE CODES

 A. UL UNDERWRITERS LABORATORIES

 B. NEC NATIONAL ELECTRICAL CODE

 C. NEMA NATIONAL ELECTRICAL MANUFACTURERS ASSOC. OSHA - OCCUPATIONAL SAFETY AND HEALTH ACT
- SBC STANDARD BUILDING CODE

- E. SBC STANDARD BUILDING CODE

 4. DO NOT SCALE ELECTRICAL DRAWINGS, REFER TO SITE PLANS AND ELEVATIONS FOR EXACT LOCATIONS OF ALL

 EQUIPMENT, AND CONFIRM WITH 'CONSTRUCTION MANAGER' ANY SIZES AND LOCATIONS WHEN NEEDED.

 5. (E) SERVICES: CONTRACTOR SHALL NOT INTERRUPT (E) SERVICES WITHOUT WRITTEN PERMISSION OF THE OWNER.

 6. CONTRACTOR SHALL PAY FOR ANYJALL PERMITS, FEES, INSPECTIONS AND TESTING. CONTRACTOR IS TO OBTAIN
 PERMITS AND APPROVED SUBMITTALS PRIOR TO THE WORK BEGINNING OR ORDERING EQUIPMENT.
- PERMITS AND APPROVED SUBMITTALS PRIOR TO THE WORK BEGINNING OR ORDERING EQUIPMENT. THE TERM "PROVIDE" USED IN CONSTRUCTION DOCUMENTS AND SPECIFICATIONS, INDICATES THAT THE CONTRACTOR SHALL FURNISH AND INSTALL.

 CONTRACTOR SHALL CONFIRM WITH LOCAL UTILITY COMPANY ANY/ALL REQUIREMENTS SUCH AS THE: LUG SIZE RESTRICTIONS, CONDUIT ENTRY, SIZE OF TRANSFORMERS, SCHEDULED DOWNTIME FOR THE OWNERS'

 CONFIRMATION, ETC... ANY/ALL CONFLICTS SHALL BE BROUGHT TO THE ATTENTION OF THE CONSTRUCTION MANAGERY BRIGGORY OF THE OWNERS'

 CONFIRMATION, ETC... ANY/ALL CONFLICTS SHALL BE BROUGHT TO THE ATTENTION OF THE CONSTRUCTION MANAGERY BRIGGORY OF THE OWNERS' MANAGER, PRIOR TO BEGINNING ANY WORK.
 MINIMUM WIRE SIZE SHALL BE #12 AWG, NOT INCLUDING CONTROL WIRING, UNLESS NOTED OTHERWISE. ALL

- MINIMUM WIRE SIZE SHALL BE #12 AWG, NOT INCLUDING CONTROL WIRING, INLESS NOTED OTHERWISE, ALL
 CONDUCTORS SHALL BE COPPER WITH THYM INSULATION.
 OUTLET BOXES SHALL BE PRESSED STEEL IN DRY LOCATIONS, CAST ALLOY WITH THREADED HUBS IN WET/DAMP
 LOCATIONS AND SPECIAL ENCLOSURES FOR OTHER CLASSIFIED AREAS.
 IT IS NOT THE INTENT OF THESE PLANS TO SHOW EVERY MINOR DETAIL OF THE CONSTRUCTION. CONTRACTOR IS
 EXPECTED TO FURNISH AND INSTALL ALL ITEMS FOR A COMPLETE ELECTRICAL SYSTEM AND PROVIDE ALL
 REQUIREMENTS FOR THE EQUIPMENT TO BE PLACED IN PROPER WORKING ORDER.
- 12. ELECTRICAL SYSTEM SHALL BE AS COMPLETELY AND EFFECTIVELY GROUNDED, AS REQUIRED BY SPECIFICATIONS. SET FORTH BY T-MOBILE
- SET FORTH BY T-MOBILE.

 13. ALL WORK SHALL BE PERFORMED BY A LICENSED ELECTRICAL CONTRACTOR IN A FIRST CLASS, WORKMANLIKE MANNER. THE COMPLETED SYSTEM SHALL BE FULLY OPERATIVE AND SUBJECT TO REGULATORY INSPECTION AND APPROVAL BY CONSTRUCTION MANAGER.

 14. ALL WORK SHALL BE COORDINATED WITH OTHER TRADES TO AVOID INTERFERENCE WITH THE PROGRESS OF
- CONSTRUCTION.
- 15. CONTRACTOR SHALL GUARANTEE ANY/ALL MATERIALS AND WORK FREE FROM DEFECTS FOR A PERIOD OF NOT LESS
- THAN ONE YEAR FROM DATE OF ACCEPTANCE.

 THE CORRECTION OF ANY DEFECTS SHALL BE COMPLETED WITHOUT ANY ADDITIONAL CHARGE AND SHALL INCLUDE
 THE REPLACEMENT OR THE REPAIR OF ANY OTHER PHASE OF THE INSTALLATION, WHICH MAY HAVE

 BEEN
- DAMAGED THEREIN.

 17. ADEQUATE AND REQUIRED LIABILITY INSURANCE SHALL BE PROVIDED FOR PROTECTION AGAINST PUBLIC LOSS AND ANY/ALL PROPERTY DAMAGE FOR THE DURATION OF WORK
- 18. PROVIDE AND INSTALL CONDUIT, CONDUCTORS, PULL WIRES, BOXES, COVER PLATES AND DEVICES FOR ALL OUTLETS
- DITCHING AND BACK FILL: CONTRACTOR SHALL PROVIDE FOR ALL UNDERGROUND INSTALLED CONDUIT AND/OR
 CABLES INCLUDING EXCAVATION AND BACKFILLING AND COMPACTION. REFER TO NOTES AND REQUIREMENTS
- 'EXCAVATION, AND BACKFILLING.
 20. MATERIALS, PRODUCTS AND EQUIPMENT, INCLUDING ALL COMPONENTS THEREOF, SHALL BE (N) AND SHALL APPEAR ON THE LIST OF U.L. APPROVED ITEMS AND SHALL MEET OR EXCEED THE REQUIREMENTS OF THE NEC. NEMA AND
- IECE.

 21. CONTRACTOR SHALL SUBMIT SHOP DRAWINGS OR MANUFACTURES CATALOG INFORMATION OF ANY/ALL LIGHTING FIXTURES, SWITCHES AND ALL OTHER ELECTRICAL ITEMS FOR APPROVAL BY THE CONSTRUCTION MANAGER PRIOF TO INSTALLATION.
- 22. ANY CUTTING OR PATCHING DEEMED NECESSARY FOR ELECTRICAL WORK IS THE ELECTRICAL CONTRACTORS ANY COLLING OF PATCHING DEEMED NECESSARY FOR ELECTRICAL WORK IS THE ELECTRICAL CONTRACTIONS
 RESPONSIBILITY AND SHALL BE INCLUDED IN THE COST FOR WORK AND PERFORMED TO THE SATISFACTION OF THE
 'CONSTRUCTION MANAGER' UPON FINAL ACCEPTANCE.
 THE ELECTRICAL CONTRACTOR SHALL LABEL ALL PANELS WITH ONLY TYPEWRITTEN DIRECTORIES. ALL ELECTRICAL
 WIRING SHALL BE THE RESPONSIBILITY OF THE ELECTRICAL CONTRACTOR.
 DISCONNECT SWITCHES SHALL BE H.P. RATED HEAVY-DUTY, QUICK-MAKE AND QUICK-BREAK ENCLOSURES, AS
- REQUIRED BY EXPOSURE TYPE.
- 25. ALL CONNECTIONS SHALL BE MADE WITH A PROTECTIVE COATING OF AN ANTI-OXIDE COMPOUND SUCH AS "NO-OXIDE A" BY DEARBORNE CHEMICAL CO. COAT ALL WIRE SURFACES BEFORE CONNECTING. EXPOSED COPPER SURFACES
- A 6 I DEMAGNIC CHEMICAL CULCOUT ALWINE SUFFACES BEFORE COMMENTALES. BAYENGED COPPER SUFFACES, INCLUDING GROUND BARS, SHALL BE TREATED NO SUBSTITUTIONS.

 RACEWAYS: CONDUIT SHALL BE SCHEDULE 40 PVC MEETING OR EXCEEDING NEMA TC2 1990. CONTRACTOR SHALL BLUG AND CAP EACH END OF SPARE AND EMPTY CONDUITS AND PROVIDE TWO SEPARATE PULL STRINGS 200 LBS TEST POLYETHYLENE CORD. ALL CONDUIT BENDS SHALL BE A MINIMUM OF 2 FT. RADIUS, RGS CONDUITS WHEN SPECIFIED, SHALL MEET UL-6 FOR GALVANIZED STEEL. ALL FITTINGS SHALL BE SUITABLE FOR USE WITH THREADED
- SPECIFIED, SHALL MEET LICE FOR GALVANIZED STEEL, ALL HIT INGS SHALL BE SUITABLE FOR USE WITH THREADED RIGID CONDUIT. COAT ALL THREADS WITH 'BRITE ZINC' OR 'GOLD GALV'.

 27. SUPPORT OF ALL ELECTRICAL WORK SHALL BE AS REQUIRED BY NEC.

 28. CONDUCTORS: CONTRACTOR SHALL USE 98% CONDUCTIVITY COPPER WITH TYPE THWN INSULATION, 800 VOLT, COLOR CODED. USE SOLID CONDUCTORS FOR WIRE UP TO AND INCLUDING NO. 8 AWG. USE STRANDED CONDUCTORS FOR WIRE UP TO AND INCLUDING NO. 8 AWG. USE STRANDED CONDUCTORS FOR WIRE ABOVE NO. 8 AWG.

 29. CONNECTORS FOR POWER CONDUCTORS: CONTRACTOR SHALL USE PRESSURE TYPE INSULATED TWIST-ON.
- CONNECTORS FOR NO. 10 AWG AND SMALLER, USE SOLDERLESS MECHANICAL TERMINAL LUGS FOR NO. 8 AWG AND
- 30. SERVICE: 240/120V, SINGLE PHASE, 3 WIRE CONNECTION AVAILABLE FROM UTILITY COMPANY. OWNER OR OWNERS
- GENTION. 249/120V, SINGLE PHASE, 3 WIRE CONNECTION AVAILABLE FROM UTILITY COMPANY. OWNER OR OWNE AGENT WILL APPLY FOR POWER. 31. TELEPHONE SERVICE: CONTRACTOR SHALL PROVIDE EMPTY CONDUITS WITH PULL STRINGS AS INDICATED ON DRAWINGS.
- 32. ELECTRICAL AND TELCO RACEWAYS TO BE BURIED A MINIMUM OF 2' DEPTH.
- 33. CONTRACTOR SHALL PLACE TWO LENGTHS OF WARNING TAPE AT A DEPTH OF 12" BELOW GROUND AND DIRECTLY ABOVE ELECTRICAL AND TELCO SERVICE CONDUITS. CAUTIONS TAPE TO READ "CAUTION BURIED ELECTRIC" OR
- 34. ALL BOLTS SHALL BE STAINLESS STEEL

SPECIAL INSPECTION

- CONTRACTOR SHALL PROVIDE REQUIRED SPECIAL INSPECTIONS PERFORMED BY AN INDEPENDENT INSPECTOR, APPROVED BY CARRIER AND THE GOVERNING JURISDICTION, AS REQUIRED BY CHAPTER 17 OF THE INTERNATIONAL BUILDING CODE FOR THE FOLLOWING:
 - NG CODE FOR THE FOLLOWING: A. PERIODIC FOR HIGH STRENGTH BOLT INSTALLATIONS (IF UTILIZED) B. PERIODIC/CONTINUOUS FOR FIELD WELDING (IF LITH IZED)
- PROVIDES SPECIAL INSPECTIONS FOR THE OTHER ITEMS NOTED ON DRAWINGS TO CONFIRM COMPLIANCE WITH CONTRACT DOCUMENTS.
 STEEL FABRICATION SHALL BE DONE ON THE PREMISES OF A FABRICATOR REGISTERED AND APPROVED TO STEED FABRICATION SHALL BE DONE ON THE PREMISES OF A FABRICATOR REGISTERED AND APPROVED TO STEED FABRICATOR REGISTERED AND APPROVED TO
- PERFORM SUCH WORK WITHOUT SPECIAL INSPECTION.

 4. SPECIAL INSPECTION IS NOT REQUIRED FOR WORK OF A MINOR NATURE OR AS WARRANTED BY CONDITIONS IN THE JURISDICTION AS APPROVED BY THE BUILDING OFFICIAL. THUS, SPECIAL INSPECTION ITEMS ABOVE MAY BE WAIVED
- AS DEEMED APPROPRIATE BY THE BUILDING OFFICIAL. THOS, SPECIAL INSPECTION ITEMS ABOVE MAT BE W. AS DEEMED APPROPRIATE BY THE BUILDING OFFICIAL.

 5. THE SPECIAL INSPECTOR SHALL PROVIDE A COPY OF THE REPORT TO THE OWNER, ARCHITECT, STRUCTURAL ENGINEER, CONTRACTOR AND BUILDING OFFICIAL.

 6. STRUCTURAL OBSERVATION NOT REQUIRED.

- GROUNDING NOTES:
 1. COMPRESSION CONNECTIONS (2), 2 AWG BARE TINNED SOLID COPPER CONDUCTORS TO GROUNDING BAR, ROUTE
- COMPRESSION CONNECTIONS (2), 20 WE SARE HINNED SOLID OFFER CONDUCTORS TO GROUNDING BAR, ROUTE
 CONDUCTORS TO BURIED GROUNDING RING AND PROVIDE PARALLEL EXOTHERMIC WELD.

 ELECTRICAL CONTRACTOR SHALL USE PERMANENT MARKER TO DRAW THE LINES BETWEEN EACH SECTION AND LABEL EACH
 SECTION (P) "A," "IN," "T) WITH "I HIGH LETTERS.

 3. ALL HARDWARE 18-8 STAINLESS STEEL, INCLUDING LOCK WASHERS, COAT ALL SURFACES WITH AN ANTI-OXIDANT COMPOUND.
- BEFORE MATING. ALL HARDWARE SHALL BE STAINLESS STEEL 3/8 INCH DIAMETER OR LARGER
- 4. FOR GROUND BOND TO STEEL ONLY: INSERT A CADMIUM FLAT WASHER BETWEEN LUG AND STEEL. COAT ALL SURFACES WITH AN ANTI-OXIDANT COMPOUND REFORE MATING
- WITH AN ANTI-DIMONION COMPOUND BEFORE MATING.
 NUT & WASHER SHALL BE PLACED ON THE FRONT SIDE OF THE GROUNDING BAR AND BOLTED ON THE BACK SIDE,
 NUMBER OF GROUNDING BARS MAY VARY DEPENDING ON THE TYPE OF TOWER, ANTENNA LOCATION, AND CONNECTION
 ORIENTATION, PROVIDE AS REQUIRED.
 WHEN THE SCOPE OF WORK REQUIRES THE ADDITION OF A GROUNDING BAR TO AN (E) TOWER, THE SUBCONTRACTOR SHALL
- OBTAIN APPROVAL FROM THE TOWER OWNER PRIOR TO MOUNTING THE GROUNDING BAR TO THE TOWER.

 ALL ELECTRICAL AND GROUNDING AT THE CELL SITE SHALL COMPLY WITH THE NATIONAL ELECTRICAL CODE (NEC), NATIONAL FIRE PROTECTION ASSOCIATION (NFPA) 780 (LATEST EDITION), AND MANUFACTURER.

SITE WORK & DRAINAGE

PART 1 - GENERAL

CLEARING, GRUBBING, STRIPPING, EROSION CONTROL, SURVEY, LAYOUT, SUBGRADE PREPARATION AND FINISH GRADING AS

- DOT (STATE DEPARTMENT OF TRANSPORTATION STANDARD SPECIFICATIONS FOR HIGHWAY CONSTRUCTION-CURRENT EDITION).
- ASTM (AMERICAN SOCIETY FOR TESTING AND MATERIALS)

- 1.2 INSPECTION AND TESTING:
 A. FIELD TESTING OF EARTHWORK COMPACTION AND CONCRETE CYLINDERS SHALL BE PERFORMED BY SUBCONTRACTORS INDEPENDENT TESTING LAB. THIS WORK TO BE COORDINATED BY THE SUBCONTRACTOR.
- ALL WORK SHALL BE INSPECTED AND RELEASED BY THE GENERAL CONTRACTOR WHO SHALL CARRY OUT THE GENERAL INSPECTION OF THE WORK WITH SPECIFIC CONCERN TO PROPER PERFORMANCE OF THE WORK AS SPECIFIED AND/OR CALLED FOR ON THE DRAWINGS. IT IS THE SUBCONTRACTOR'S RESPONSIBILITY TO REQUEST TIMELY INSPECTIONS PRIOR TO PROCEEDING WITH FURTHER WORK THAT WOULD MAKE PARTS OF WORK INACCESSIBLE OR DIFFICULT TO INSPECT.

- 1.3 SITE MAINTENANCE AND PROTECTION:
 A. PROVIDE ALL NECESSARY JOB SITE MAINTENANCE FROM COMMENCEMENT OF WORK UNTIL COMPLETION OF THE
- AVOID DAMAGE TO THE SITE AND TO (E) FACILITIES, STRUCTURES, TREES, AND SHRUBS DESIGNATED TO REMAIN, TAKE AVOID DAMAGE TO THE SITE AND TO (E) FACILITIES, STRUCTURES, TREES, AND SHROBS DESIGNATED TO REMAIN. TAKE PROTECTIVE MEASURES TO PREVENT (E) FACILITIES THAT ARE NOT DESIGNATED FOR REMOVAL FROM BEING DAMAGED BY THE WORK.

 KEEP SITE FREE OF ALL PONDING WATER.
- PROVIDE EROSION CONTROL MEASURES IN ACCORDANCE WITH STATE DOT AND EPA REQUIREMENTS
- PROVIDE AND MAINTAIN ALL TEMPORARY FENCING, BARRICADES, WARNING SIGNALS AND SIMILAR DEVICES NECESSARY TO PROTECT AGAINST THEFT FROM PROPERTY DURING THE ENTIRE PERIOD OF CONSTRUCTION. REMOVE ALL SUCH
- DEVICES UPON COMPLETION OF THE WORK.

 (E) UTILITIES: DO NOT INTERRUPT (E) UTILITIES SERVING FACILITIES OCCUPIED BY THE OWNER OR OTHERS, EXCEPT WHEN PERMITTED IN WRITING BY THE ENGINEER AND THEN ONLY AFTER ACCEPTABLE TEMPORARY UTILITY SERVICES HAVE
- PROVIDE A MINIMUM 48-HOUR NOTICE TO THE ENGINEER AND RECEIVE WRITTEN NOTICE TO PROCEED BEFORE INTERRUPTING ANY UTILITY SERVICE

- ENVIRONMENTAL NOTES

 1. ALL WORK PERFORMED SHALL BE DONE IN ACCORDANCE WITH ISSUED PERMITS. THE CONTRACTOR SHALL BE
- ACL WORK PERFORMED STALLS BE DUNIEN IN ACCORDANCE WITH IS SUED PERMITS. THE CONTRACTOR SHALL BE RESPONSIBLE FOR PAYMENT OF FINES AND PROPER CLEAN UP FOR AREAS IN VIOLATION. CONTRACTOR AND/OR DEVELOPER SHALL BE RESPONSIBLE FOR CONSTRUCTION AND MAINTENANCE OF EROSION AND SEDIMENTATION CONTROLS DURING CONSTRUCTION FOR PROPERTIES, ROADWAYS AND WATERWAYS AND SHALL BE MAINTAINED IN PLACE THROUGH FINAL JURISDICTIONAL INSPECTION & RELEASE OF SITE. CONTRACTOR SHALL INSTALL/CONSTRUCT ALL NECESSARY SEDIMENT/SILT CONTROL FENCING AND PROTECTIVE MEASURES WITHIN THE LIMITS OF SITE DISTURBANCE PRIOR TO CONSTRUCTION. NO SEDIMENT SHALL BE ALLOWED TO EXIT THE PROPERTY. THE CONTRACTOR IS RESPONSIBLE FOR TAKING ADEQUATE MEASURES FOR CONTRACTOR IS RESPONSIBLE FOR TAKING ADEQUATE.
- MEASURES FOR CONTROLLING EROSION, ADDITIONAL SEDIMENT CONTROL FENCING MAY BE REQUIRED IN ANY AREAS SUBJECT TO EROSION.
- SUBJECT TO EROSION.

 CONTRACTOR SHALL BE RESPONSIBLE FOR DAILY INSPECTIONS AND ANY REPAIRS OF ALL SEDIMENT
 CONTROL MEASURES INCLUDING SEDIMENT REMOVAL AS NECESSARY.

 CLEARING OF VEGETATION AND TREE REMOVAL SHALL BE ONLY AS PERMITTED AND BE HELD TO A
 MINIMUM. ONLY TREES NECESSARY FOR CONSTRUCTION OF THE FACILITIES SHALL BE REMOVED.

 SEEDING AND MULCHING AND/OR SODDING OF THE SITE WILL BE ACCOMPLISHED AS SOON AS
- POSSIBLE AFTER COMPLETION OF THE PROJECT FACILITIES AFFECTING LAND DISTURBANCE
- POSSIBLE AFTER COMPLETION OF THE PROJECT FACILITIES AFFECTING LAND DISTURBANCE. CONTRACTOR SHALL PROVIDE ALL BROSION AND SEDIMENTATION CONTROL MEASURES AS REQUIRED BY LOCAL, COUNTY AND STATE CODES AND ORDINANCES TO PROTECT EMBANKMENTS FROM SOIL LOSS AND TO PREVENT ACCUMULATION OF SOIL AND SILT IN STREAMS AND DARINAGE PATHS LEAVING THE CONSTRUCTION AREA, THIS MAY INCLUDE SUCH MEASURES AS SILT FENCES, STRAW BALL SEDIMENT BARRIERS, AND CHECK DAMS.
 RIP RAP OF SIZES INDICATED SHALL CONSIST OF CLEAN, HARD, SOUND, DURABLE, UNIFICRM IN
- QUALITY STONE FREE OF ANY DETRIMENTAL QUANTITY OF SOFT FRIABLE THIN ELONGATED OR LAMINATED PIECES, DISINTEGRATED MATERIAL, ORGANIC MATTER, OIL, ALKALI, OR OTHER

HELIX WATER DISTRICT NOTES:

- 1. IT SHALL BE THE CONTRACTOR'S RESPONSIBILITY TO CONTACT HELIX WATER DISTRICT 48 HOURS PRIOR TO COMMENCING WORK, FOR STANDBY, OR ACCESS TO THE SITE AT (619) 596-3860 AND UNDERGROUND SERVICE ALERT FOR LOCATION OF
- EXISTING WATER FACILITIES AT 1-800-422-4133 EXISTING WATER FACILITIES AT 1-800-422-4133.

 CONTRACTOR TO PROTECT ALL EXISTING HELIX WATER DISTRICT FACILITIES AND SHALL BE FINANCIALLY RESPONSIBLE FOR ANY DAMAGE TO HELIX WATER DISTRICT FACILITIES AS A RESULT OF HIS/HER OPERATION, HELIX WATER DISTRICT SHALL BE NOTIFIED IMMEDIATELY TO REPAIR ANY DAMAGE.

 APPROVAL/REVIEW OF PLANS BY HELIX WATER DISTRICT DOES NOT CONSTITUTE RESPONSIBILITY FOR ACCURACY OF
- INFORMATION NOR LOCATIONS OF ANY EXISTING UTILITIES.
- INFORMATION NOR LOCATIONS OF ANY EXISTING UTILITIES.
 THE CONTRACTOR AGREES THAT IF THEY, THEIR EMPLOYEES, AGENTS, OR ANY INDEPENDENT CONTRACTORS OR SUBCONTRACTORS SHOULD USE WATER OTHER THAN THROUGH AN AUTHORIZED WATER METER, CONTRACTOR SHALL PAY A CHARGE, DETERMINED BY HELLX WATER DISTRICT, PER OCCURRENCE FOR SADI USE.

 NO PERSON, OTHER THAN AN EMPLOYEE OR AGENT OF HELIX WATER DISTRICT, SHALL HAVE A RIGHT TO OPERATE ANY PART OF A HELIX WATER DISTRICT DISTRICT. SYSTEM, SHALL BE LIABLE FOR ANY INJURY OR DAMAGE CAUSED THEREBY OR RESULTING THERE FROM. A CHARGE DETERMINED BY HELIX WATER DISTRICT, PER OCCURRENCE WILL BE IMPOSED ON ANY PERSON OR COMPANY WHO
- DETERMINED BY HELIX WATER DISTRICT, PER OCCURRENCE WILL BE IMPOSED ON ANY PERSON OR COMPANY WHO OPERATES ANY PART OF THE HELIX WATER DISTRICT WATER SYSTEM WITHOUT PROPER AUTHORIZATION, CONTRACTOR TO VERIFY THE LOCATIONS, BY PLOT HOLING, ALL UTILITIES IN THE IMMEDIATE AREA OR AFFECTED BY THE WORK PRIOR TO COMMENCING WORK.

 CONDUIT CROSSINGS OVER WATER LINE SHALL BE PLACED IN A CASING. THE CASING SHALL BE CENTERED ON THE WATER LINE, 5' ON BOTH SIDES, AND ENCASED IN "RED" CONCRETE THE FULL LENGTH OF THE CASING. CONTRACTOR SHALL MAINTAIN

A MINIMUM 12-INCH VERTICAL SEPARATION BETWEEN THE WATER MAIN AND ALL OTHER UTILITIES AT EACH CROSSING.







SAN CLEMENTE CA 92673 (949) 391-6824

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5 01/31/2025 100% CD'S FOR SUBMITTAL 4 01/03/2025 100% CD'S FOR SUBMITTAL 3 04/06/2023 100% CD'S PER NEW DESIGN 2 03/22/2023 100% CD'S FOR SUBMITTAL 1 01/04/2023 100% ZD'S PER JX COMMENTS 0 05/12/2022 100% ZD'S FOR REVIEW A 04/13/2022 90% ZD'S FOR REVIEW REV DATE DESCRIPTION

> IS A VIOLATION OF LAW FOR ANY PERSON LINEESS HEY ARE ACTING UNDER THE DIRECTION OF A LICENS PROFESSIONAL ENGINEER, TO ALTER THIS DOCUMENT.

ANCHOR/L600 MODIFICATION SITE ID: SD06045A SD045 HELIX WATER DISTRICT 13002 HIGHWAY 8 BUSINESS EL CAJON, CA 92021 WATER TANK

SHEET TITLE

GENERAL NOTES

SHEET NUMBER

GN-1

$\langle 1 \rangle$	(E) WATER TANK 1A	7	(E) CHAIN LINK FENCE; TYP.
2	(E) WATER TANK 1B	8	(E) OVERHEAD UTILITIES; TYP.
$\langle 3 \rangle$	(E) PUMP STATION	9	(E) UNDERGROUND UTILITIES; TYP.
4	(E) ACCESS ROAD FROM HWY 8 BUSINESS	10	(E) UTILITY POLE; TYP.
5	(E) ACCESS ROAD FROM JACKSON HILL DR	11	FOR ENLARGED SITE PLAN SEE: (1,A-1.1)
6	(E) UTILITY POLE; POWER AND FIBER POC	12	(N) T-MOBILE 6X24 HCS 4AWG; (1) PER SECTOR, (3) TOTAL * SECTOR 'A'=±140'; SECTOR 'B'=±100'; SECTOR 'C'=±220' D-1 D-2

NOTES:

- THE WIRELESS COMMUNICATION FACILITY COMPLIES WITH FEDERAL STANDARDS FOR RADIO FREQUENCY IN ACCORDANCE WITH THE TELECOMMUNICATION ACT OF 1996 AND SUBSEQUENT AMENDMENTS AND ANY OTHER REQUIREMENTS IMPOSED BY STATE OR FEDERAL REGULATORY AGENCIES.
- NO EXISTING PARKING STALLS ARE BEING ADDED OR REMOVED AS PART OF THE NEW INSTALLATION.
- 3. THESE DRAWINGS WERE PRODUCED WITHOUT THE BENEFIT OF A CURRENT LAND SURVEY. ALL PROPERTY LINES, EASEMENTS, SETBACKS, AND EXISTING CONDITIONS ARE APPROXIMATE AND SHALL BE VERIFIED PRIOR TO START OF CONSTRUCTION.

DISCLAIMER:

DISCLAMMEN:

THIS SET OF DRAWINGS WAS PREPARED
UTILIZING INFORMATION OBTAINED FROM PUBLIC
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WEBSITE. M SQUARED WIRELESS CANNOT
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AND INFORMATION. THE PARCEL LINES ON MAPS
ARE FOR ILLUSTRATION PURPOSES ONLY AND
ARE NOT INTENDED TO BE USED AS A SURVEY
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ANY SUCH DATA OR INFORMATION IN ITS ACTUAL
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	1	01/04/2023	100% ZD'S PER JX COMMENTS
	0	05/12/2022	100% ZD'S FOR REVIEW
	Α	04/13/2022	90% ZD'S FOR REVIEW
	REV	DATE	DESCRIPTION

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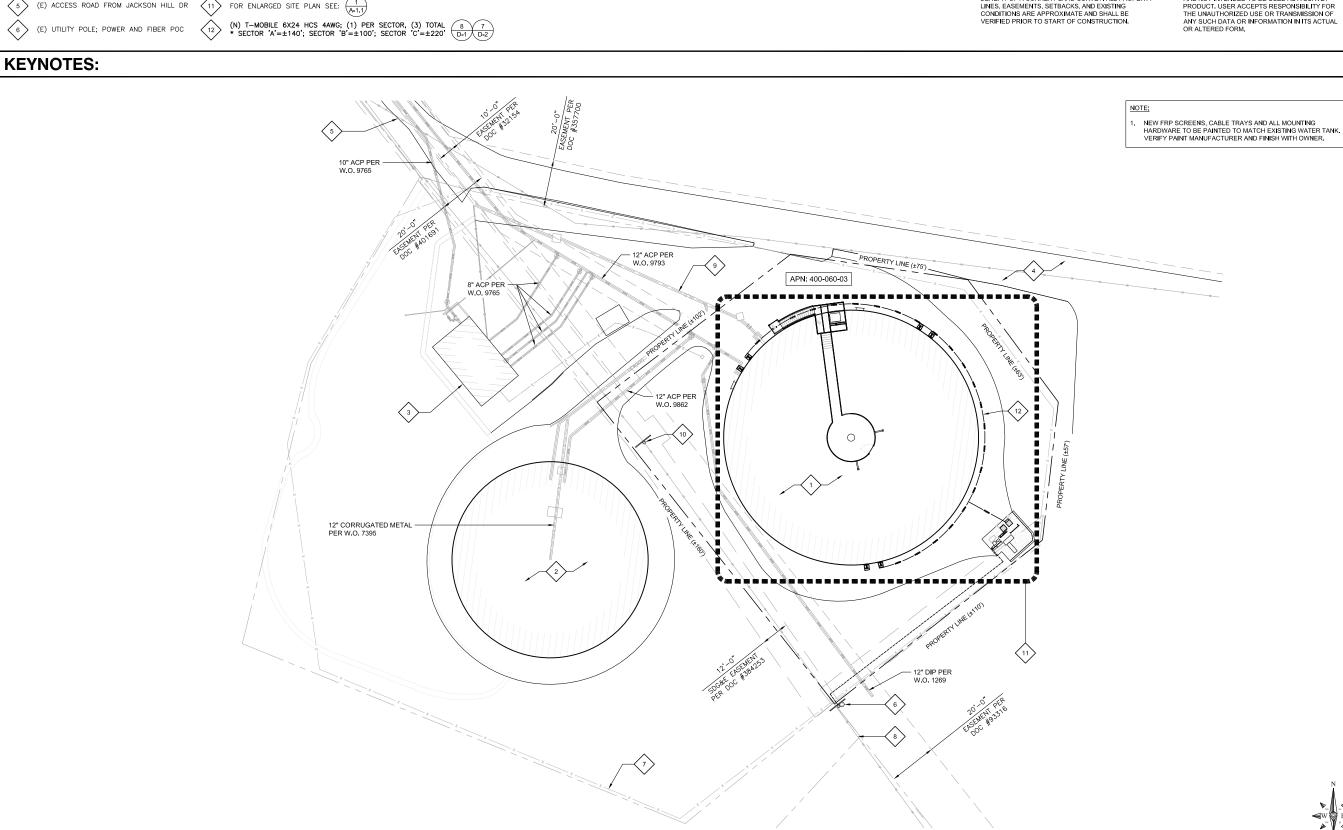
ANCHOR/L600 MODIFICATION SITE ID: SD06045A SD045 HELIX WATER DISTRICT 13002 HIGHWAY 8 BUSINESS EL CAJON, CA 92021 WATER TANK


SHEET TITLE

SITE PLAN

SHEET NUMBER

A-1



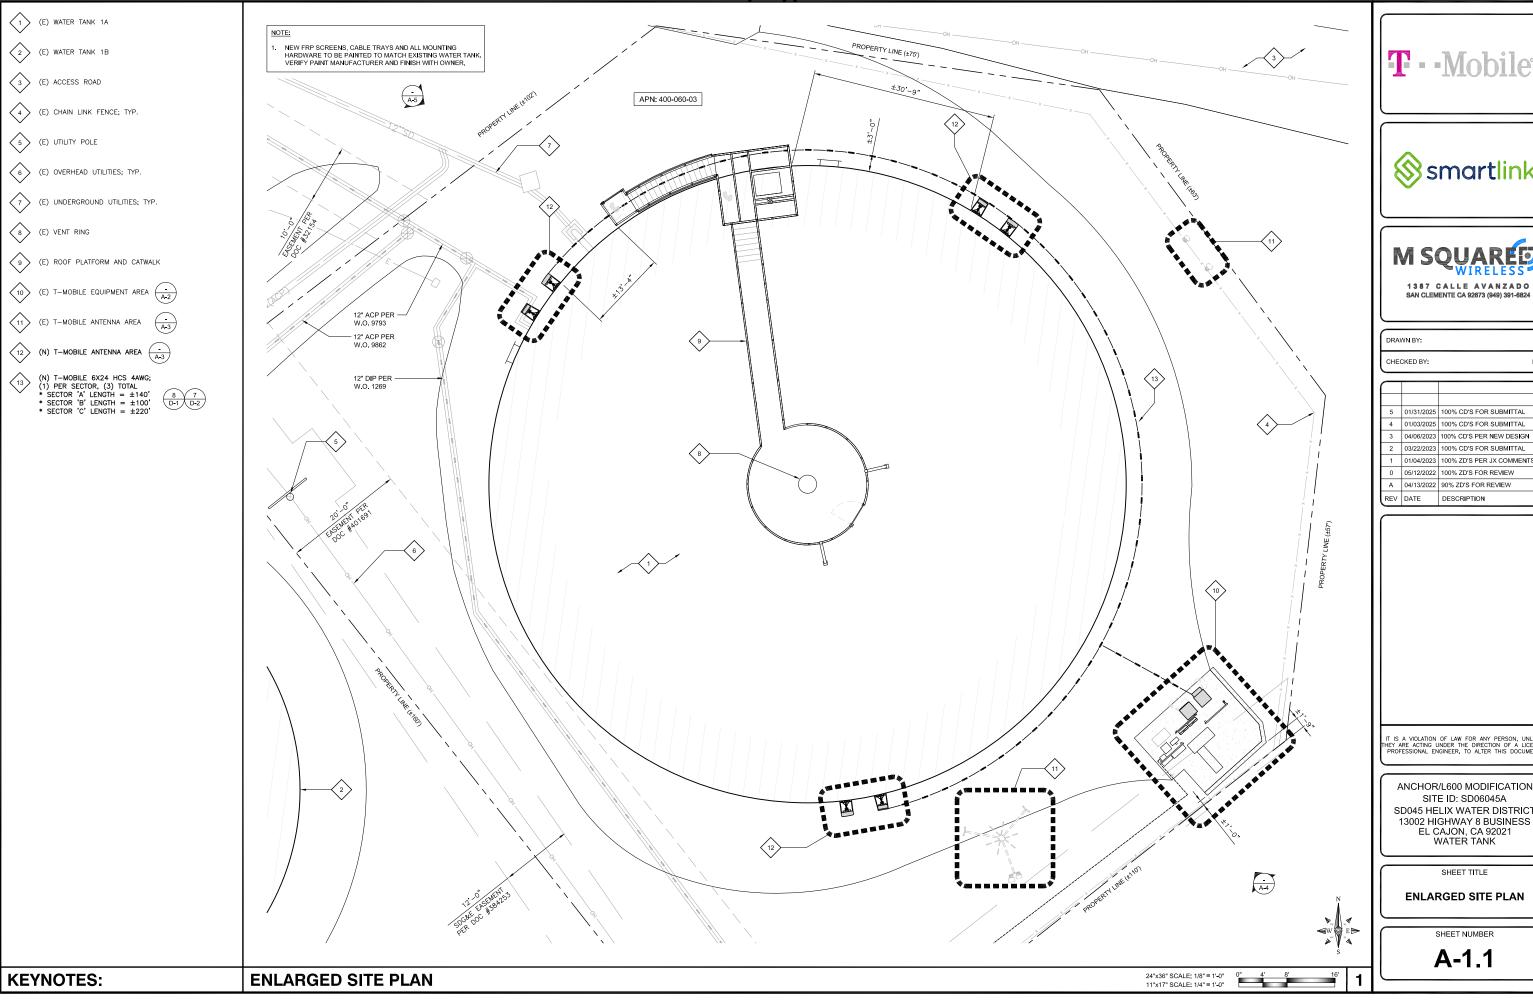







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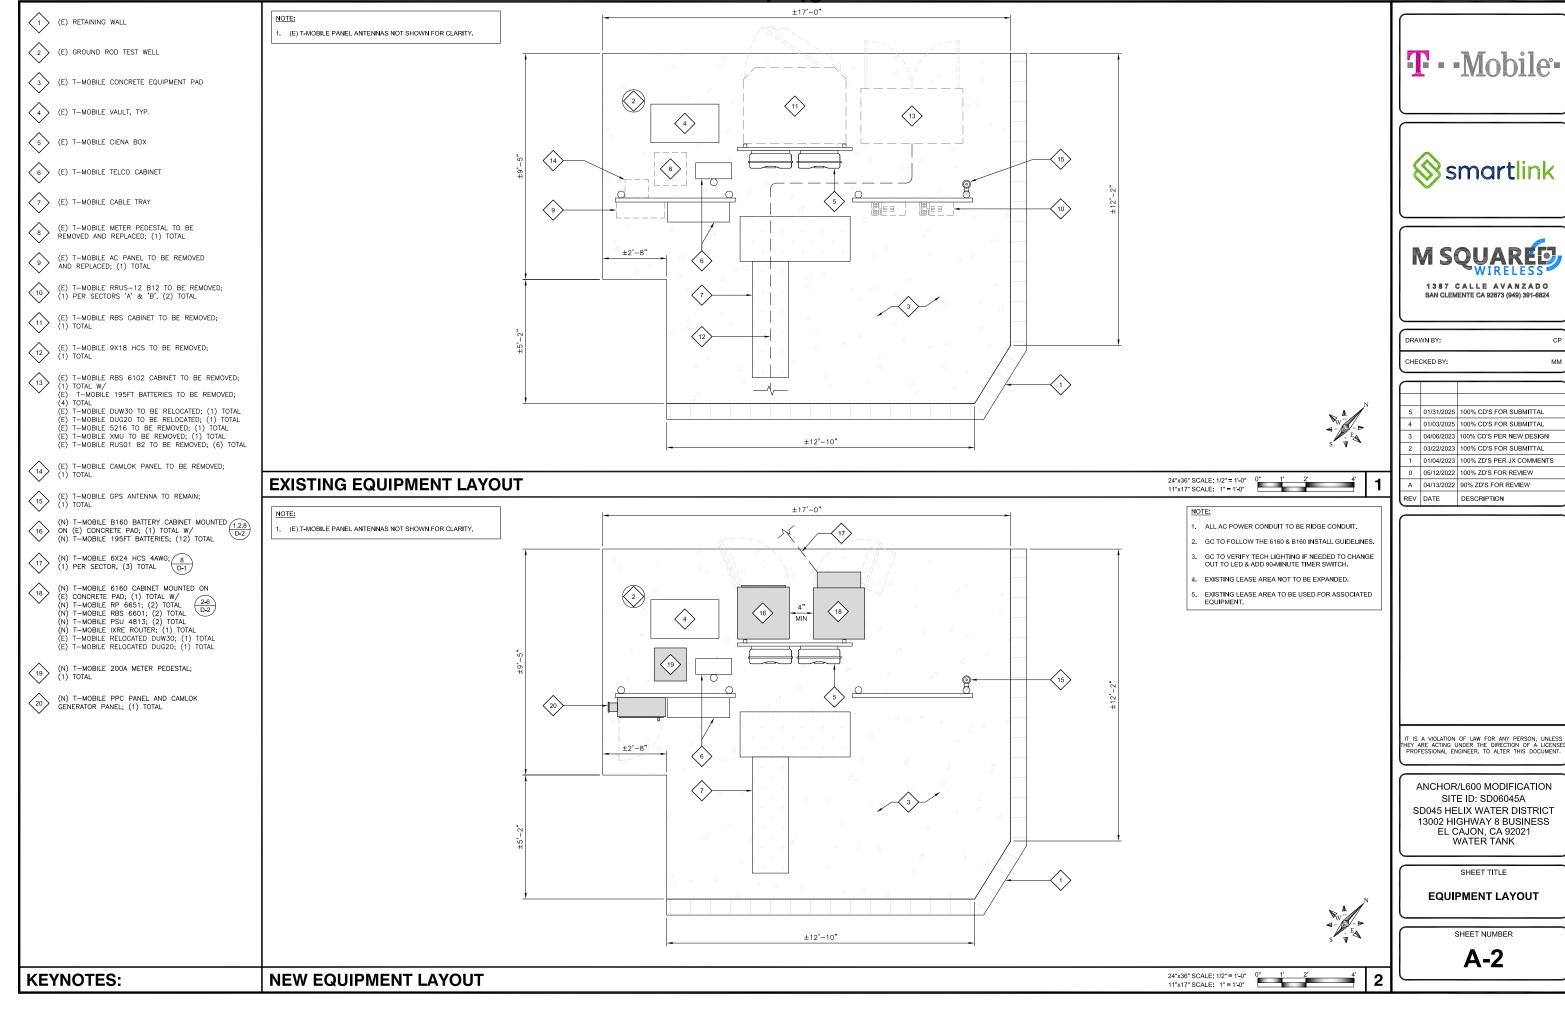
ANCHOR/L600 MODIFICATION SITE ID: SD06045A SD045 HELIX WATER DISTRICT 13002 HIGHWAY 8 BUSINESS EL CAJON, CA 92021 WATER TANK

SHEET TITLE

ENLARGED SITE PLAN

SHEET NUMBER

A-1.1



	NEW OPTIMAL ANTENNA & TRANSMISSION CABLES REQUIREMENTS (VERIFY WITH CURRENT RFDS)		ANTENNA MAKE AND MODEL		RAD CENTER		AZIMUTH		TRANSMISSION LINE		
	ANTENNA POSITION TECHNOLOGY ANTENNA COUNT		EXISTING	FINAL	EXISTING	FINAL	EXISTING	FINAL	CABLE LENGTH	FEEDER TYPE	
OR A	1	L2500, N2500	1	COMMSCOPE SBNH-1D65C (QUAD)	(N) ERICSSON AIR6419 B41 (MIMO)	45'-0"	34'-0"	45°	35°	±140	(N) 6X24 HCS
SECTOR	2	L600 , L700, N600 , L1900 L2100, G1900, U1900	1	ERICSSON AIR32 B66A/B2A (OCTO)	(N) RFS APXVAALL24_43-U-NA20 (OCTO)	47"-0"	32-0	45°	35°	-	-
OR B	1	L2500, N2500	1	COMMSCOPE SBNH-1D65C (QUAD)	(N) ERICSSON AIR6419 B41 (MIMO)	45'-0"	34'-0"	170°	170°	±100	(N) 6X24 HCS
SECTOR B	2	L600 , L700, N600 , L1900 L2100, G1900, U1900	1	ERICSSON AIR32 B66A/B2A (OCTO)	(N) RFS APXVAALL24_43-U-NA20 (OCTO)	47"-0"	32'-0"	170°	170°	-	-
ORC	1	L2500, N2500	1	-	(N) ERICSSON AIR6419 B41 (MIMO)		34'-0"	-	305°	±220'	(N) 6X24 HCS
SECTOR	2	L600, L700, N600, L1900 L2100, G1900, U1900	1	-	(N) RFS APXVAALL24_43-U-NA20 (OCTO)	-	32-0	-	305°	-	-

	\times	REMOTE RADIO UNITS	ADIO UNITS		ABLES
	ANTENNA POSITION	RRUS MAKE AND MODEL	RRUS COUNT	LENGTH	AWG
OR A	1	-	-	-	ı
SECTOR	2	(N) ERICSSON 4460 B25+B66 (N) ERICSSON 4480 B71+B85	2	±8'	-
OR B	1	-	-	-	
SECTOR	2	(N) ERICSSON 4460 B25+B66 (N) ERICSSON 4480 B71+B85	2	±8'	-
OR C	1	-	-	-	-
SECTOR	2	(N) ERICSSON 4460 B25+B66 (N) ERICSSON 4480 B71+B85	2	±8'	-

NOTES TO CONTRACTOR:


- CONTRACTOR IS TO REFER TO T-MOBILE'S
 MOST CURRENT RADIO FREQUENCY DATA
 SHEET (RFDS) PRIOR TO CONSTRUCTION
- CABLE LENGTHS WERE DETERMINED BASED ON VISUAL INSPECTION DURING SITE-WALK. CONTRACTOR TO VERIFY ACTUAL LENGTH DURING PRE-CONSTRUCTION WALK
- CONTRACTOR TO VERIFY PORTS HAVE SUFFICIENT ROOM

NOTE:

PRIOR TO ORDERING ANTENNAS VERIFY CORRECT MODEL NUMBER WITH LATEST RFDS AND NOTIFY ENGINEER OF RECORD IMMEDIATELY IF DISCREPANCY IS FOUND

NOTE:

- (E) ANTENNA AZIMUTHS ARE ESTIMATED AND ARE TO BE VERIFIED BY RF.
- 2. NEW PANEL ANTENNAS AND ALL MOUNTING HARDWARE TO BE PAINTED TO MATCH EXISTING STRUCTURE IF REQUIRED. VERIFY PAINT MANUFACTURER AND FINISH WITH OWNER

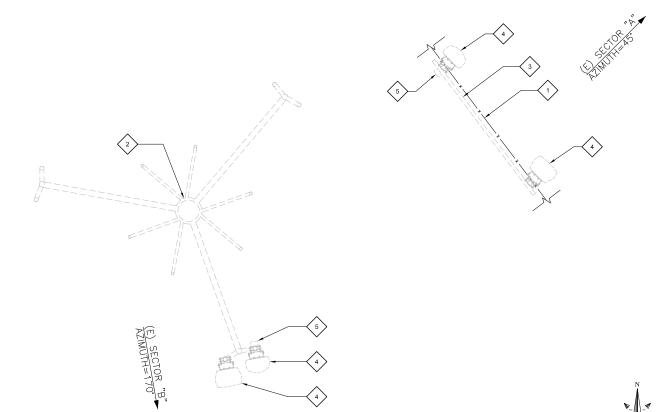







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-	Ш	REV	DATE	DESCRIPTION

24"x36" SCALE: 1/2" = 1'-0" 0" 1' 2' 11"x17" SCALE: 1" = 1'-0"

ANTENNA & EQUIPMENT SCHEDULE


- 1 (E) CHAIN LINK FENCE
- 2) (E) 42'-8" MONOPOLE TO BE REMOVED; (1) TOTAL
- (E) FRAME MOUNT TO BE REMOVED; (1) TOTAL
- (E) T-MOBILE PANEL ANTENNA TO BE REMOVED; (2) PER SECTOR 'A' & 'B', (2) TOTAL
- (E) T-MOBILE TMA TO BE REMOVED; (1) PER SECTOR 'A' & 'B', (2) TOTAL
- 6 (E) WATER TANK 1A
- (N) T-MOBILE MOUNT MOUNTED TO (E) WATER TOWER (CONTRACTOR TO PROTECT (E) WATER TANK COATING DURING THE INSTALLATION); (1) PER SECTOR, (3) TOTAL (EA. SECTOR TO HAVE (7) STM2 MAGNEMOUNT ASSEMBLIES)
 - (N) T-MOBILE 3'-0" AIR6419 B41 PANEL ANTENNAS MOUNTED (24 TO (N) PIPE MAST; (1) PER SECTOR, (3) TOTAL
 - (N) T-MOBILE 8'-0" APXVAALL24_43-U-NA20 PANEL ANTENNAS $\begin{pmatrix} 4.5 \\ D-1 \end{pmatrix}$ MOUNTED TO (N) PIPE MAST; (1) PER SECTOR, (3) TOTAL
- (N) T-MOBILE 4460 B25+B66 RRU STACK-MOUNTED TO (4.6 D-1)

 (N) PIPE MAST; (1) PER SECTOR, (3) TOTAL
- (N) T-MOBILE 4480 B71+B85 RRU STACK-MOUNTED TO (N) PIPE MAST; (1) PER SECTOR, (3) TOTAL (D-1)

NOTE:

- CONTRACTOR TO VERIFY APPROVED STRUCTURAL ANALYSIS PRIOR TO INSTALLATION.
- 2. CONTRACTOR TO VERIFY ANTENNA TECHNOLOGIES PRIOR TO REMOVAL OF ANY ANTENNAS.
- 3. CONTRACTOR TO SUPPLY WEATHERPROOFING FOR CONNECTIONS.
- 4. GENERAL CONTRACTOR TO PROVIDE MOUNTS OR ADDITIONAL HARDWARE IF REQUIRED TO SUPPORT PROPOSED ANTENNAS. ALL ANTENNAS & MOUNTING HARDWARE SHALL CONFORM TO DESIGN REQUIREMENTS PER 2013 IBC/2016 CBC AND EIATHA-222-G STRUCTURAL STANDARDS FOR STEEL ANTENNA TOWERS AND ANTENNA SUPPORTING STRUCTURES.



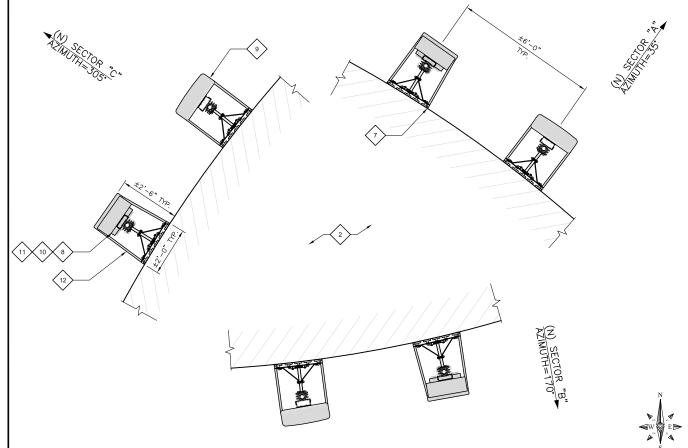

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ANCHOR/L600 MODIFICATION SITE ID: SD06045A SD045 HELIX WATER DISTRICT 13002 HIGHWAY 8 BUSINESS EL CAJON, CA 92021 WATER TANK

SHEET TITLE


ANTENNA LAYOUT

SHEET NUMBER

A-3

KEYNOTES:

NEW ANTENNA PLAN

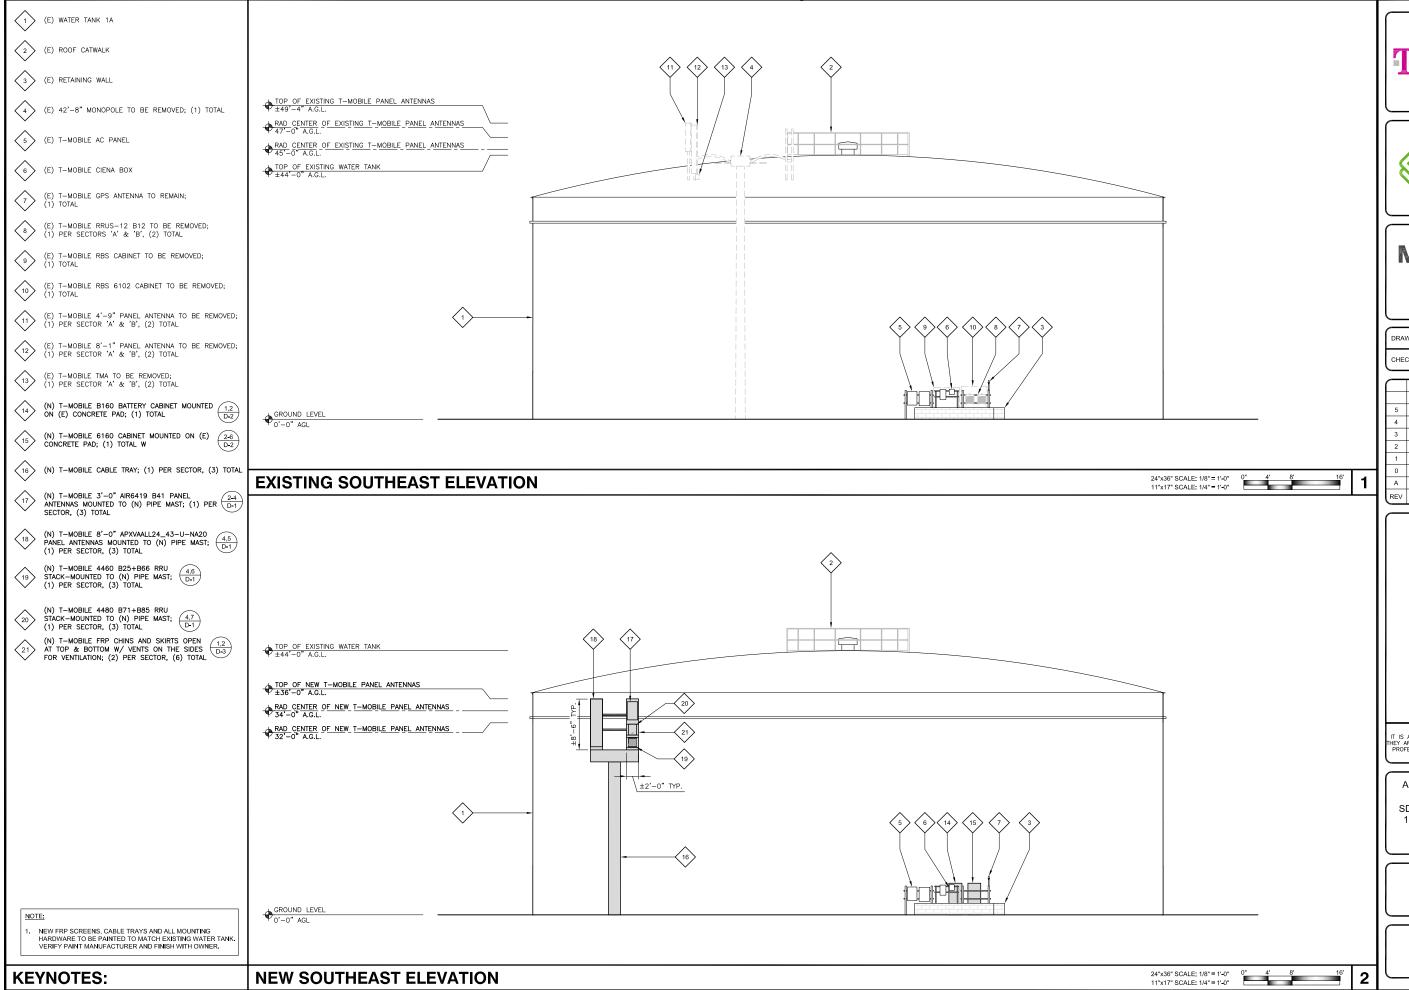

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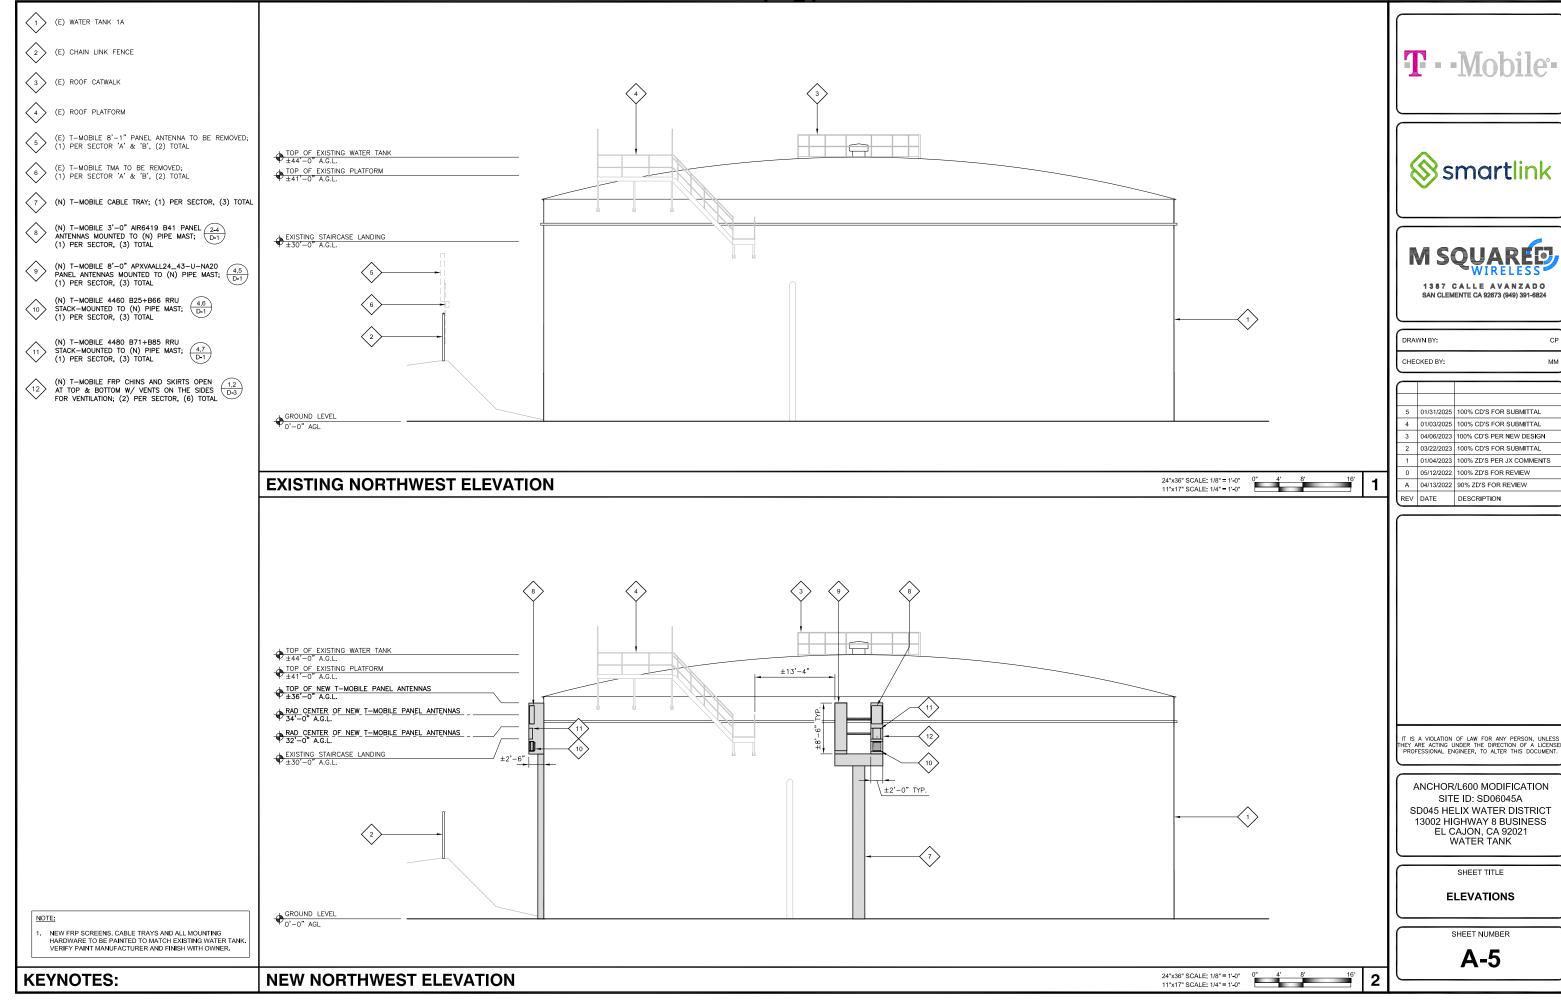
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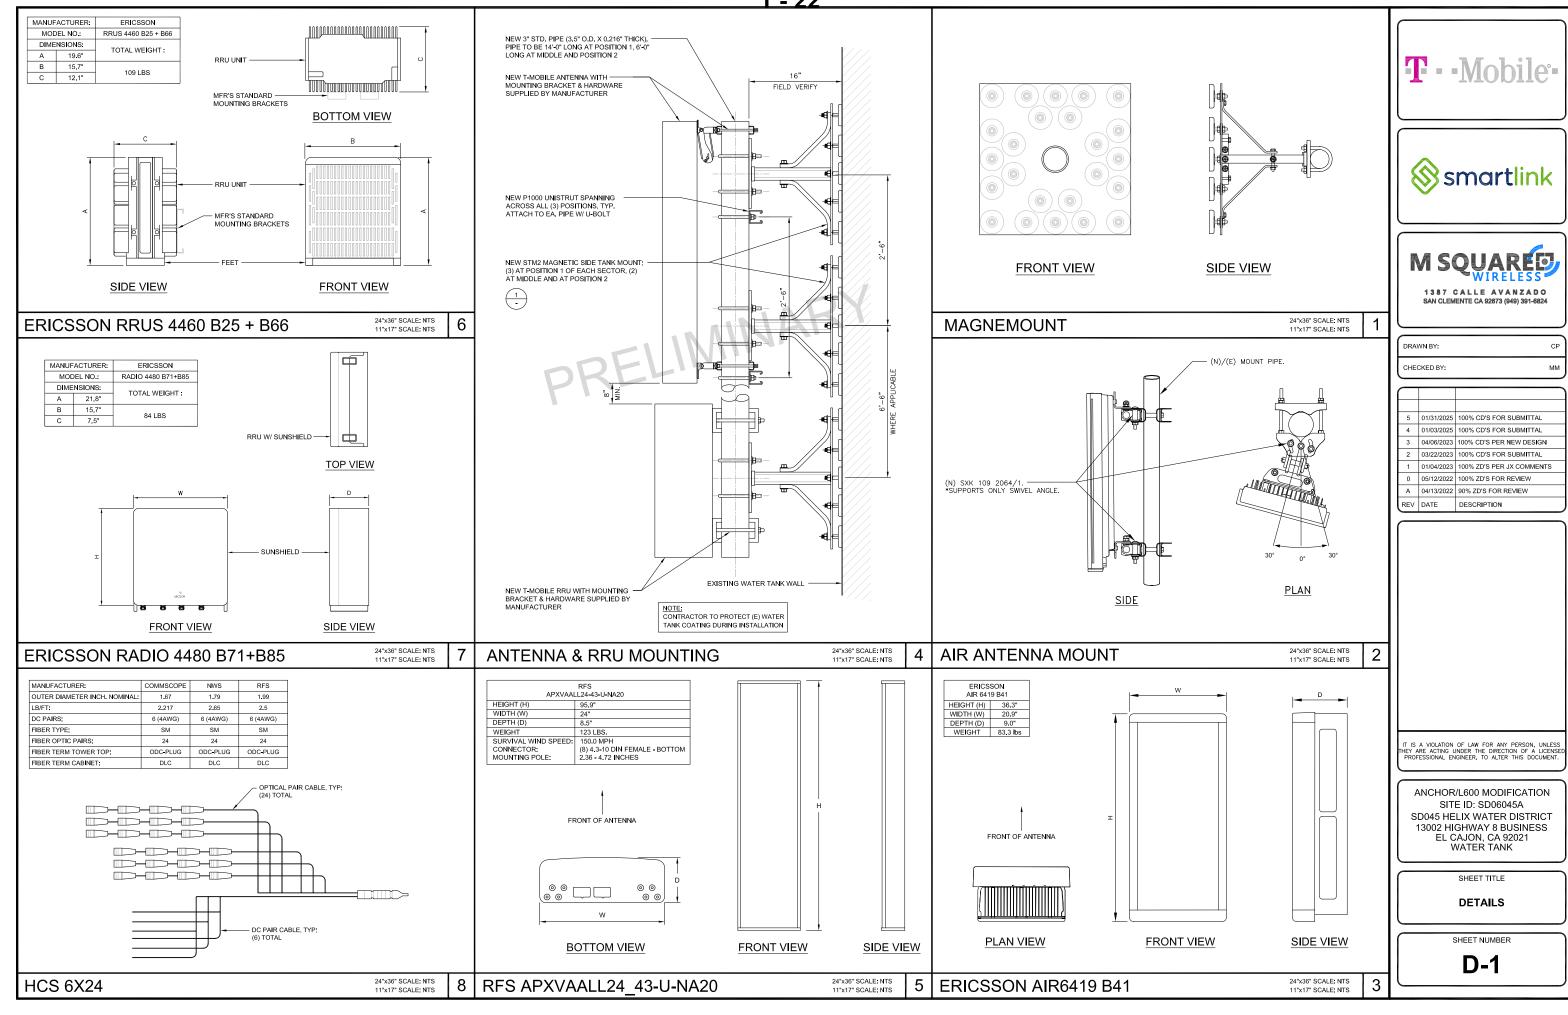
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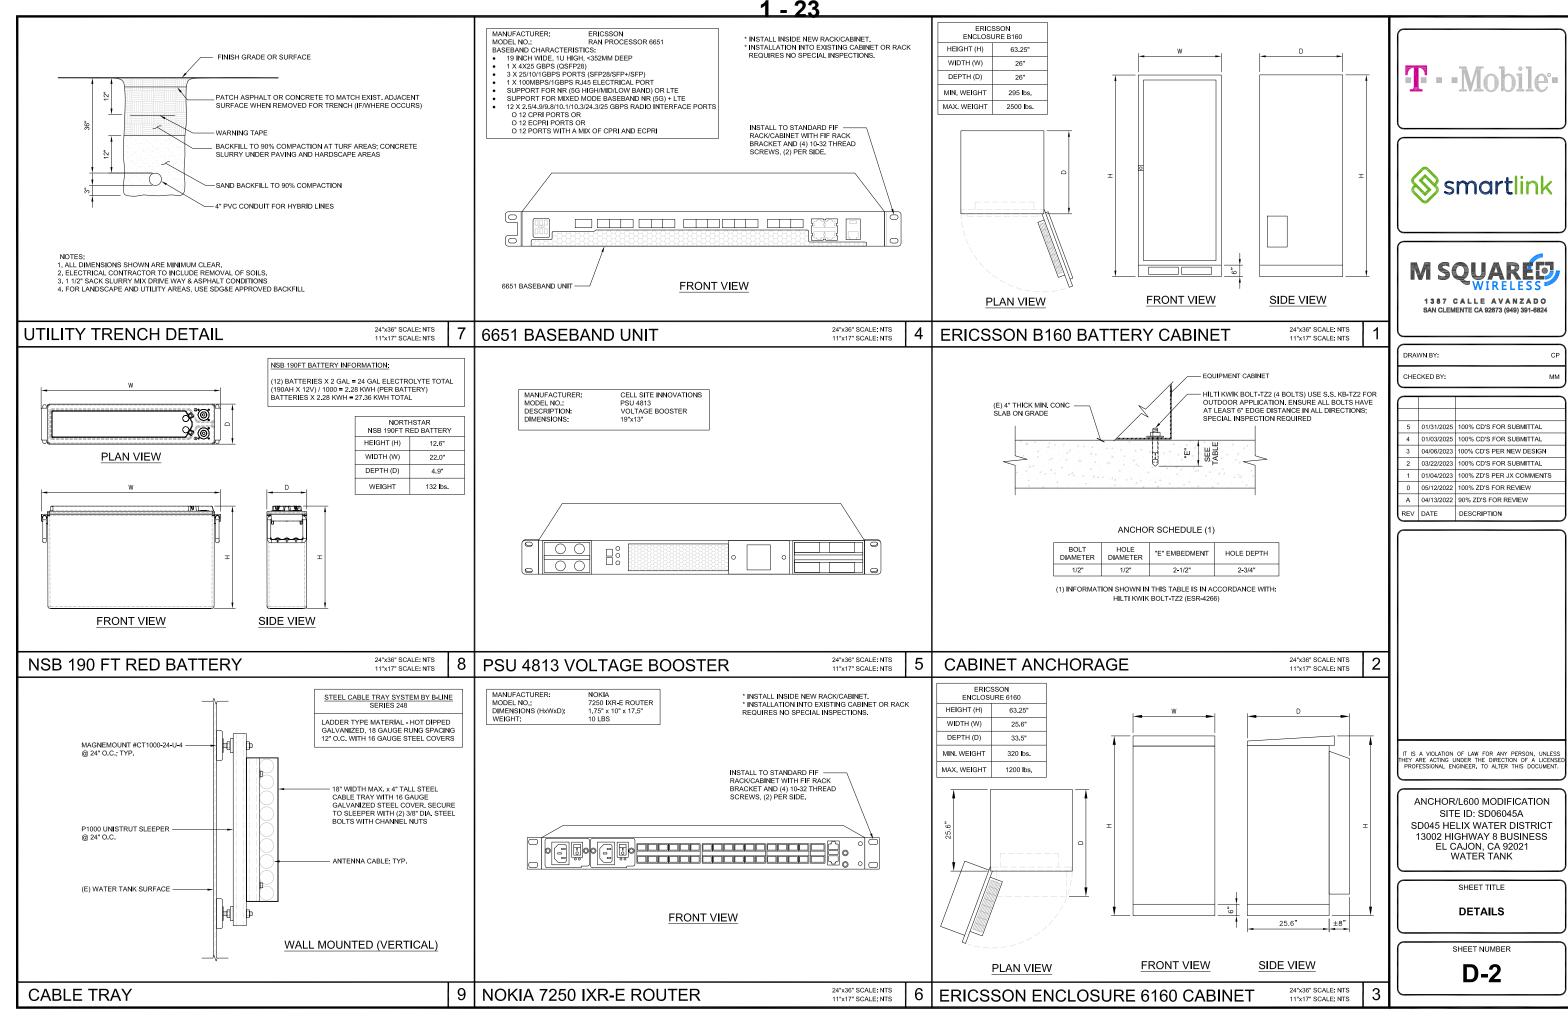
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SHEET NUMBER


A-4








-(E) WATER TANK — (N) MAGNEMOUNT, TYP. (N) MOLDED FRP (2-1/2" X 2-1/2" X 3/16") ANGLED BRACKETS (ON SIDE WALLS, TOP, & BOTTOM) FIBER BOLT @24" O.C. TYP smartlink -(N) MOLDED FRP SKIRT AND CHIN STRAP TEXTURED & PAINTED TO MATCH EXISTING PER PLAN PANEL ANTENNA/ RADIO PER PLAN 1387 CALLE AVANZADO SAN CLEMENTE CA 92673 (949) 391-6824 SKIRT COVER DETAIL 24"x36" SCALE: NTS 11"x17" SCALE: NTS **NOT USED** NOT USED DRAWN BY: CHECKED BY: CHIN COVER TO BE MOLDED FIBERGLASS TO MATCH EXACT ANTENNA/RADIO DIMENSION AND PROFILE 5 01/31/2025 100% CD'S FOR SUBMITTAL EDGE OF ANTENNA/RADIO BOTTOM, BEYOND 4 01/03/2025 100% CD'S FOR SUBMITTAL LINE OF CHIN COVER BEYOND 3 04/06/2023 100% CD'S PER NEW DESIGN PROVIDE INTEGRAL TAB AT — EACH SIDE FOR ATTACHMENT TO SIDE SKIRTS 2 03/22/2023 100% CD'S FOR SUBMITTAL 1 01/04/2023 100% ZD'S PER JX COMMENTS 3-SIDED CHIN COVER WITH BOTTOM, PAINTED AND TEXTURED TO MATCH 0 05/12/2022 100% ZD'S FOR REVIEW A 04/13/2022 90% ZD'S FOR REVIEW REV DATE DESCRIPTION OPEN AT BOTTOM VENT ON BOTH SIDES FOR VENTILATION, TYP. 24"x36" SCALE: NTS 11"x17" SCALE: NTS CHIN COVER DETAIL **NOT USED** NOT USED IT IS A VIOLATION OF LAW FOR ANY PERSON, UNLESS THEY ARE ACTING UNDER THE DIRECTION OF A LICENSEI PROFESSIONAL ENGINEER, TO ALTER THIS DOCUMENT. ANCHOR/L600 MODIFICATION SITE ID: SD06045A SD045 HELIX WATER DISTRICT 13002 HIGHWAY 8 BUSINESS EL CAJON, CA 92021 WATER TANK SHEET TITLE **DETAILS** SHEET NUMBER **D-3** NOT USED **NOT USED** 9 NOT USED 3

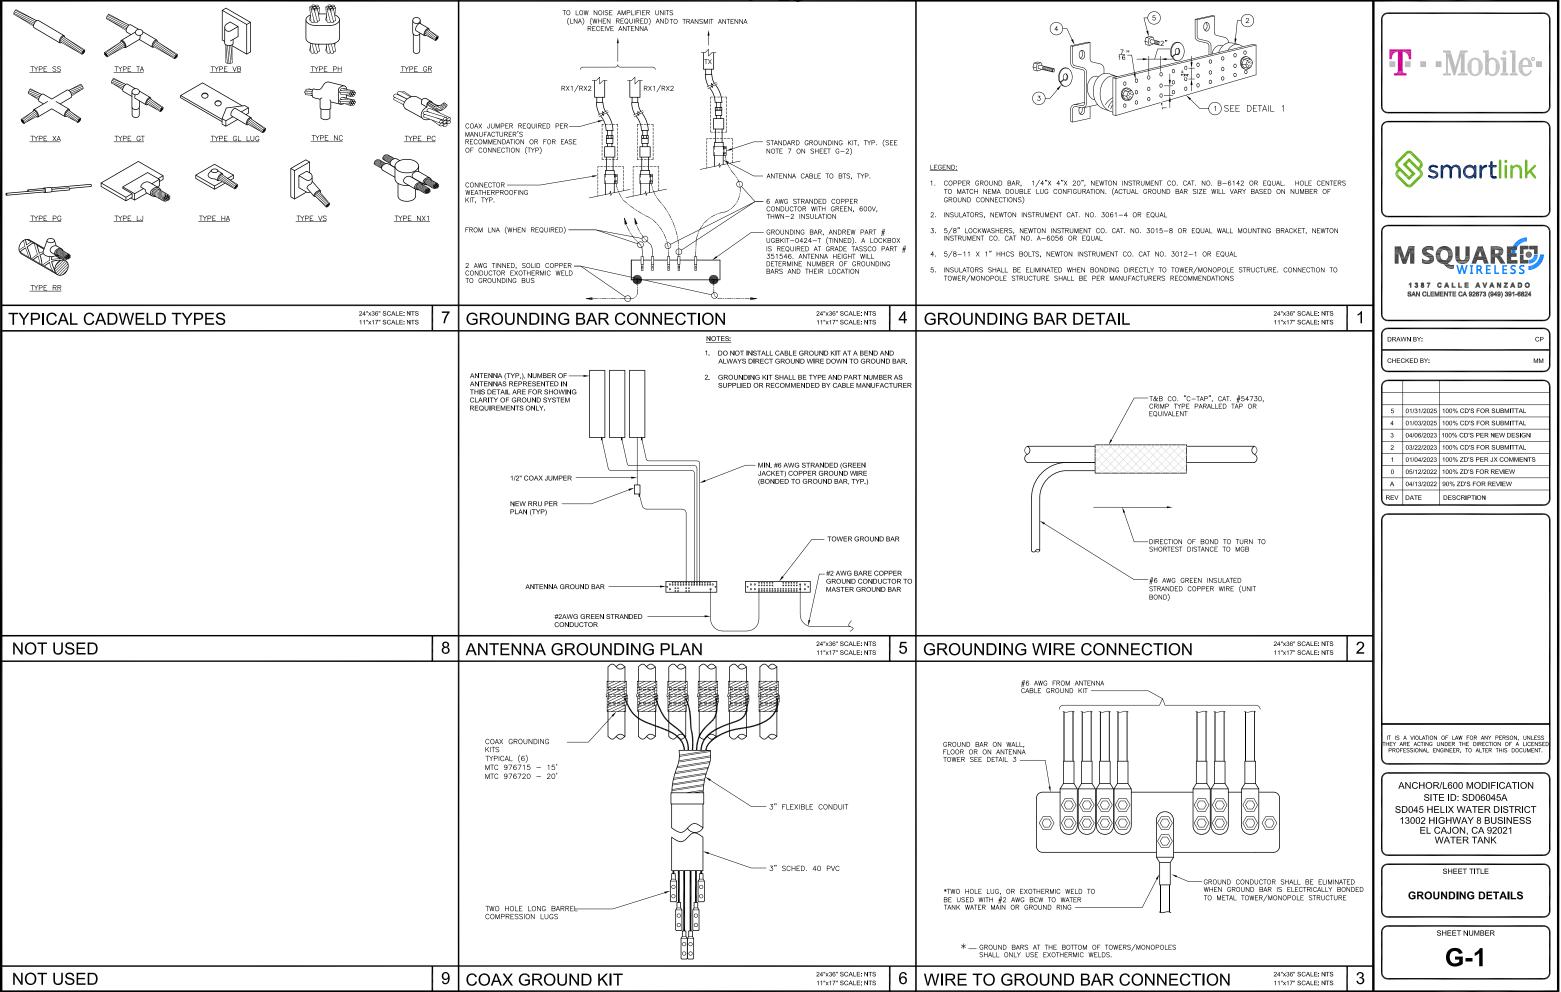

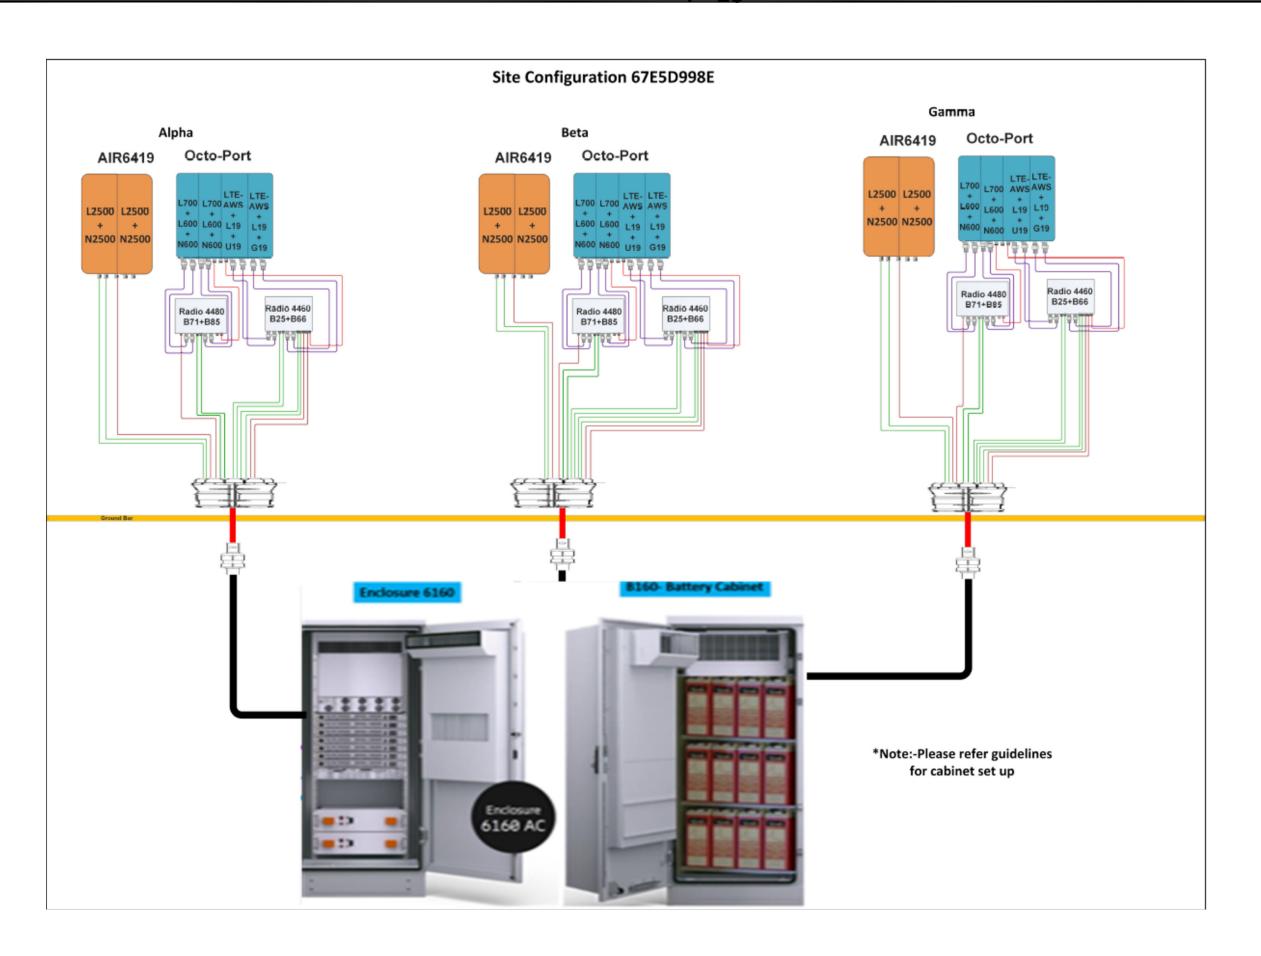

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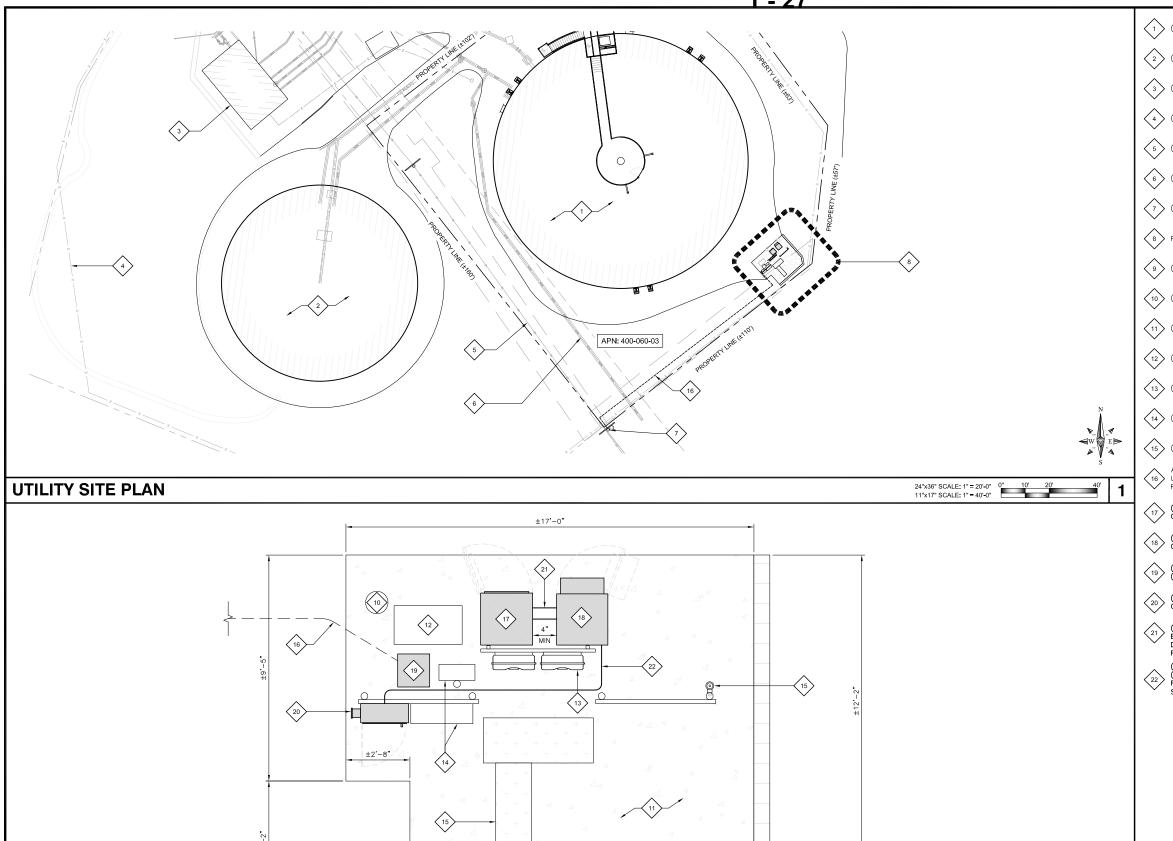
ANCHOR/L600 MODIFICATION SITE ID: SD06045A SD045 HELIX WATER DISTRICT 13002 HIGHWAY 8 BUSINESS EL CAJON, CA 92021 WATER TANK

SHEET TITLE

CABLE LINE DIAGRAM

SHEET NUMBER

RF-1



EQUIPMENT SITE DIAGRAM

1 (E) WATER TANK 1A

(E) WATER TANK 1B

(E) PUMP STATION

4 (E) CHAIN LINK FENCE; TYP.

(E) OVERHEAD UTILITIES; TYP.

(E) UNDERGROUND UTILITIES; TYP.

(E) UTILITY POLE; POWER AND FIBER POC

8 FOR EQUIPMENT SITE DIAGRAM SEE: 2

9 (E) RETAINING WALL

(E) GROUND ROD TEST WELL

(E) T-MOBILE CONCRETE EQUIPMENT PAD

12 (E) T-MOBILE VAULT, TYP.

(E) T-MOBILE CIENA BOX

(E) T-MOBILE TELCO CABINET

(E) T-MOBILE CABLE TRAY

APPROX. LOCATION OF (E) T-MOBILE 2" PVC SCH 40 UNDERGROUND CONDUIT FROM (E) SDGE UTILITY POLE RISER TO (N) T-MOBILE METER PEDESTAL

(N) T-MOBILE B160 BATTERY CABINET MOUNTED (1,2 D-2)

(N) T-MOBILE 6160 CABINET MOUNTED ON (E) CONCRETE PAD; (1) TOTAL

(N) T-MOBILE 200A METER PEDESTAL; (1) TOTAL

(N) T-MOBILE PPC PANEL AND CAMLOK GENERATOR PANEL; (1) TOTAL

(N) 2" CONDUIT AND DC FEEDERS FROM (N) DC
BATTERY CIRCUIT BREAKER DISCONNECTS TO (N)
DC POWER PLANT (SIZE DC FEEDERS PER POWER
PLANT REQUIREMENTS)

(N) RGS CONDUIT AND FEEDER FROM (N) PPC TO
(N) RF CABINET, SEE SHEET E-3 FOR CONDUIT SIZE AND
FILL (ROUTE (N) CONDUIT ON TOP OF (E) CONCRETE
SLAB AND SUPPORT AS NEEDED ON UNISTRUT SUPPORTS)

T - Mobile





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SHEET TITLE

UTILITY SITE PLAN & EQUIPMENT SITE DIAGRAM

SHEET NUMBER

E-1

24*x36" SCALE: 1/2" = 1-0" 0" 1' 2' 4' 2 KEYNOTES:

NOT USED



- ALL ELECTRICAL WORK SHALL COMPLY WITH THE LATEST EDITION OF THE CALIFORNIA ELECTRICAL CODE, AS WELL
 AS WITH ALL LOCAL, STATE AND NATIONAL CODES, LAWS AND ORDINANCES APPLICABLE TO ELECTRICAL WORK.
- THE ELECTRICAL CONTRACTOR SHALL VISIT THE JOBSITE AND VERIFY EXISTING CONDITIONS BEFORE BIDDING AND SHALL INCLUDE IN HIS/HER BID, THE NECESSARY COSTS TO CONSTRUCT THIS PROJECT IN ACCORDANCE WITH THE INTERT OF THE ELECTRICAL DRAWINGS. SPECIFICATIONS AND ALL APPLICABLE CODES.
- 3. ALL ELECTRICAL COMPONENTS SHALL BE CLEARLY LABELED. ALL EQUIPMENT SHALL BE LABELED WITH THEIR VOLTAGE RATING, PHASE CONFIGURATION, WIRE CONFIGURATION, POWER OR AMPACITY RATING AND BRANCH CIRCUIT ID NUMBERS (I.E. PANELBOARD AND CIRCUIT ID'S).
- 4. ALL WORK SHALL BE EXECUTED IN A WORKMANLIKE MANNER AND SHALL PRESENT A NEAT MECHANICAL APPEARANCE WHEN COMPLETED.
- 5. EACH END OF EVERY POWER, GROUNDING, CONTROL AND ALARM CONDUCTOR AND CABLE SHALL BE LABELED OR IDENTIFIED WITH COLOR—CODED INSULATION OR ELECTRICAL TAPE (3M BRAND, 1/2 INCH PLASTIC ELECTRICAL TAPE WITH UV PROTECTION, OR EQUAL). THE IDENTIFICATION METHOD SHALL CONFORM WITH NEC & OSHA AND MATCH EXISTING INSTALLATION REQUIREMENTS.
- 6. ALL ELECTRICAL MATERIALS AND EQUIPMENT SHALL BE LISTED BY UNDERWRITER'S LABORATORIES.
- 7. THE ELECTRICAL CONTRACTOR SHALL BE RESPONSIBLE FOR ALL CUTTING AND PATCHING RELATED TO ELECTRICAL WORK, UNLESS OTHERWISE NOTED AND COORDINATED WITH THE GENERAL CONTRACTOR.
- 8. POWER AND EQUIPMENT GROUND WIRING SHALL BE 12 AWG OR LARGER, 600V, OIL RESISTANT THHN OR THWN-2, CLASS B STRANDED COPPER CABLE RATED FOR 90°C (WET AND DRY) OPERATION; LISTED OR LABELED FOR THE LOCATION AND RACEWAY SYSTEM USED, UNLESS OTHERWISE SPECIFIED.
- CONTROL AND ALARM WIRING SHALL BE COPPER, 300V OR 600V LISTED OR LABELED FOR THE LOCATION AND RACEWAY SYSTEM USED, UNLESS OTHERWISE SPECIFIED.
- 10. UPON COMPLETION OF THE ELECTRICAL WORK, THE INSTALLATION SHALL BE FREE FROM GROUNDS AND SHORT CIRCUITS.
- 11. ELECTRICAL CONTRACTOR SHALL FURNISH AS—BUILT DRAWINGS TO THE ARCHITECT/ENGINEER UPON COMPLETION OF THE JOB.
- 12. ALL POWER AND EQUIPMENT GROUND WIRE CONNECTIONS SHALL BE CRIMP-STYLE, COMPRESSION WIRE LUGS OR WIRENUTS. LUGS AND WIRENUTS SHALL BE RATED FOR OPERATION AT NO LESS THAN 75°C (90°C IF APPLICABLE).
- 13. CABLES SHALL NOT BE ROUTED THROUGH LADDER-STYLE CABLE TRAY RUNGS,
- 14. ELECTRICAL METALLIC TUBING (EMT) OR RIGID NONMETALLIC CONDUIT (I.E., RIGID SCHEDULE 40, OR RIGID PVC SCHEDULE 80 FOR LOCATIONS SUBJECT TO PHYSICAL DAMAGE) SHALL BE USED FOR EXPOSED INDOOR LOCATIONS.
- 15. THE NOTE, SPECIFICATION OR CODE WHICH PRESCRIBES AND ESTABLISHES THE HIGHEST STANDARD OF PERFORMANCE SHALL PREVAIL IN THE EVENT OF ANY CONFLICT OR INCONSISTENCY BETWEEN ITEMS SHOWN ON THE PLANS AND/OR SPECIFICATIONS.
- 16. ELECTRICAL METALLIC TUBING (EMT), ELECTRICAL NONMETALLIC TUBING (ENT), OR RIGID NONMETALLIC CONDUIT (RIGID PVC, SCHEDULE 40) SHALL BE USED FOR CONCEALED INDOOR LOCATIONS.
- 17. PENETRATIONS OF ALL WALLS OR CEILINGS SHALL BE SEALED AND FIRE RATING MAINTAINED IN ACCORDANCE WITH ALL LOCAL AND NATIONAL CODES.
- 18. SCHEDULE 80 PVC CONDUIT SHALL BE USED FOR OUTDOOR LOCATIONS ABOVE GRADE.
- 19. RIGID NONMETALLIC CONDUIT (I.E. RIGID PVC SCHEDULE 40 OR RIGID PVC SCHEDULE 80) SHALL BE USED UNDERGROUND; DIRECT BURIED, IN AREAS OF OCCASIONAL LIGHT VEHICLE TRAFFIC OR ENCASED IN REINFORCED CONCRETE AREAS OF HEAVY VEHICLE TRAFFIC.
- 20. ALL DETAILS/SCHEMATICS SHOWN ARE IN GENERAL TERMS. AND INSTALLATION MAY VARY DUE TO SPECIFIC SITE CONDITIONS
- 21. LIQUID-TIGHT FLEXIBLE METALLIC CONDUIT (LIQUID-TITE FLEX) SHALL BE USED INDOORS AND OUTDOORS, WHERE VIBRATION OCCURS OR FLEXIBILITY IS NEEDED.
- 22. METALLIC CONDUIT AND TUBING FITTINGS SHALL BE THREADED OR COMPRESSION—TYPE, GALVANIZED AND APPROVED FOR THE LOCATION USED. SETSCREW FITTINGS ARE NOT ACCEPTABLE MYERS™ HUBS OR APPROVED LOCKNUTS SHALL BE FITTED AT ALL BOX CONNECTIONS TO MAINTAIN NEC.
- 23. CABINETS, BOXES AND WIREWAYS SHALL BE LISTED OR LABELED FOR ELECTRICAL USE IN ACCORDANCE WITH NEMA, UL, ANSI/IEEE AND NEC.
- 24. THE CONTRACTOR AGREES THAT, IN ACCORDANCE WITH GENERALLY ACCEPTED CONSTRUCTION PRACTICES, THE CONTRACTOR SHALL BE REQUIRED TO ASSUME SOLE AND COMPLETE RESPONSIBILITY FOR THE JOB SITE CONDITIONS DURING THE COURSE OF CONSTRUCTION OF THIS PROJECT. THE CONTRACTOR FURTHER AGREES TO DEFEND, INDEMNITY AND HOLD OWNER AND ENGINEER HARMLESS FROM ANY AND ALL LIABILITY, REAL OR ALLEGED, IN CONNECTION WITH THE PERFORMANCE OF WORK O THIS PROJECT.
- 25. WIREWAYS SHALL BE EPOXY—COATED (GRAY) AND INCLUDE A HINGED COVER, DESIGNED TO SWING OPEN DOWNWARD: SHALL BE PANDUIT TYPE E (OR EQUAL); AND RATED NEMA 1 (OR BETTER) UNDOORS, OR NEMA 3R (OR BETTER) OUTDOORS.
- 26. EQUIPMENT CABINETS, TERMINAL BOXES, JUNCTION BOXES AND PULL BOXES SHALL BE GALVANIZED OR EPOXY-COATED SHEET STEEL, SHALL MEET OR EXCEED UL 50 AND RATED NEMA 1 (OR BETTER) INDOORS, OR NEMA 3R (OR BETTER) OUTDOORS.
- 27. RECEPTACLES, SWITCH AND DEVICE BOXES SHALL BE PVC OR GALVANIZED, EPOXY-COATED, OR NON-CORRODING; SHALL MEET OR EXCEED UL 514A AND NEMA OS 1; AND RATED NEMA 1 (OR BETTER) INDOORS, OR WEATHER PROTECTED (WP OR BETTER) OUTDOORS.
- 28. NONMETALLIC RECEPTACLE, SWITCH AND DEVICE BOXES SHALL MEET OR EXCEED NEMA OS 2; AND RATED NEMA 1 (OR BETTER) INDOORS, OR WEATHER PROTECTED (WP OR BETTER) OUTDOORS.
- 29. THE SUBCONTRACTOR SHALL BE PROVIDE NECESSARY TAGGING ON THE BREAKERS, CABLES AND DISTRIBUTION PANELS IN ACCORDANCE WITH THE APPLICABLE CODES AND STANDARDS TO SAFEGUARD AGAINST LIFE AND PROPERTY.
- 30. ALL ENTRIES TO EQUIPMENT ASSOCIATED WITH THE FIXED GENERATOR PROJECT SHALL BE SEALED TO KEEP WATER OUT.







SAN CLEMENTE CA 92673 (949) 391-6824

DRAWN BY: CP
CHECKED BY: MM

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5	01/31/2025	100% CD'S FOR SUBMITTAL
4	01/03/2025	100% CD'S FOR SUBMITTAL
3	04/06/2023	100% CD'S PER NEW DESIGN
2	03/22/2023	100% CD'S FOR SUBMITTAL
1	01/04/2023	100% ZD'S PER JX COMMENTS
0	05/12/2022	100% ZD'S FOR REVIEW
Α	04/13/2022	90% ZD'S FOR REVIEW
REV	DATE	DESCRIPTION

IT IS A VIOLATION OF LAW FOR ANY PERSON, UNLESS THEY ARE ACTING UNDER THE DIRECTION OF A LICENSI PROFESSIONAL ENGINEER, TO ALTER THIS DOCUMENT.


ANCHOR/L600 MODIFICATION SITE ID: SD06045A SD045 HELIX WATER DISTRICT 13002 HIGHWAY 8 BUSINESS EL CAJON, CA 92021 WATER TANK

SHEET TITLE

ELECTRICAL METER ROOM
& ELECTRICAL NOTES

SHEET NUMBER

E-2

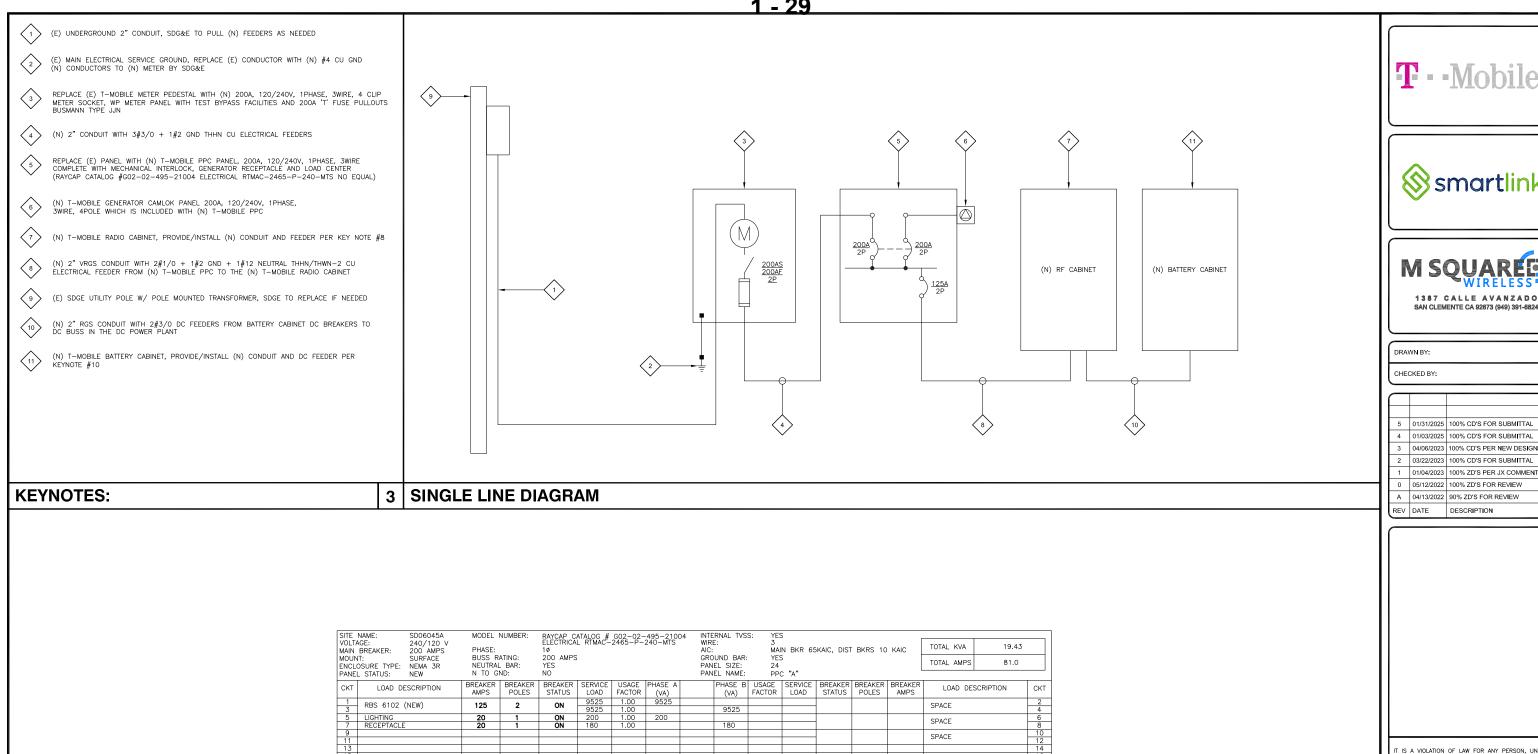

PPC PANEL LOAD SCHEDULE





CHECKED BY: MM

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		5	01/31/2025	100% CD'S FOR SUBMITTAL
	П	4	01/03/2025	100% CD'S FOR SUBMITTAL
	П	3	04/06/2023	100% CD'S PER NEW DESIGN
	П	2	03/22/2023	100% CD'S FOR SUBMITTAL
	П	1	01/04/2023	100% ZD'S PER JX COMMENTS
	П	0	05/12/2022	100% ZD'S FOR REVIEW
	П	Α	04/13/2022	90% ZD'S FOR REVIEW
_		REV	DATE	DESCRIPTION

IT IS A VIOLATION OF LAW FOR ANY PERSON, UNLESS THEY ARE ACTING UNDER THE DIRECTION OF A LICENSE PROFESSIONAL ENGINEER, TO ALTER THIS DOCUMENT.

ANCHOR/L600 MODIFICATION SITE ID: SD06045A SD045 HELIX WATER DISTRICT 13002 HIGHWAY 8 BUSINESS EL CAJON, CA 92021 WATER TANK

SHEET TITLE

SINGLE LINE DIAGRAM AND PANEL SCHEDULE

SHEET NUMBER

E-3







1387 CALLE AVANZADO SAN CLEMENTE CA 92673 (949) 391-6824

Í	DRAWN BY:	СР
	CHECKED BY:	ММ

(
5	01/31/2025	100% CD'S FOR SUBMITTAL
4	01/03/2025	100% CD'S FOR SUBMITTAL
3	04/06/2023	100% CD'S PER NEW DESIGN
2	03/22/2023	100% CD'S FOR SUBMITTAL
1	01/04/2023	100% ZD'S PER JX COMMENTS
0	05/12/2022	100% ZD'S FOR REVIEW
Α	04/13/2022	90% ZD'S FOR REVIEW
REV	DATE	DESCRIPTION

IT IS A VIOLATION OF LAW FOR ANY PERSON, UNLESS THEY ARE ACTING UNDER THE DIRECTION OF A LICENSED PROFESSIONAL ENGINEER, TO ALTER THIS DOCUMENT.


ANCHOR/L600 MODIFICATION SITE ID: SD06045A SD045 HELIX WATER DISTRICT 13002 HIGHWAY 8 BUSINESS EL CAJON, CA 92021 WATER TANK


SHEET TITLE

SDG&E SERVICE ORDER

SHEET NUMBER

E-4

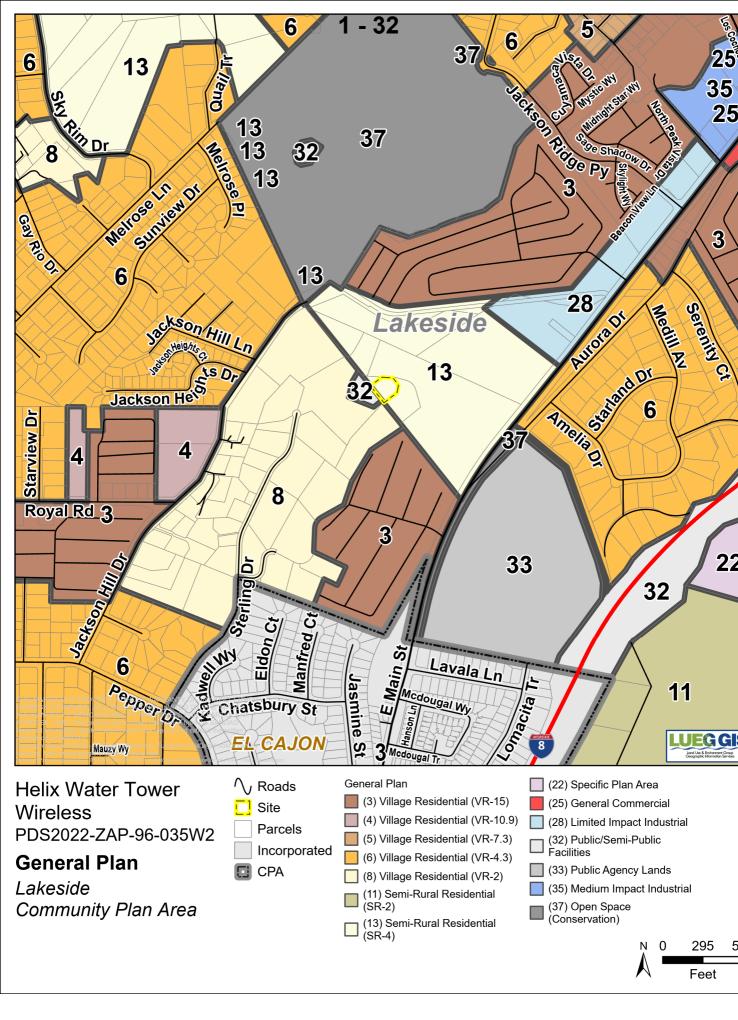

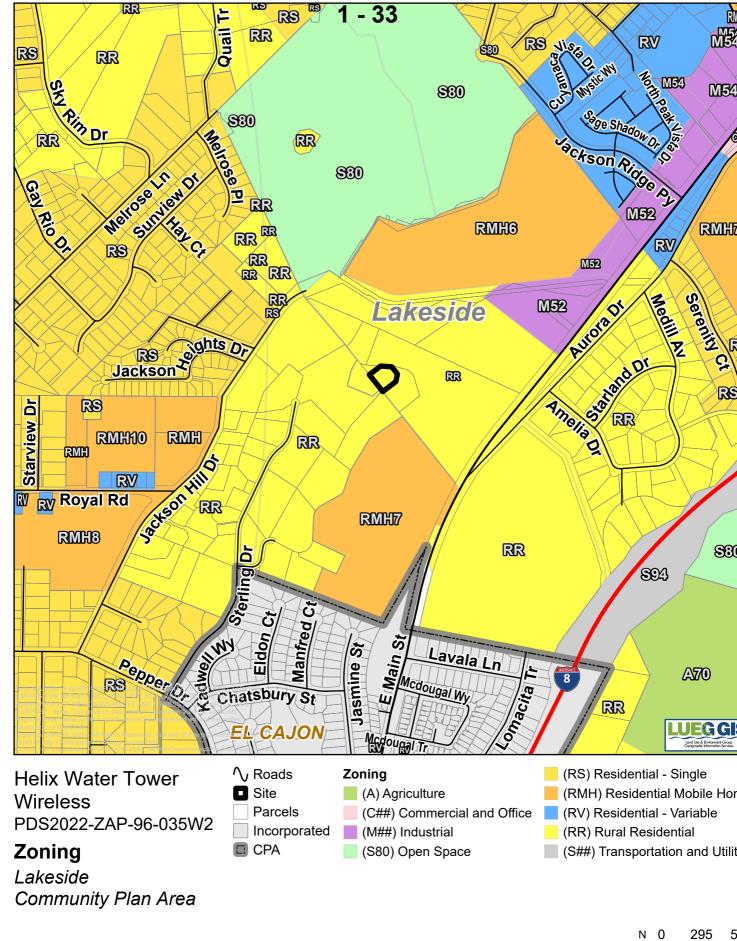



Attachment B Form of Decision



VINCE NICOLETTI PLANNING & DEVELOPMENT SERVICES

DIRECTOR 5510 OVERLAND AVENUE, SUITE 210, SAN DIEGO, CALIFORNIA 92123
(858) 505-6445 General • (858) 694-2705 Codes Compliance
(858) 565-5920 Building Services

TYLER FARMER
ASSISTANT DIRECTOR

October 16, 2025

PERMITTEE: T-MOBILE

MINOR USE PERMIT:

 Modification:
 PDS2022-ZAP-96-035W2

 E.R. Number:
 PDS2022-ER-96-14-027B

PROPERTY: 13002 I-8BUSINESS WITHIN THE LAKESIDE COMMUNITY

PLANNING AREA WITHIN UNINCORPORATED COUNTY OF SAN

DIEGO

APN: 400-060-03-00

DECISION OF THE ZONING ADMINISTRATOR

ORIGINAL MINOR USE PERMIT DECISION (3400-96-035)

To GRANT, in substantial conformance with the replacement plot plan dated September 25, 1996, consisting of 3 sheets and approved concurrently herewith, a Minor Use Permit to authorize the construction, operation and maintenance of a wireless communication antenna facility. The minor impact utility will consist of 1 monopole support structure, 6 panel antennas, and 2 base transceiver stations. Total height of structure will 50 feet 5 inches. The facility will be located adjacent to an existing Helix Water District storage reservoir.

MODIFICATION TO MINOR USE PERMIT DECISION (ZAP-96-035W1)

Grant This Minor Use Permit Modification for an unmanned wireless telecommunication facility consists of thirteen (13) sheets including plot plan and elevations dated November 14. 2018. This permit authorizes the construction. operation and maintenance of a 50-foot, 5-inch faux monopalm wireless telecommunications facility and associated equipment pursuant to Section 6985, 6986. and 7358 of the Zoning Ordinance.

MODIFICATION TO MINOR USE PERMIT DECISION (ZAP-96-035W2)

This Minor Use Permit Modification for ZAP-96-035W2 consists of 8 sheets including plot plan, equipment layout, and elevations dated October 16, 2025. This permit authorizes the renewal of an existing wireless telecommunication facility, by removing the current T-Mobile monopole and its associated equipment and mounting the new equipment onto the existing Helix Water District water tank. The modification includes the installation of new antennas and associated equipment.

ZAP-96-035W2 2 October 16, 2025

Wireless telecommunication facilities subject to this Minor Use Permit Modification are considered "high visibility" facilities, therefore, pursuant to Section 6985(c)(11) of the Zoning Ordinance, this Minor Use Permit shall have a maximum term of 10 years (ending October 16, 2035, at 4:00 p.m.). This may be extended for an additional period of time through modification of this permit if it is found that no smaller or less visible technology is available or feasible to replace the facility at that time. All wireless telecommunication facilities subject to this Minor Use Permit shall be reviewed for conformance with the amortization requirements outlined in Sections 6985 and 6991 of the Zoning Ordinance through the modification of this permit.

MINOR USE PERMIT MODIFICATION EXPIRATION: This Minor Use Permit shall expire on October 16, 2027 at 4:00 p.m. (or such longer period as may be approved pursuant to Section 7376 of The Zoning Ordinance of the County of San Diego prior to said expiration date) unless construction or use in reliance on this Minor Use Permit has commenced prior to said expiration date.

SPECIFIC CONDITIONS: Compliance with the following Specific Conditions (Mitigation Measures when applicable) shall be established before the property can be used in reliance upon this Minor Use Permit. Where specifically indicated, actions are required prior to approval of any grading, improvement, building plan and issuance of grading, construction, building, or other permits as specified:

SPECIFIC CONDITIONS FOR ZAP-96-035(3400-96-035):

Building permit plans must conform in detail to this approved design. Failure to conform can cause delay to or denial of building permits and required formal amendment of this approved design. No waiver of the Uniform Building Code standards or any other code is intended or implied.

The following conditions are imposed by the granting of this Minor Use Permit:

- A. Prior to obtaining any building permit pursuant to this Minor Use Permit, and prior to commencement of construction or use of the property in reliance on this Minor Use permit, the applicant shall:
 - Pay off all existing deficit accounts associated with the processing of this application to the satisfaction of the Department of Planning and Land Use. [CONDITION SATISFIED]
- B. Upon certification by the Director of Planning and Land Use for occupancy or establishment of use allowed by this Minor Use Permit, the following conditions shall apply:
 - 1. The parking areas and driveways shall be well maintained.

ZAP-96-035W2 3 October 16, 2025

- 2. All landscaping shall be adequately watered and well maintained at all times. Dead plants and malfunctioning irrigation systems shall be promptly replaced.
- 3. This Minor Use Permit shall expire on October 4, 1997; at 4:00 p.m. unless construction or use in reliance on, this Minor Use Permit has commenced prior to said expiration date.

SPECIFIC CONDITIONS FOR ZAP-96-035W1: Compliance with the following Specific Conditions (Mitigation Measures when applicable) shall be established before the property can be used in reliance upon this Minor Use Permit Modification. Where specifically indicated, actions are required prior to approval of any grading, improvement, building plan and issuance of grading, construction, building, or other permits as specified:

ANY PERMIT: (Prior to the approval of any plan, issuance of any permit, and prior to occupancy or use of the premises in reliance of this permit).

- 1. GEN#1-COST RECOVERY: [PDS, DPW, DEH, DPR], [GP, CP, BP, UO] INTENT: In order to comply with Section 362 of Article XX of the San Diego County Administrative Code, Schedule B.5, existing deficit accounts associated with processing this permit shall be paid. DESCRIPTION OF REQUIREMENT: The applicant shall pay off all existing deficit accounts associated with processing this permit. DOCUMENTATION: The applicant shall provide a receipt to Planning & Development Services, Zoning Counter, which shows that all discretionary deposit accounts have been paid. No permit can be issued if there are deficit deposit accounts. TIMING: Prior to the approval of any plan and prior to the issuance of any permit and prior to use in reliance of this permit, all fees and discretionary deposit accounts shall be paid. MONITORING: The PDS Zoning Counter shall review the receipts and verify that all PDS, DPW, DEH, and DPR deposit accounts have been paid.
- 2. GEN #2-RECORDATION OF DECISION: [PDS], [GP, CP, BP, UO] INTENT: In order to comply with Section 7019 of the Zoning Ordinance, the Permit Decision shall be recorded to provide constructive notice to all purchasers, transferees, or other successors to the interests of the owners named, of the rights and obligations created by this permit. DESCRIPTION OF REQUIREMENT: The applicant shall sign, notarize with an 'all purpose acknowledgement' and return the original Recordation Form to PDS. DOCUMENTATION: Signed and notarized original Recordation Form. TIMING: Prior to the approval of any plan and prior to the issuance of any permit and prior to use in reliance of this permit, a signed and notarized copy of the Decision shall be recorded by PDS at the County Recorder's Office. MONITORING: The PDS Zoning Counter shall verify that the Decision was recorded and that a copy of the recorded document is on file at PDS.

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OCCUPANCY: (Prior to any occupancy, final grading release, or use of the premises in reliance of this permit).

3. GEN#3-INSPECTION FEE

INTENT: In order to comply with Zoning Ordinance Section 7362.e the inspection fee shall be paid. **DESCRIPTION OF REQIREMENT**: Pay the inspection fee at the [PDS, ZC] to cover the cost of inspection(s) of the property to monitor ongoing conditions associated with this permit. In addition, submit a letter indicating who should be contacted to schedule the inspection. **DOCUMENTATION**: The applicant shall provide a receipt showing that the inspection fee has been paid along with updated contact information [PDS, PCC]. **TIMING**: Prior to any occupancy, final grading release, or use of the premises in reliance of this permit. **MONITORING**: The [PDS, ZC] shall process an invoice and collect the fee. PDS will schedule an inspection within one year from the date that occupancy or use of the site was established.

4. PLN#1-PHOTO SIMULATION: [PDS, PCC] [UO, FG] [PDS, FEE]

INTENT: In order to verify that the site complies with the County Zoning Ordinance Section 6980 through 6991 (Wireless Telecommunications Section), the site shall substantially comply with the approved plot plans and photo-simulations. DESCRIPTION OF REQUIREMENT: The site shall be built to substantially comply with the approved photo-simulations to ensure that the site was built to be screened from public view. DOCUMENTATION: The applicant shall build the site to comply with the approved plans and the photo-simulations. Upon completion, the applicant shall provide the photographic evidence to the [PDS, PCC] for review. TIMING: Prior to any occupancy, final grading release, or use of the premises in reliance of this permit, the site shall be built to match the approval. MONITORING: The [PDS, PCC] shall review the provided photos for compliance with this condition and compliance with the photo-simulations.

5. PLN#2-SITE CONFORMANCE (WIRELESS)

INTENT: In order to verify that the site complies with the County Zoning Ordinance Section 6980 through 6991 (Wireless Telecommunications Section). the site shall substantially comply with the approved plot plans. **DESCRIPTION OF REQUIREMENT:** The site shall be built to substantially comply with the approved plot plans. **DOCUMENTATION:** The applicant shall build the site to comply with the approved plans. Upon completion, the applicant shall provide the photographic evidence to the [PDS, PCC] for review. **TIMING:** Prior to any occupancy, final grading release. or use of the premises in reliance of this permit, the site shall be built to match the approval. **MONITORING:** The [PDS, PCC] shall review the provided photos for compliance with this condition and compliance with the approved plot plans.

6. PLN#3-SITE PLAN IMPLEMENTATION: [PDS, BI] [UO] [DPR, TC, PP]. INTENT: In order to comply with the approved project design indicated on the approved plot plan, the project shall be constructed as indicated on the approved

ZAP-96-035W2 5 October 16, 2025

building and construction plans. **DESCRIPTION OF REQUIREMENT:** The site shall conform to the approved plot plan and the building plans. This includes, but is not limited to: installing all required design features and landscaping, painting all structures with the approved colors, and all temporary construction facilities have

been removed from the site. **DOCUMENTATION:** The applicant shall ensure that the site conforms to the approved plot plan and building plans. **TIMING:** Prior to any occupancy, final grading release, or use of the premises in reliance of this permit, the site shall conform to the approved plans. **MONITORING:** The *[PDS, Building Inspector]* and DPR [TC, PP] shall inspect the site for compliance with the approved Building Plans.

7. HAZ#1-HEALTH AND SAFETY PLAN: [DEH, HMD] [UO, FG]

INTENT: In order to protect workers from hazardous chemicals and to notify the public of potential hazardous chemicals and substances and to comply with the California Health and Safety Code, Chapter 6.95. a hazardous materials Business plan shall be prepared and implemented. DESCRIPTION OF REQUIREMENT: The applicant of the facility shall obtain all necessary permits for the storage, handling. and disposal of the hazardous materials as required by the Department of Environmental Health-Hazardous Materials Division. The plan shall be approved by [DEH, HMD]. The Hazardous Materials Division, Plan Check section contact is Joan Swanson, (858) 505-6880 or by email at joan.swanson@sdcounty.ca.gov. TIMING: Prior to occupancy of the first structure built in association with this permit, the Health and Safety Plan, and Hazardous Materials Business Plan shall be prepared, approved and implemented. MONITORING: [DEH, HMD] shall verify and approve the Health and Safety Plan, and Hazardous Materials Business Plan for compliance with this condition.

8. ROADS#1-SIGHT DISTANCE

INTENT: In order to provide an unobstructed view for safety while exiting the property and accessing a public road from the site, and to comply with the Design Standards of Section 6.1.E of the County of San Diego Public Road Standards, an unobstructed sight distance shall be verified. **DESCRIPTION OF REQUIREMENT:**

a.	A registered civil engineer or a licensed land surveyor provides a certified
	signed statement that: 'There is feet of unobstructed intersectional
	sight distance in the both directions from the project access driveway
	along Old Highway Business 8 in accordance with the methodology
	described in Table 5 of the March 2012 County of San Diego Public Road
	Standards. These sight distances exceed the required intersectional Sight
	Distance requirements of as described in Table 5 based on a speed
	of,which I have verified to be the higher of the prevailing speed or
	the minimum design speed of the road classification. I have exercised
	responsible charge for the certification as defined in Section 6703 of the
	Professional Engineers Act of the California Business and Professions
	Code."

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b. If the lines of sight fall within the existing public road right-of-way, the engineer or surveyor shall further certify: "Said lines of sight fall within the existing right-of-way and a clear space easement is not required."

DOCUMENTATION: The applicant shall complete the certifications and submit them to the [POS. LOR] for review. TIMING: Prior to occupancy of the first structure built in association with this permit, or use of the premises in reliance of this permit, and annually after that until the project is completely built, the sight distance shall be verified. MONITORING: The [PDS, LDR] shall verify the sight distance certifications for compliance with this condition.

ONGOING: (The following conditions shall apply during the term of this permit).

9. PLN#4-SITE CONFORMANCE: [PDS, PCO] [OG] [DPR, TC, PP].

INTENT: In order to comply with Zoning Ordinance Section 7703, the site shall substantially comply with the approved plot plans and all deviations thereof, specific conditions and approved building plans. **DESCRIPTION REQUIREMENT:** The project shall conform to the approved landscape plan(s), building plans, and plot plan(s). This includes, but is not limited to maintaining the following: painting all necessary aesthetics design features, and all lighting wall/fencing. Failure to conform to the approved plot plan(s); is an unlawful use of the land, and will result in enforcement action pursuant to Zoning Ordinance Section 7703. **DOCUMENTATION:** The property owner and permittee shall conform to the approved plot plan. If the permittee or property owner chooses to change the site design in any away, they must obtain approval from the County for a Minor Deviation or a Modification pursuant to the County of San Diego Zoning Ordinance. Any interior changes to approved telecommunications equipment that are located entirely within an approved enclosed equipment shelter, with equipment that cannot be seen by an adjacent residence, parcel or roadway, shall not require Modification or Deviation of the permit, to the satisfaction of the Director of Planning and Development Services (expansion of the existing approved equipment shelter and/or addition of noise generating equipment would require either Modification or Deviation of the permit TIMING: Upon establishment of the use, this condition shall apply for the duration of the term of this permit. MONITORING: The [PDS, Code Enforcement Division] is responsible for enforcement of this permit.

10. PLN#5-SITE CONFORMANCE (WIRELESS): [PDS, PCO] [OG].

INTENT: In order to comply with the County Zoning Ordinance Section 6980 through 6991 (Wireless Telecommunications Section), the site shall substantially comply with the requirements of this condition. **DESCRIPTION OF REQUIREMENT:** The project shall conform to the following requirements. This includes, but is not limited to maintaining the following:

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- a. Maintain the appearance of the facility. landscaping. and associated equipment shelter, as depicted in the approved photo simulations dated 4/17/2018. Any interior changes to approved telecommunications equipment that are located entirely within an approved enclosed equipment shelter, with equipment that cannot be seen by an adjacent residence. parcel or roadway. shall not require Modification or Deviation of the permit. to the satisfaction of the Director of Planning and Development Services (expansion of the existing approved equipment shelter and/or addition of noise generating equipment would require either Modification or Deviation of the permit).
- b. All graffiti on any components of the facility shall be removed promptly in accordance with County regulations. Graffiti on any facility in the public right-of-way must be removed within 48 hours of notification.
- c. All wireless telecommunications sites including antennae and cabinets shall be kept clean and free of litter, display a legible operator's contact number for reporting maintenance problems, and be secured to prohibit unauthorized access.
- d. Wireless telecommunications facilities with use discontinued shall be considered abandoned 90 days following the final day of use. All abandoned facilities shall be physically removed by the facility owner no more than 90 days following the final day of use or determination that the facility has been abandoned, whichever occurs first. All wireless carriers who intend to abandon or discontinue the use of any wireless telecommunications facility shall notify the County of such intention no less than 60 days before the final day of use. The County reserves the right to remove any facilities that are abandoned for more than 90 days at the expense of the facility owner. Any abandoned site shall be restored to its natural or former condition. Grading and landscaping in good condition may remain.

DOCUMENTATION: The property owner and applicant shall conform to the ongoing requirements of this condition. Failure to conform to the approved plot plan(s); is an unlawful use of the land, and will result in enforcement action pursuant to Zoning Ordinance Section 7703. **TIMING:** Upon establishment of the use, this condition shall apply for the duration of the term of this permit. **MONITORING:** The *[PDS, Code Enforcement Division]* is responsible for enforcement of this permit.

11. ROADS#2-PRIVATE ROAD MAINTENANCE

INTENT: In order to ensure that the on- and off-site private easement roads, are maintained and repaired if damaged during construction and during the term of the permit, the applicant shall assume responsibility. **DESCRIPTION OF REQUIREMENT:** The applicant is responsible for the repair of any damage caused

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by this Project during construction and the term of this permit to on- and off-site private easement roads that serve the Project. During the term of the permit, the owner(s) of the private road easement(s) shall share proportionately to the use made of the easement(s) that serve the Project, pursuant to California Civil Code Section 845. **DOCUMENTATION:** The applicant shall assume responsibility pursuant to this condition. **TIMING:** Upon establishment of use, this condition shall apply during the term of this permit. **MONITORING:** The [PDS, Code Enforcement Division] is responsible for enforcement of this permit.

12. ROADS#3-SIGHT DISTANCE

INTENT: In order to provide an unobstructed view for safety while exiting the property and accessing a public road from the site, and to comply with the Design Standards of Section 6.1.(E) of the County of San Diego Public Road Standards, an unobstructed sight distance shall be maintained for the life of this permit. **DESCRIPTION OF REQUIREMENT:** There shall be a minimum unobstructed sight distance per County Standards in both directions along Old Highway Business 8 from the project access opening for the life of this permit. **DOCUMENTATION:** A minimum unobstructed sight shall be maintained. The sight distance of adjacent driveways and street openings shall not be adversely affected by this project at any time. **TIMING:** Upon establishment of the use, this condition shall apply for the duration of the term of this permit. **MONITORING:** The [PDS. Code Compliance Division] is responsible for compliance of this permit.

SPECIFIC CONDITIONS FOR MINOR USE PERMIT MODIFICATION ZAP-96-035W2:

Compliance with the following Specific Conditions (Mitigation Measures when applicable) shall be established before the property can be used in reliance upon this Minor Use Permit. Please note that all applicable ongoing conditions associated with the original Minor Use Permit (ZAP-96-035) and subsequent Modifications approval shall apply. Where specifically indicated, actions are required prior to approval of any grading, improvement, building plan and issuance of grading, construction, building, or other permits as specified:

ANY PERMIT: (Within 180 days of approval or prior to the approval of any plan, issuance of any permit, prior to occupancy or use of the premises in reliance of this permit, whichever occurs first.)

1. GEN#1-COST RECOVERY: [PDS, DPW, DEH, DPR], [GP, CP, BP, UO] INTENT: In order to comply with Section 362 of Article XX of the San Diego County Administrative Code, Schedule B.5, existing deficit accounts associated with processing this permit shall be paid. DESCRIPTION OF REQUIREMENT: The applicant shall pay off all existing deficit accounts associated with processing this permit. DOCUMENTATION: The applicant shall provide a receipt to Planning & Development Services, Zoning Counter, which shows that all discretionary deposit accounts have been paid. No permit can be issued if there are deficit deposit accounts. TIMING: Prior to the approval of any plan and prior to the issuance of any permit and prior to use in reliance of this permit, all fees and discretionary

ZAP-96-035W2 9 October 16, 2025

deposit accounts shall be paid. **MONITORING:** The PDS Zoning Counter shall review the receipts and verify that all PDS, DPW, DEH, and DPR deposit accounts have been paid.

2. <u>GEN#2-RECORDATION OF DECISION: [PDS], [GP, CP, BP, UO]</u>

INTENT: In order to comply with Section 7019 of the Zoning Ordinance, the Permit Decision shall be recorded to provide constructive notice to all purchasers, transferees, or other successors to the interests of the owners named, of the rights and obligations created by this permit. **DESCRIPTION OF REQUIREMENT:** The

applicant shall sign, notarize with an 'all-purpose acknowledgement' and return the original Recordation Form to PDS. **DOCUMENTATION:** Signed and notarized original Recordation Form. **TIMING:** Prior to the approval of any plan and prior to the issuance of any permit and prior to use in reliance of this permit, a signed and notarized copy of the Decision shall be recorded by PDS at the County Recorder's Office. **MONITORING:** The PDS Zoning Counter shall verify that the Decision was recorded and that a copy of the recorded document is on file at PDS.

3. ROADS#1-SIGHT DISTANCE

INTENT: In order to provide an unobstructed view for safety while exiting the property and accessing a public road from the site, and to comply with the Design Standards of Section 6.1.(E) of the County of San Diego Public Road Standards, an unobstructed sight distance shall be verified. **DESCRIPTION OF REQUIREMENT**:

- a. A registered civil engineer or a licensed land surveyor provides a certified signed statement that: "There is feet of unobstructed intersectional sight distance in both direction(s) from the proposed driveway onto *Hwy 8 Business* a.k.a. *Old Highway 80 (SA 895)* in accordance with the methodology described in Table 5 of the March 2012 County of San Diego Public Road Standards. These sight distances exceed the required intersectional Sight Distance requirements of as described in Table 5 based on a speed of , which I have verified to be the higher of the prevailing speed or the minimum design speed of the road classification. I have exercised responsible charge for the certification as defined in Section 6703 of the Professional Engineers Act of the California Business and Professions Code."
- b. If the lines of sight fall within the existing public road right-of-way, the engineer or surveyor shall further certify: "Said lines of sight fall within the existing right-of-way and a clear space easement is not required."

DOCUMENTATION: The applicant shall complete the certifications and submit them to the [PDS, LDR] for review. **TIMING:** Prior to the approval of any plan, issuance of any permit, and prior to occupancy or use of the premises in reliance

ZAP-96-035W2 10 October 16, 2025

of this permit, the sight distance shall be verified. **MONITORING:** The [*PDS*, *LDR*] shall verify the sight distance certifications.

OCCUPANCY: (Within 270 days or prior to any occupancy, final grading release, or use of the premises in reliance of this permit, whichever occurs first.)

4. GEN#3-INSPECTION FEE

INTENT: In order to comply with Zoning Ordinance Section 7362.e the inspection fee shall be paid. **DESCRIPTION OF REQIREMENT:** Pay the inspection fee at the *[PDS, ZC]* to cover the cost of inspection(s) of the property to monitor ongoing conditions associated with this permit. In addition, submit a letter indicating who should be contacted to schedule the inspection. **DOCUMENTATION:** The

applicant shall provide a receipt showing that the inspection fee has been paid along with updated contact information [PDS, PCC]. **TIMING:** Prior to any occupancy, final grading release, or use of the premises in reliance of this permit. **MONITORING:** The [PDS, ZC] shall process an invoice and collect the fee. PDS will schedule an inspection within one year from the date that occupancy or use of the site was established.

5. PLN#2- REMOVAL OF EXISTING TEMPORARY FACILITIES, MONOPOLES AND EQUIPMENT: [PDS, PCC] [UO, FG] [PDS, FEE]

INTENT: In order to verify that the site complies with the County Zoning Ordinance Section 6980 through 6991 (Wireless Telecommunications Section), the monopoles, temporary equipment, and associated equipment shall be removed, including all equipment on the poles, as shown on sheet A-1.1 of the approved plot plan. DESCRIPTION OF REQUIREMENT: The existing monopoles and associated supporting equipment shall be removed from the site as identified on sheet A-1.1 the approved plans. DOCUMENTATION: The applicant shall provide photos and a signed letter from the contractor that states all equipment shown to be removed on sheet A-1.1 of the approved plot plan has been removed from the site. This written and photographic evidence shall be submitted to the [PDS, PCC] for review. TIMING: Prior to any occupancy, final grading release, or use of the premises in reliance of this permit. MONITORING: The [PDS, PCC] shall review the provided photos and letter for compliance with this condition.

6. PLN#3-PHOTO SIMULATION (WIRELESS): [PDS, PCC] [UO, FG] [PDS, FEE] INTENT: In order to verify that the site complies with the County Zoning Ordinance Section 6980 through 6991 (Wireless Telecommunications Section), the site shall substantially comply with the approved plot plans and photo-simulations. DESCRIPTION OF REQUIREMENT: The site shall be built to substantially comply with the approved photo-simulations and photo surveys dated 11/16/2023 to ensure that the site was built to be screened from public view. DOCUMENTATION: The applicant shall build the site to comply with the approved plans and the photo-simulations. Upon completion, the applicant shall provide the photographic evidence to the [PDS, PCC] for review. TIMING: Prior to any occupancy, final

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grading release, or use of the premises in reliance of this permit, the site shall be built to match the approval. **MONITORING:** The [PDS, PCC] and DPR [TC, PP] shall review the provided photos for compliance with this condition and compliance with the photo-simulations.

7. PLN#3-SITE CONFORMANCE (WIRELESS)

INTENT: In order to verify that the site complies with the County Zoning Ordinance Section 6980 through 6991 (Wireless Telecommunications Section), the site shall substantially comply with the approved plot plan and photo simulation. DESCRIPTION OF REQUIREMENT: The site shall be built to substantially comply with the approved plot plan and photo simulation. DOCUMENTATION: The applicant shall build the site to comply with the approved plan and photo simulation. Upon completion, the applicant shall provide the photographic evidence to the [PDS, PCC] for review. TIMING: Prior to any occupancy, final

grading release, or use of the premises in reliance of this permit, the site shall be built to match the approval. **MONITORING:** The [PDS, PCC] and DPR [TC, PP] shall review the provided photos for compliance with this condition and compliance with the approved plot plans.

8. PLN#4-SITE PLAN IMPLEMENTATION: [PDS, BI] [UO] [DPR, TC, PP].

INTENT: In order to comply with the approved project design indicated on the approved plot plan, the project shall be constructed as indicated on the approved building and construction plans. DESCRIPTION OF REQUIREMENT: The site shall conform to the approved plot plan and the building plans. This includes, but is not limited to: installing all required design features, painting all structures with the approved colors, and all temporary construction facilities have been removed from the site. **DOCUMENTATION:** The applicant shall ensure that the site conforms to the approved plot plan and building plans. Any interior changes to approved telecommunications equipment that are located entirely within an approved enclosed equipment shelter, with equipment that cannot be seen by an adjacent residence, parcel or roadway, shall not require Modification or Deviation of the permit, to the satisfaction of the Director of Planning and Development Services (expansion of the existing approved equipment shelter and/or addition of noise generating equipment would require either Modification or Deviation of the permit). TIMING: Prior to any occupancy, final grading release, or use of the premises in reliance of this permit, the site shall conform to the approved plans. MONITORING: The IPDS, Building Inspector and DPR ITC, PPI shall inspect the site for compliance with the approved Building Plans.

9. <u>HAZ#1-HE</u>ALTH AND SAFETY PLAN

INTENT: In order to protect workers from hazardous chemicals and to notify the public of potential hazardous chemicals and substances and to comply with the California Health and Safety Code, Chapter 6.95, the applicant shall receive approval from the Department of Environmental Health. **DESCRIPTION OF REQUIREMENT**: The applicant of the facility shall obtain all necessary permits

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for the storage, handling, and disposal of the hazardous materials as required by the Department of Environmental Health-Hazardous Materials Division. The plan shall be approved by [DEH, HMD]. **TIMING:** Prior to occupancy of the first structure built in association with this permit, the Health and Safety Plan, and Hazardous Materials Business Plan shall be prepared, approved and implemented. **MONITORING:** [DEH, HMD] shall verify and approve all compliance with this condition.

ONGOING: (The following conditions shall apply during the term of this permit).

10. PLN#5-SITE CONFORMANCE: [PDS, PCO] [OG] [DPR, TC, PP].

INTENT: In order to comply with Zoning Ordinance Section 7703, the site shall substantially comply with the approved plot plans and all deviations thereof. specific conditions and approved building plans. DESCRIPTION OF **REQUIREMENT:** The project shall conform to the approved building plans, and plot plan. This includes, but is not limited to maintaining the following: installing all required design features, painting all structures with the approved colors, and all temporary construction facilities have been removed from the site. Failure to conform to the approved plot plan(s) is an unlawful use of the land, and will result in enforcement action pursuant to Zoning Ordinance Section 7703. **DOCUMENTATION:** The property owner and permittee shall conform to the approved plot plan. If the permittee or property owner chooses to change the site design in any away, they must obtain approval from the County for a Minor Deviation or a Modification pursuant to the County of San Diego Zoning Ordinance. Any interior changes to approved telecommunications equipment that are located entirely within an approved enclosed equipment shelter, with equipment that cannot be seen by an adjacent residence, parcel or roadway, shall not require Modification or Deviation of the permit, to the satisfaction of the Director of Planning and Development Services (expansion of the existing approved equipment shelter and/or addition of noise generating equipment would require either Modification or Deviation of the permit). TIMING: Upon establishment of the use, this condition shall apply for the duration of the term of this permit. MONITORING: The [PDS, Code Enforcement Division] is responsible for enforcement of this permit.

11. PLN#6-SITE CONFORMANCE (WIRELESS): [PDS, PCO] [OG].

INTENT: In order to comply with the County Zoning Ordinance Section 6980 through 6991 (Wireless Telecommunications Section), the site shall substantially comply with the requirements of this condition. **DESCRIPTION OF REQUIREMENT**: The project shall conform to the following requirements. This includes, but is not limited to maintaining the following:

a. Maintain the appearance of the facility and associated equipment shelter, as depicted in the approved photo simulations and photo surveys dated 4/18/2025. Any interior changes to approved telecommunications equipment that are located entirely within an approved enclosed equipment

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shelter, with equipment that cannot be seen by an adjacent residence, parcel or roadway, shall not require Modification or Deviation of the permit, to the satisfaction of the Director of Planning and Development Services (expansion of the existing approved equipment shelter and/or addition of noise generating equipment would require either Modification or Deviation of the permit).

- b. All graffiti on any components of the facility shall be removed promptly in accordance with County regulations. Graffiti on any facility in the public right-of-way must be removed within 48 hours of notification.
- c. All wireless telecommunications sites including antennae and cabinets shall be kept clean and free of litter, display a legible operator's contact number for reporting maintenance problems, and be secured to prohibit unauthorized access.
- d. Wireless telecommunications facilities with use discontinued shall be

considered abandoned 90 days following the final day of use. All abandoned facilities shall be physically removed by the facility owner no more than 90 days following the final day of use or determination that the facility has been abandoned, whichever occurs first. All wireless carriers who intend to abandon or discontinue the use of any wireless telecommunications facility shall notify the County of such intention no less than 60 days before the final day of use. The County reserves the right to remove any facilities that are abandoned for more than 90 days at the expense of the facility owner. Any abandoned site shall be restored to its natural or former condition. Grading and landscaping in good condition may remain. This period can be extended based on provided documentation to the satisfaction of the Director of DPR and the Director of PDS.

DOCUMENTATION: The property owner and applicant shall conform to the ongoing requirements of this condition. Failure to conform to the approved plot plan(s); is an unlawful use of the land, and will result in enforcement action pursuant to Zoning Ordinance Section 7703. TIMING: Upon establishment of the use, this condition shall apply for the duration of the term of this permit.

MONITORING: The [PDS, Code Enforcement Division] is responsible for enforcement of this permit.

12. NOISE#1-ON-GOING SOUND LEVEL COMPLIANCE: [PDS, CODES] [OG]
INTENT: In order to comply with the applicable sections of Title 3, Division 6,
Chapter 4 (County of San Diego Noise Ordinance), the site shall comply with the
requirements of this condition. DESCRIPTION OF REQUIRMENT: The project
shall conform to the following requirements: Minor Use Permit associated activities
shall comply with the one-hour average sound level limit property line requirement
pursuant to the County Noise Ordinance, Section 36.404. This includes (but not

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limited to) generator and air conditioner units. **DOCUMENTATION:** The property owner(s) and applicant shall conform to the ongoing requirements of this condition. Failure to conform to this condition may result in disturbing, excessive or offensive noise interfering with a person's right to enjoy life and property and is detrimental to the public health and safety pursuant to the applicable sections of Chapter 4. **TIMING:** Upon establishment of the use, this condition shall apply for the duration of the term of this permit. **MONITORING:** The [PDS, CODES] is responsible for enforcement of this permit.

13. ROADS#2-SIGHT DISTANCE : [PDS, CODES] [OG]

INTENT: In order to ensure that the on- and off-site private easement roads, are maintained and repaired if damaged during construction and during the term of the permit, the applicant shall assume responsibility. DESCRIPTION OF REQUIREMENT: The applicant is responsible for the repair of any damage caused by this Project during construction and the term of this permit to on- and off-site private easement roads that serve the Project. During the term of the permit, the owner(s) of the private road easement(s) shall share proportionately to the use made of the easement(s) that serve the Project, pursuant to California Civil Code Section 845. DOCUMENTATION: The applicant shall assume responsibility

pursuant to this condition. **TIMING:** Upon establishment of use, this condition shall apply during the term of this permit. **MONITORING:** The [PDS, Code Enforcement Division] is responsible for enforcement of this permit

14. ROADS #3-SIGHT DISTANCE

INTENT: In order to provide an unobstructed view for safety while exiting the property and accessing a public road from the site, and to comply with the Design Standards of Section 6.1.(E) of the County of San Diego Public Road Standards, an unobstructed sight distance shall be maintained for the life of this permit. **DESCRIPTION OF REQUIREMENT:**

- a. There shall be a minimum unobstructed sight distance of 300 feet in both directions along *Jackson Hill Drive* from the project driveway openings for the life of this permit.
- b. There shall be a minimum unobstructed sight distance of 400 feet in both directions along *Hwy 8 Business* a.k.a. *Old Highway 80 (SA 895)* from the project driveway openings for the life of this permit.

<u>DOCUMENTATION</u>: A minimum unobstructed sight shall be maintained. The sight distance of adjacent driveways and street openings shall not be adversely affected by this project at any time. **TIMING**: Upon establishment of the use, this condition shall apply for the duration of the term of this permit. **MONITORING**: The [PDS, Code Compliance Division] is responsible for compliance of this permit.

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FINDINGS FOR MINOR USE PERMIT MODIFICATION PDS2022-ZAP-96-035W2

<u>Pursuant to Section 7358 of The Zoning Ordinance, the following findings in support of</u> the granting of the Minor Use Permit Modification are made:

- (a) The location, size, design, and operating characteristics of the proposed use will be compatible with adjacent uses, residents, buildings, or structures with consideration given to
 - 1. Harmony in scale, bulk, coverage, and density

Harmony:

The current wireless telecommunications facility consists of a 50-foot, 5-inch monopole. The proposed change involves removing the monopole and relocating the antennas to an existing water tank. This design brings the structure into alignment with other existing facilities on the site. The project, as designed, is camouflaged to blend into the project site, which will significantly reduce adverse visual impacts to the surrounding area. Given that the surrounding structures and objects primarily consist of residential homes and vegetation, the project is entirely compatible with this surrounding residential land use.

Scale and Bulk:

The subject and surrounding area can primarily be characterized as residential, with the presence of two large water tanks already defining the landscape. The wireless facility is currently attached to a standalone 50-foot, 5-inch monopole, which unfortunately adds a distinct, vertical element to the area.

Mounting of the antennas and equipment onto the existing water tank, which significantly reduces the visual bulk and profile of the facility. The equipment will become less noticeable and will blend into the existing infrastructure rather than standing out as a separate structure. This strategic placement avoids adding a new, tall element to the property and instead utilizes one that already exists.

The Photo Simulations on file with this Minor Use Permit Modification clearly illustrate that the existing facility on the monopole is out of scale and bulk. By attaching the equipment to the water tank, it changes to be in harmony with the scale and bulk of the surrounding area and will therefore be unobtrusive to the surrounding viewshed. As a result, the facility's components will be consistent with the scale of the surrounding environment and will not be readily visible to nearby residents or motorists.

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Coverage:

The project is located on a parcel that is developed with water tanks. The surrounding land uses consist of residential land uses and vacant land and mobile home park. The proposed the project will not contribute existing site coverage, nor will it substantially increase the scale and bulk of the subject property. Considering the size of the subject lot compared with the size and location of the existing structure, and the coverage characteristics of surrounding properties, the telecommunications facility will be consistent in terms of coverage of the surrounding area and will not substantially increase the lot area coverage.

Density:

The proposed changes do not expand the service area or add more equipment than what is needed for the facility to function. Since the project is a modification of an existing facility, the coverage and density of the site itself remain unchanged.

2. The availability of public facilities, services, and utilities

The project is located within the jurisdiction of Lakeside Fire Protection District. The project has been reviewed and found to be FP-2 compliant and the supporting equipment of the facility are located within equipment enclosures. The project would not require water or sewer services. Electrical and telephone services are available on-site. The proposed project involves renewal of a use permit for operation of an existing wireless telecommunication facility with existing access to adequate utilities. All required utilities are therefore available for the project.

3. The harmful effect, if any, upon desirable neighborhood character:

The project is a Minor Use Permit Modification to remove an existing T-Mobile monopole and its associated equipment, and instead mount new antennas onto an existing Helix Water District water tank. This modification has been submitted to bring the existing wireless telecommunication facility into conformance with the County of San Diego Zoning Ordinance, specifically addressing the amortization requirements outlined in Sections 6985 and 6991.

The Photo-simulations on file with the Minor Use Permit Modification clearly illustrate that the existing wireless facility on the monopole is out of scale and bulk. By attaching the equipment to the water tank, the facility is brought into harmony with the scale of the surrounding area. The water tank is a preferred location for wireless facilities because it is already a prominent and necessary part of the landscape. Co-locating the wireless equipment on the tank is an industry best practice that reduces the

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proliferation of new, independent structures. This modification represents a visual improvement because it replaces a more obtrusive monopole with equipment that is better integrated into the site, making it more compatible with the Rural Residential zoning and the surrounding community. No trenching or grading is proposed or required for the project.

Furthermore, the project has been reviewed for noise impacts and determined to be consistent with the County Noise Ordinance, as the current proposal does not introduce any additional noise-generating equipment. As designed, the project would not cause any substantial, demonstrable negative aesthetic effect to views from the surrounding area and roadways. Therefore, the project would not have a harmful effect on the existing neighborhood character.

4. <u>The generation of traffic and the capacity and physical character of surrounding streets:</u>

The traffic generated from the project is not expected to result in an increase of trips and will utilize a private road connecting to I-8 Business for access. Existing space for parking is available on the property. The use associated with this Minor Use Permit Modification is compatible with the existing residential nature of the area because the number of maintenance trips will not substantially alter the expected traffic or physical character of the surrounding streets and will be compatible with adjacent uses. Therefore, the number of maintenance trips will not substantially increase or alter the physical character of I-8 Business or Jackson Hill Dr.

5. <u>The suitability of the site for the type and intensity of use or development, which is proposed:</u>

The applicant proposes a Minor Use Permit Modification T-Mobile monopole and equipment and mount new antennas onto an existing Helix Water District water tank will not result in any alterations to the landform or grading as no additional construction is being proposed at this time. The project, as designed, would be painted to match, would not change the characteristics of the area and is suitable for this site and the type and intensity of uses and development. For reasons stated above, the proposed project would be compatible with adjacent land uses.

6. Any other relevant impact of the proposed use:

None identified.

(b) <u>The impacts, as described in Findings (a) above, and the location of the proposed</u> use will be consistent with the San Diego County General Plan:

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The project is within the Semi-Rural Residential General Plan Land Use Designation, and it is within the Lakeside Community Planning Area. The project complies with the General Plan because civic uses are allowed if they support the local population. In addition, the project is consistent with Goal S-1 (Public Safety) and S-2 (Emergency Response) of the Public Safety Element of the County General Plan, The Project will provide continued coverage throughout the area, which is essential in the event of an emergency. The wireless telecommunication facility will minimize telecommunication interruptions by continuing to provide service and coverage in the area. Furthermore, the project would be consistent with the General Plan Land Use Element Goal 15.1 because the proposed project is compatible with the existing community character, and the project would not result in impacts to the natural environment. The project would be consistent with the General Plan Land Use Element Goal 15.2 because it is designed for colocation. Lastly, the project cannot be seen from any Scenic Highway identified in the County of San Diego General Plan. Pursuant to Section 6987(D) of the Zoning Ordinance, monopoles or other similar structures are not permitted when visible from Scenic Highways identified in the County of San Diego General Plan and the project would result in the facility to be in conformance with the Zoning Ordinance

and General Plan. Therefore, the proposed use and project are consistent with the San Diego County General Plan.

(c) <u>That the requirements of the California Environmental Quality Act have been complied with:</u>

A CEQA exemption 15301 was adopted on October 16, 2025.

WIRELESS TELECOMMUNICATION FINDINGS

The project is in a non-preferred zone but is on a non-preferred location. Pursuant to Section 6986.B of the Wireless Telecommunication Facilities Ordinance, the applicant provided an alternate site analysis and discussed preferred locations in the area and why they were not technologically or logistically feasible to serve the surrounding residents within in this location. The project is removing an exiting monopole and attaching onto a community character of existing water tank.

ORDINANCE COMPLIANCE NOTIFICATIONS: The project is subject to, but not limited to, the following County of San Diego, State of California, and U.S. Federal Government, Ordinances, Permits, and Requirements:

LIGHTING ORDINANCE COMPLIANCE: In order to comply with the County Lighting Ordinance 59.101 et seq. and Zoning Ordinance Sections 6322, 6324, and 6326, the onsite lighting shall comply with the approved plot plan(s), specific permit conditions and approved building plans associated with this permit. All light fixtures shall be designed and adjusted to reflect light downward, away from any road or street, and away from adjoining premises, and shall otherwise conform to the County Lighting Ordinance 59.101 et seq. and Zoning Ordinance Sections 6322, and 6324. The property owner and

permittee shall conform to the approved plot plan(s), specific permit conditions, and approved building plans associated with this permit as they pertain to lighting. No additional lighting is permitted. If the permittee or property owner chooses to change the site design in any away, they must obtain approval from the County for a Minor Deviation or a Modification pursuant to the County of San Diego Zoning Ordinance.

NOISE ORDINANCE COMPLIANCE: In order to comply with the County Noise Ordinance 36.401 et seq. and the Noise Standards pursuant to the General Plan Noise Element (Table N-1 & N-2), the property and all of its uses shall comply with the approved plot plans, specific permit conditions and approved building plans associated with this permit. No noise generating equipment and project related noise sources shall produce noise levels in violation of the County Noise Ordinance. The property owner and permittee shall conform to the approved plot plan(s), specific permit conditions, and approved building plans associated with this permit as they pertain to noise generating devices or activities. If the permittee or property owner chooses to change the site design in any away, they must obtain approval from the County for a Minor Deviation or a Modification pursuant to the County of San Diego Zoning Ordinance.

COMPLIANCE INSPECTION: In order to comply with Zoning Ordinance Section 7362.e the County shall inspect the Use Permit property for compliance with the terms of this Use Permit. The County Permit Compliance Officer will perform a site inspection and review the on-going conditions associated with this permit. The inspection shall be scheduled no later than the six months subsequent to establishing the intended use of the permit. If the County determines the applicant is not complying with the Minor Use Permit terms and conditions the applicant shall allow the County to conduct follow up inspections more frequently than once every twelve months until the County determines the applicant is in compliance. The Property Owner/Permittee shall allow the County to inspect the property for which the Minor Use Permit has been granted, at least once every twelve months, to determine if the Property Owner/Permittee is complying with all terms and conditions of the Use Permit. This requirement shall apply during the term of this permit.

STORMWATER ORDINANCE COMPLIANCE: In order to Comply with all applicable stormwater regulations the activities proposed under this application are subject to enforcement under permits from the <u>San Diego Regional Water Quality Control Board (RWQCB)</u> and the County of San Diego Watershed Protection, Stormwater Management, and Discharge Control <u>Ordinance No. 10410</u> and all other applicable ordinances and standards for the life of this permit. The project site shall be in compliance with all applicable stormwater regulations referenced above and all other applicable ordinances and standards. This includes compliance with the approved Stormwater Management Plan, all requirements for Low Impact Development (LID), Hydromodification, materials and wastes control, erosion control, and sediment control on the project site. Projects that involve areas 1 acre or greater require that during construction the property owner keeps the Storm Water Pollution Prevention Plan (SWPPP) onsite and update it as needed. The property owner and permittee shall comply with the requirements of the stormwater regulations referenced above.

LOW IMPACT DEVELOPMENT NOTICE: The San Diego Regional Water Quality Control Board (SDRWQCB) issued a new Municipal Stormwater Permit under the National Pollutant Discharge Elimination System (NPDES). The requirements of the Municipal Permit were implemented beginning in May 2013. *Project design shall be in compliance with the new Municipal Permit regulations*. The Low Impact Development (LID) Best Management Practices (BMP) Requirements of the Municipal Permit can be found at the following link:

http://www.sandiegocounty.gov/content/dam/sdc/dpw/WATERSHED_PROTECTION_PROGRAM/susmppdf/lid_handbook_2014sm.pdf

The County has provided a LID Handbook as a source for LID information and is to be utilized by County staff and outside consultants for implementing LID in our region. See link below. http://www.sdcounty.ca.gov/dplu/docs/LID-Handbook.pdf

STORMWATER COMPLIANCE NOTICE: Updated studies, including Hydro-modification Management Plans for Priority Development Projects, will be required prior to approval of grading and improvement plans for construction pursuant to County of San Diego Watershed Protection, Stormwater Management and Discharge Control Ordinance No. 10410 (N.S.), dated February 26, 2016 and BMP Design Manual. These requirements are subject to the MS4 Permit issued by the Regional Water Quality Control Board, Order No. R9-2013-0001 and any subsequent order Additional studies and other action may be needed to comply with future MS4 Permits.

GRADING PERMIT REQUIRED: A grading permit is required prior to commencement of grading when quantities of excavation or fill results in the movement of material exceeding 200 cubic yards or eight feet (8') in vertical height of cut/fill, pursuant to Section 87.201 of Grading Ordinance.

CONSTRUCTION PERMIT REQUIRED: A Construction Permit and/or Encroachment Permit are required for any and all work within the County road right-of-way. Contact PDS Construction/Road right-of-way Permits Services Section, (858) 694-3275, to coordinate County requirements. In addition, before trimming, removing or planting trees or shrubs in the County Road right-of-way, the applicant must first obtain a permit to remove plant or trim shrubs or trees from the Permit Services Section.

ENCROACHMENT PERMIT REQUIRED: An Encroachment Permit is required for any and all proposed/existing facilities within the County right-of-way. At the time of construction of future road improvements, the proposed facilities shall be relocated at no cost to the County, to the satisfaction of the Director of Public Works.

EXCAVATION PERMIT REQUIRED: An excavation permit is required for undergrounding and/or relocation of utilities within the County right-of-way.

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TRANSPORTATION IMPACT FEE: The project is subject to County of San Diego Transportation Impact Fee (TIF) pursuant to <u>County TIF Ordinance number 77.201 – 77.223</u>. The Transportation Impact Fee (TIF) shall be paid. The fee is required for the entire project, or it can be paid at building permit issuance for each phase of the project. The fee is calculated pursuant to the ordinance at the time of building permit issuance. The applicant shall pay the TIF at the [*PDS*, *LD Counter*] and provide a copy of the receipt to the [*PDS*, *BD*] at time of permit issuance.

EXPLANATION OF COUNTY DEPARTMENT AND DIVISION ACRONYMS					
Planning & Development Services (PDS)					
Project Planning Division	PPD	Land Development Project Review Teams	LDR		
Permit Compliance Coordinator	PCC	Project Manager	РМ		
Building Plan Process Review	BPPR	Plan Checker	PC		
Building Division	BD	Map Checker	MC		
Building Inspector	ding Inspector BI Landscape Architect		LA		
Zoning Counter	ZO				
Department of Public Works (DPW)					
Private Development Construction Inspection	PDCI	Environmental Services Unit Division	ESU		
Department of Environmental Health and Quality (DEHQ)					
Land and Water Quality Division	ter Quality Division LWQ Local Enforcement Agency		LEA		
Vector Control	ctor Control VCT Hazmat Division		HMD		
Department of Parks and Recreation (DPR)					
Trails Coordinator	oordinator TC Group Program Manager		GPM		
Parks Planner	PP				
Department of General Service (DGS)					
Real Property Division	RP				

APPEAL PROCEDURE: Within ten calendar days after the date of this Decision of the Planning Commission, the decision may be appealed to the Board of Supervisors in accordance with <u>Section 7366 of the County Zoning Ordinance</u>. An appeal shall be filed

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with the Director of Planning & Development Services or by mail with the Secretary of the Planning Commission within TEN CALENDAR DAYS of the date of this notice AND MUST BE ACCOMPANIED BY THE DEPOSIT OR FEE AS PRESCRIBED IN THE DEPARTMENT'S FEE SCHEDULE, PDS FORM #369, pursuant to Section 362 of the San Diego County Administrative Code. If the tenth day falls on a weekend or County holiday, an appeal will be accepted until 4:00 p.m. on the following day the County is open for business. Filing of an appeal will stay the decision of the Director until a hearing on your application is held and action is taken by the Planning Commission. Furthermore, the 90-day period in which the applicant may file a protest of the fees, dedications or exactions begins on the date of approval of this Decision.

COUNTY OF SAN DIEGO VINCE NICOLETTI, DIRECTOR

BY:

Ashley Smith, Chief Project Planning Division Planning & Development Services

email cc:

Dag Bunnemeyer, Group Program Manager, PDS Andrew Holtz, Project Planner, Land Use/Environmental Planner, PDS Smartlink Group, Project Contact

Attachment C Environmental Findings

NOTICE OF EXEMPTION

TO:

Recorder/County Clerk

San Diego, CA 92101

1600 Pacific Highway, M.S. A33

FROM: County of San Diego Planning & Development Services, M.S. O650 Attn: Project Planning Division Section Secretary FILING OF NOTICE OF EXEMPTION IN COMPLIANCE WITH PUBLIC RESOURCES CODE SECTION SUBJECT: 21108 OR 21152 Project Name: PDS2022-ZAP-96-035W2 - Helix Water Wireless 13002 I-8 Buisness, Lakeside, unincorporated San Diego County (APN: 400-060-03-00) **Project Location: Project Applicant:** T-Mobile: 630-220-8156 (Vincent Voss, Smartlink Group – project contact) 6788 Clear Sky Ter, San Diego CA 92120 Project Description: The project involves the renewal of an existing wireless telecommunication facility, by removing the current T-Mobile monopole and its associated equipment and mounting the new equipment onto the existing Helix Water District water tank. Agency Approving Project: County of San Diego County Contact Person: Andrew Holtz Telephone: 619-458-2038 Date Form Completed: October 16, 2025 This is to advise that the County of San Diego Planning & Development Services has approved the above described project on October 16, 2025 and found the project to be exempt from the CEQA under the following criteria: Exempt status and applicable section of the CEQA ("C") and/or State CEQA Guidelines ("G"): (check only one) ☐ Declared Emergency [C 21080(b)(3); G 15269(a)] Emergency Project [C 21080(b)(4); G 15269(b)(c)]

Statutory Exemption. C Section: ☐ Categorical Exemption. G Section: 15301 G 15061(b)(3) - It can be seen with certainty that there is no possibility that the activity in question may have a significant effect on the environment and the activity is not subject to the CEQA. ☐ G 15182 – Residential Projects Pursuant to a Specific Plan G 15183 – Projects Consistent with a Community Plan, General Plan, or Zoning ☐ Activity is exempt from the CEQA because it is not a project as defined in Section 15378. 2. Mitigation measures \(\preceq \) were \(\preceq \) were not made a condition of the approval of the project. 3. A Mitigation reporting or monitoring plan ☐ was ☒ was not adopted for this project. Statement of reasons why project is exempt: Pursuant to Section 15301 of the State of California Environmental Quality Act Guidelines, the project is exempt from CEQA because it involves negligible expansions by removing an existing wireless facility and building onto an existing water tank. It has been determined that the project is not in an environmentally sensitive location; will not have a cumulative effect on the environment; is not on a hazardous waste site; will not cause a substantial change in the significance of a historical resource; and will not result in damage to a scenic highway. The following is to be filled in only upon formal project approval by the appropriate County of San Diego decision-making body. Signature: Telephone: (619) 458-2038 Name (Print): Andrew Holtz Title: Land Use/Environmental Planner This Notice of Exemption has been signed and filed by the County of San Diego.

This notice must be filed with the Recorder/County Clerk as soon as possible <u>after</u> project approval by the decision-making body. The Recorder/County Clerk must post this notice within 24 hours of receipt and for a period of not less than 30 days. At the termination of the posting period, the Recorder/County Clerk must return this notice to the Department address listed above along with evidence of the posting period. The originating Department must then retain the returned notice for a period of not less than twelve months. Reference: CEQA Guidelines Section 15062.

Attachment D Public Documentation



County of San Diego, Planning & Development Services

COMMUNITY PLANNING OR SPONSOR GROUP PROJECT REVIEW

ZONING DIVISION

Record ID(s):		 	 	
Project Name: _			 	
Project Manager	:		 	
Project Manager	's Phone:			

Scope of Review:

Board Policy I-1 states; "groups may advise the appropriate boards and commissions on discretionary projects as well as on planning and land use matters important to the community." Planning & Development Services (PDS) has received an application for the project referenced above. PDS requests that your Group evaluate and provide comment on the project in the following areas:

- The completeness and adequacy of the Project Description
- Compatibility of the project design with the character of the local community
- Consistency of the proposal with the Community Plan and applicable zoning regulations
- Specific concerns regarding the environmental effects of the project (e.g., traffic congestion, loss of biological resources, noise, water quality, depletion of groundwater resources)

Initial Review and Comment:

Shortly after an application submittal, a copy of the application materials will be forwarded to the Chair of the applicable Planning or Sponsor Group. The project should be scheduled for initial review and comment at the next Group meeting. The Group should provide comments on planning issues or informational needs to the PDS Project Manager at your earliest convenience.

Planning Group review and advisory vote:

- A. **Projects that do not require public review of a CEQA document:** The Group will be notified of the proposed hearing date by the PDS Project Manager. The project should be scheduled for review and advisory vote at the *next Group meeting*.
- B. **Projects that require public review of a CEQA document:** The Chair of the Planning Group will be noticed when an environmental document has been released for public review. The final review of the project by the Group, and any advisory vote taken, should occur *during the public review period*.

As part of its advisory role, the Group should provide comments on both the adequacy of any environmental document that is circulated and the planning issues associated with the proposed project. The comments provided by the Group will be forwarded to the decision-making body and considered by PDS in formulating its recommendation.

Notification of scheduled hearings:

In addition to the public notice and agenda requirements of the Brown Act, the Group Chair should notify the project applicant's point of contact and the PDS Project Manager at least two weeks in advance of the date and time of the scheduled meeting.

County of San Diego, Planning & Development Services

COMMUNITY PLANNING OR SPONSOR GROUP PROJECT RECOMMENDATION

ZONING DIVISION

Rec	ord ID(s):				
Proj	ect Name:		· · · · · · · · · · · · · · · · · · ·		
		roup:			
Resu	ults of Planning/S	ponsor Group Review			
Mee	ting Date:				
A.		ade by the group on the			
-					
B.	Advisory Vote: The Group				
	approval or denial on the project at this time. If a formal recommendation was made, please check the appropriate box below:				
		_		oriate box below:	
	MOTION:	Approve without			
		_ ··	ommended conditions		
		☐ Deny			
		Continue			
	VOTE:	Yes No	Abstain	Vacant / Absent	
C.	Recommende	ed conditions of approva	l:		
-					
-					
Rep	orted by:		Position:	Date:	

Please email recommendations to BOTH EMAILS;

Project Manager listed in email (in this format): Firstname.Lastname@sdcounty.ca.gov **and to** CommunityGroups.LUEG@sdcounty.ca.gov

5510 OVERLAND AVE, SUITE 110, SAN DIEGO, CA 92123 • (858) 694-8985 • (888) 267-8770 http://www.sdcounty.ca.gov/pds



County of San Diego, Planning & Development Services

DISCRETIONARY PERMIT APPLICATION ZONING DIVISION PDS 2022-FR-96-14-027 B

RECORDID(S): PDS 2022-ZAP	1-22-010			
Planning LD Review Teams	DEH Trails Review Other			
DEPOSITS 6864 + T	+ + +			
TOTAL FEES AND INITIAL DEPOSIT: \$ The submitted Initial Deposit is estimated to cover only the initial project review (Scoping). Additional monies will be required. A project-specific cost estimate will be provided at the conclusion of Scoping, along with a letter detailing any project issues, revisions, and studies as deemed necessary for compliance with State and County codes and ordinances.				
Have you had a pre-application conference? YES ☐ NO 🗹 If yes, Plan	ner's Name			
Is this project the subject of a code violation? YES ☐ NO 🗹 If yes, provi	de a copy of the Warning/Citation/Violation Notice.			
Are there any related, open applications such as DEH permits, Grading per	rmits, etc? YES □ NO 🗹			
If yes, list permits:				
Is there an existing Trust Account on any of the open records related to this Are there any prior related cases such as a specific plan? If yes, list Case				
The Financially Responsible Party is responsible for all costs related				
	ans approalish (see Ishii 1 25-125).			
	Owner's Phone 619-667-6268			
Owner's Address 7811 University Ave, La Mesa, CA 91942				
Number Street City State Owner's email Debbie.Lundy@helixwater.org				
Applicant's Name T-Mobile (If different from owner)	Applicant's			
Applicant's Address 10509 Vista Sorrento Pkwy #206, San Diego, CA	A 92008			
Applicant's email vincent.voss@smartlinkgroup.com	Applicant's Fax			
	Engineer's Phone (949) 391-6824			
Engineer's Address 1387 Calle Avanzado, San Clemente, CA 92673				
Number Street City State Engineer's email Yuliya@msquaredwireless.com	Zip			
Project Contact Person Vincent Voss, Smarlink Group obo T-	Mobile Phone (630) 220-8156			
Address 6788 Clear Sky Ter, San Diego, CA 92120				
Number Street City State Zip Project Contact's email				
Project Name T-Mobile SD06045A Anchor/L600				
Project Address & Nearest Cross Street Highway 8 Business and Aurora Dr.				
I declare under penalty of perjury under the laws of the State of California that correct. I hereby agree to provide the indemnification as required by Chapter 2	the statements made as part of this application are true and			
*REQUIRED: an Authorized Agent signing below must attach a signed Letter of Authorization.	OFFICIAL USE ONLY			
Vincant Voss	SDC PDS RCVD 08-30-22			
Signature of Owner or *Authorized Agent ZAP22-010				
Vincent Voss 5/25/2022				

PDS-346 (5/21/2018)

FOR DEPARTMENT USE ONLY

		Existing	Proposed	For Administrative Permits and Use Permits
General Plan	Designation	5'R4		Describe use:
Regional Cate	Regional Category			New
. rogional oato	9-17	D	1	700
		KUYO	il	
	ZONE	100	,	12 52 6
USE REGULA		KK	-	Thomas Guide (Page/Grid)
ANIMAL REG		7		Tax Rate Area 59086
	Density	1100	-	1 7 1
I S S	Lot Size Building Type	IAC	-	Total Acres No. of lots
M O	Maximum Floor Area		1	Planning Group Lake Side
ATA	Floor Area Ratio		1	Community Plan Lake 51 de
띘릭	Height	C	1	Continuity Plan Care 51 (12)
DEVELOPIMENT REGULATIONS	Lot Coverage			Supervisor District
25	Setback	13		
	Open Space	1		
SPECIAL ARE	A REGULATIONS	-		
Project is with Project is with Project is prop Project is prop Project is a Vie Military Notice Project is with	is required? in 150' of the Internation	al Park? ? onal Border	rdinance? YES NO O O O	YES NO YES NO FP-2 FP-2 If yes, name of City S rd of Supervisor's Policy I-111.
If the subject r	parcel was created thro	nugh a PM	or B/C, have	e you verified that all Covenants of Improvement
have been sat	isfied? YES 🖊 NO 🗌	IF NO, D	O NOT ACC	CEPT THE APPLICATION.
	rent owner of mineral name and address:			f real property? YES NO 🖊
Technician Ini		R ASSIGN		thnician's comments:

Attachment E
Photo Simulations,
Geographical Service
Area, and Alternative
Site Analysis



1-66 SD06045A

SD045 HELIX WATER DISTRICT

engineering
AEsims.com
877.9AE.sims

13002 Highway 8 Business EL Cajon CA 92021

VIEW 1







1-67 SD06045A

SD045 HELIX WATER DISTRICT

ARTISTIC engineering
AEsims.com
877.9AE.sims

13002 Highway 8 Business EL Cajon CA 92021

VIEW 2







1-68 SD06045A

SD045 HELIX WATER DISTRICT

ARIISTIC engineering
AEsims.com
877.9AE.sims

13002 Highway 8 Business EL Cajon CA 92021

VIEW 3









SD06045A Coverage Maps

RF Team - San Diego Market


T-Mobile Area with SD06045A

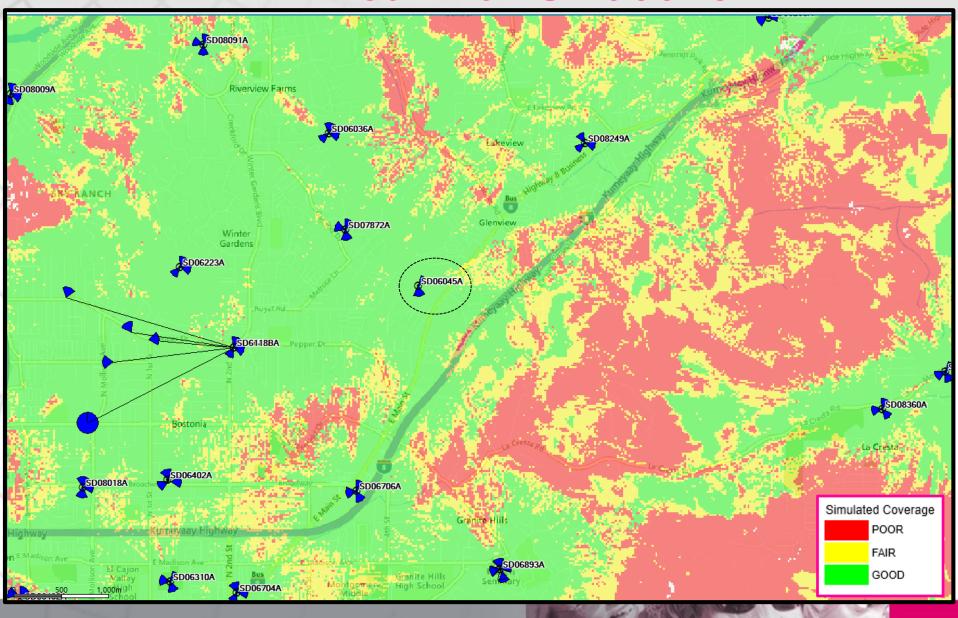

T-Mobile Area without SD06045A

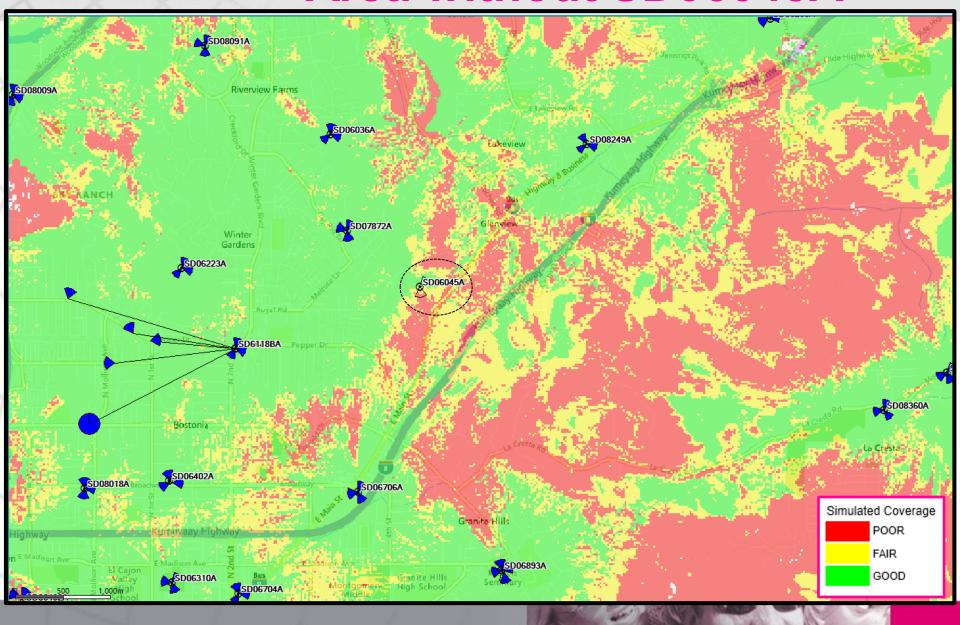

·· T·· Mobile SD06045A Only

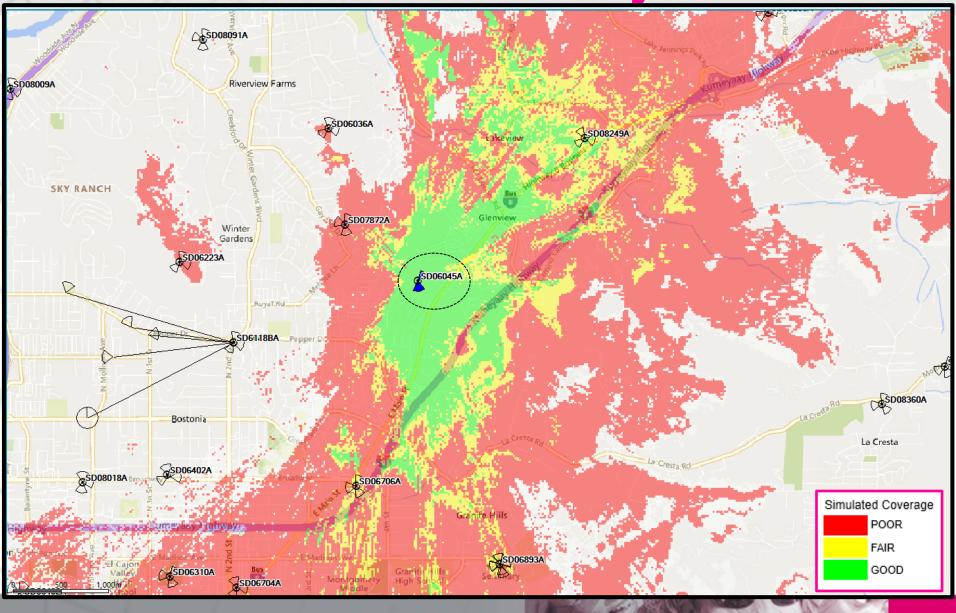



January 19, 2023

To: County of San Diego

Planning & Development Services

5510 Overland Ave, San Diego, CA 92123

From: Vince Voss

Smartlink Group

Real Estate Project Manager

RE: Minor Use Permit Modification (PDS2022-ZAP-96-035W2 - Alternative Site Analysis Letter)

T-Mobile Site SD06045A – SD045 Helix Water District

Site Selection: The subject site was selected and deemed the best option because it is already an existing Wireless Communication facility. The original WCF facility (water tank) was carefully chosen because the site is an existing structure that also allows for other carrier collocation. The site is also in a desirable location with respect to its proximity to the neighboring community. Additionally, the water tank sits on top of a hilltop which provides a necessary RAD center (height) for maximum and optimal coverage.

As background history, affixing the antennas to the water tank was no longer available when the property owner requested T-Mobile remove their equipment off the water tank and onto temporary facilities while the water tank was renovated. T-Mobile complied with that request and their existing equipment is currently installed on two temporary monopoles. The water tank renovation project is nearly complete and as a result, T-Mobile is ready to move their antenna equipment back onto the permanent water tank facility. The proposed project complies with the amortization ordinance and Land Use Element LU-15.

Compliance with Land Use Element LU-15: As described under the previous section, "Site Selection", the Wireless Communication facility has been designed utilizing state-of-the-art techniques to minimize impacts to the community (including visual) and the environment. The proposed Wireless Communication facility will not have adverse impacts to the natural environment and is compatible with existing development and community character.

Alternative Site Analysis per Wireless Ordinance 6986.B. A site justification map has been attached to this letter and included as part of the application package. The map illustrates that the subject site is located in a concentrated area that is primarily surrounded by residential zones with very limited commercial or industrial zone areas. The elevation of the existing site location is superior to the surrounding zone areas, helping with achieving the necessary height for obtaining optimal coverage. The subject site utilizes a "preferred" site as per Wireless Ordinance 6986 A.2.(a.) (1), a water tank. As described earlier in this letter under the "Site Selection" section, the property owner required T-Mobile remove their equipment off the water tank and onto temporary monopoles. T-Mobile is now proposing



the equipment be removed from the temporary monopoles and relocated to back onto the water tank in accordance with the County of San Diego's amortization ordinance. In summary, the subject site is still located on a "preferred" site location in compliance with Wireless Ordinance 6986.

With respect to other facilities or candidates that were considered, there were none. Because the location is a highly residential zone, there are virtually no feasible commercial or industrial options. This is a concentrated ring, and T-Mobile has built out a network in the surrounding areas, so the search ring is specific to this concentrated area (see coverage map attached to this Alternative Site Analysis). As a result, there are very limited to no options for WCF consideration. Additionally, because this is an existing wireless communication facility, this is a site that has been reviewed and approved previously by the County and surrounding community alike.

Conclusion: After careful consideration of the beforementioned factors, the determination was made that the existing location is the best option for a Wireless Communication Facility. The site provides a much-needed service to the community while minimizing the overall visual impact on the subject area. Visual impact has been minimized by adhering to the County of San Diego's amortization ordinance (water tank, a preferred location) and other pertinent codes and ordinances (namely Land Use Element LU-15 and Wireless Ordinances 6986 and 6987). Furthermore, and as stated previously, the site has been designed and engineered to allow for future collocation. A collocatable facility decreases the number of facilities on site, minimizing visual impact even further, while also avoiding the need to install new WCF facilities in the surrounding area. Lastly, the proposed Wireless Communication Facility will provide an overall and long-lasting benefit to the community.

Sincerely,

Vince Voss Smartlink Group (630) 220-8156 Vincent.voss@smartlinkgroup.com

Attachment F Ownership Disclosure Form

Property Owner Letter of Authorization

County of San Diego Planning Dept. 5510 Overland Ave, Suite 110 San Diego, CA 92123

Re: Zoning/Building Permit Authorization- T-Mobile @ Tunnel Hill

I hereby represent that I am the authorized representative of Helix Water District (legal owner), of the property referenced below, and I hereby give my authorization to Smartlink, and/or its Agents, to submit an application for approval for Building and/or Zoning permits for the purpose of construction of certain improvements to relocate an existing communication facility from a temporary site to a tank-mounted facility. Actual construction of any such improvements which receive entitlements shall be at the sole discretion of Helix Water District, as Owner and Lessor, and Helix Water DISTRICT SHALL BE A SIGNOR ON ANY/ALL IMPROVEMENT PLANS.

Owner hereby authorizes the employees of the County of San Diego to enter upon the subject property by appointment, at least 24 hours in advance, between the hours of 7:30 a.m. and 3:30 p.m. Monday-Friday for the purpose of processing said application.

This authorization is for improvements to be constructed in connection with the relocation of an existing wireless communications site described as:

Site Name:

SD045 Helix Water District

Site Number:

SDO6045A

Site Address:

13002 Highway 8 Business

El Cajon, CA 92021

Legal Description:

400-060-03

and is EFFECTIVE FOR UP TO ONE YEAR following the below signature date.

HELIX WATER DISTRICT (Owner)

By:

Debbie Lundy, Senior Right of Way Agent

Data: