BMP LEGEND SHEET INDEX By using these standard plans, the user agrees to release the County of San Diego from any and all BROW DITCH \Longrightarrow SHEET NAME claims, liabilities, suits, and demands on account of any injury, damage, or loss to persons or property, BERM \rightarrow B \rightarrow SITE PLAN including injury or death, or economic losses, arising RECTION OF LOT DRAINAGE -> A1 FLOOR PLAN out of the use of these construction documents. The ELECTRICAL PLAN MATERIALS & WASTE MANAGEMENT BMPs: use of these plans does not eliminate or reduce the A3 ELEVATIONS - FRONT & BACK user's responsibility to verify any and all information. WM-1 MATERIAL DELIVERY & STORAGE A4 ELEVATIONS - RIGHT & LEFT WM-4 SPILL PREVENTION AND CONTROL A5 ROOF PLAN / TRUSS LAYOUT WM-8 CONCRETE WASTE MANAGEMENT A6 SECTIONS WM-5 SOLID WASTE MANAGEMENT S1 FOUNDATION PLAN S2 ROOF FRAMING WM-9 SANITARY WASTE MANAGEMENT CS-1 MIN. CONSTRUCTION SPECIFICATIONS WM-6 HAZARDOUS WASTE MANAGEMENT TEMPORARY RUNOFF CONTROL BMPs: SS-2 PRESERVATION OF EXISTING VEGETATION \$\simp\text{PEV} \simp\text{PEV}\$ THIS PROJECT SHALL COMPLY WITH THE FOLLOWING BUILDING SS-3 BONDED OR STABILIZED FIBER MATRIX (WINTER) ~M~M~ SS-4 HYDROSEEDING (SUMMER) ~TSP~TSP~ SS-6 / SS-8 STRAW OR WOOD MULCH ~ S/W~ S/W~ 2022 CALIFORNIA BUILDING CODE 2022 CALIFORNIA GREEN BUILDING STANDARDS CODE SS-7 PHYSICAL STABILIZATION (WINTER) ~ EBM ~ EBM ~ 2022 CALIFORNIA ELECTRICAL CODE 2022 CALIFORNIA MECHANICAL CODE SS-10 ENERGY DISSIPATOR 2022 CALIFORNIA PLUMBING CODE 2022 CALIFORNIA FIRE CODE 2022 CALIFORNIA BUILDING ENERGY EFFICIENCY STANDARDS SC-1 SILT FENCE — SC-2 / PDS 659 SEDIMENT / DESILTING BASIN DESIGN BASIS SC-5 FIBER ROLLS —FR—FR— SC-6 / SC-8 GRAVEL OR SAND BAGS COCO CONVENTIONAL LIGHT FRAME CONSTRUCTION ROOF LIVE LOAD: 20 PSF ULTIMATE WIND SPEED: 110 MPH SC-7 STREET SWEEPING AND VACUUMING SC-10 STORM DRAIN INLET PROTECTION EXPOSURE CATEGORY: C SITE CLASS: D RISK CATEGORY: II NS-2 DEWATERING FILTRATION — (DW)—(DW)— Sne: 1.25 TC-1 STABILIZED CONSTRUCTION ENTRANCE SEISMIC DESIGN CATEGORY: D. ALLOW SOIL VERTICAL BEARING PRESSURE: 1500 PSF ALLOW SOIL LATERAL BEARING PRESSURE: 100 PSF/FT TC-2 CONSTRUCTION ROAD STABILIZATION TC-3 ENTRANCE / EXIT TIRE WASH **ENERGY EFFICIENCY SPECIAL FEATURES** BASELINE BMPs FOR EXISTING AND PROPOSED SITE FEATURES SPECIFY AS INDICATED IN CF1R FORM (TITLE 24): SD-B DIRECT RUNOFF TO PERVIOUS AREAS SD-C INSTALL GREEN ROOF SD-E INSTALL RAIN BARRELS SD-G CONSERVE NATURAL FEATURES SD-H PROVIDE BUFFERS AROUND WATER BODIES ENERGY EFFICIENCY HERS VERIFICATION SD-I CONSTRUCT SURFACES FROM PERMEABLE MATERIALS SD-K SUSTAINABLE LANDSCAPING SPECIFY AS INDICATED IN CF1R FORM (TITLE 24): BASELINE BMPs FOR POLLUTANT-GENERATING SOURCES SC-A OVERHEAD COVERING SC-B SEPARATION OF FLOWS FROM ADJACENT AREAS SC-C WIND PROTECTION SC-D SANITARY SEWER SC-E CONTAINMENT SYSTEM POTENTIAL RUNOFF POLLUTANTS: PROPERLY COMPLETED AND SIGNED CERTIFICATES OF INSTALLATION (CF2R FORMS) SHALL BE PROVIDED TO THE INSPECTOR IN THE FIELD. FOR PROJECTS REQUIRING HERS VERIFICATION, THE CF2R FORMS SHALL BE REGISTERED WITH A TRASH & REFUSE STORAGE B MATERIALS & EQUIPMENT STORAGE A CALIFORNIA-APPROVED HERS PROVIDER DATA REGISTRY C LOADING & UNLOADING CF2R FORMS ARE AVAILABLE AT TTP://WWW.SDCOUNTY.CA.GOV/PDS/BLDG/ENERGY-STDS.HTML D FUELING E MAINTENANCE & REPAIR PROPERLY COMPLETED CERTIFICATES OF VERIFICATION (CF3R FORMS) SHALL BE PROVIDED TO THE INSPECTOR IN THE FIELD FOR ITEMS REQUIRING HERS VERIFICATION. CF3R FORMS F VEHICLE & EQUIPMENT CLEANING SHALL BE REGISTERED WITH A CALIFORNIA-APPROVED HERS PROVIDER DATA REGISTRY." CF3R FORMS ARE AVAILABLE AT G OTHER HTTP://WWW.SDCOUNTY.CA.GOV/PDS/BLDG/ENERGY-STDS.HTMI (CBEES 10-103) PROVIDE SOLAR PV SYSTEM UNDER SEPARATE PERMIT.
SYSTEM SIZE TO COMPLY WITH ENERGY COMPLIANCE VICINITY MAP CONTACT INFORMATION IMPERVIOUS AREA INFORMATION OWNER INFORMATION PROJECT INFORMATION PERVIOUS AREA INFORMATION SHEET TITLE ADU □ SFD □ JAME: NAME: PROJECT SCOPE: PROPOSED 600 SF DETACHED DWELLING UNIT PLOT PLAN AREA (SF) PERVIOUS ITEM DIMENSIONS NOTES IMPERVIOUS ITEM ADDRESS: ADDRESS: ROPOSED ELLING UNIT ADU
SFD 32'-7" x 24'-0" 782 SHEET NUMBER HONE: HONE: All proposed buildings, structures, additions, modifications ROPERTY CONNECTED TO THE ELECTRICAL GRID (Y or N) uildings/structures must comply with the approved location, a hown on the County approved Plot Plan. At the discretion of th PERVIOUS ELEMENT SLOPE AND DIRECTION OF SLOPE: PROPERTY SERVICED BY PROPANE (Y or N) IF YES, SHOW TANK ON PLOT PLAN SP-1 County, the property owner may be required to provide proof o current placement of each on the parcel. This may include a EMAIL: EMAIL: MAINTENANCE PROGRAM TOTAL (SF) PERVIOUS ELEMENT CROSS SECTION LOCATED ON SHEET: PROPERTY SERVICED BY NATURAL GAS (Y or N) stamped and signed setback certificate prepared by a Californi censed surveyor or civil engineer. (County Building Cod (1.1.107.2) ENTIRE LOT IS FUEL MODIFIED (Y or N) IF NO, DIMENSION 100' FUEL MODIFICATION CONSTRUCTED PERVIOUS SURFACES SHALL NOT BE SEALED



- 1-HOUR FIRE RATING ON THE UNDERSIDE WITHIN 3FT OF PROPERTY LINE (WITH SPRINKLERS)
- 1-HOUR FIRE RATING ON THE UNDERSIDE WITHIN 5FT OF

EXTERIOR WALLS WITHIN 3 FEET OF PROPERTY LINE (WITH SPRINKLERS) OR 5 FEET OF PROPERTY LINE (WITHOUT SPRINKLERS) REQUIRE 1-HOUR FIRE RATING FOR EXPOSURE TO BOTH SIDES.

FLOOR PLAN NOTES

4. PENETRATIONS:

SHOWER COMPARTMENT SEAT

SHOWER GRAB BARS

BLOCKING)

- SINGLE-LEVER DESIGN

- MINIMUM 59 INCH LONG HOSE

THE FOLLOWING:

- NOT EXTENDING OVER SHOWER SEAT

2. PROJECTIONS:

— PROHIBITED WITHIN 2 FEET OF PROPERTY LINE

PROPERTY LINE (WITHOUT SPRINKLERS)

PROPERTY LINE (WITHOUT SPRINKLERS)

- LOCATED WITHIN 27 INCHES OF SHOWER CONTROLS

OPENINGS:

- PROHIBITED WITHIN 3FT OF PROPERTY LINE

- MAXIMUM 25% OF WALL AREA WITHIN 5 FEET OF PROPERTY LINE
(WITHOUT SPRINKLERS)

- 1-HOUR FIRE-RATED PENETRATIONS OF WALLS WITHIN 3FT OF PROPERTY LINE (WITH SPRINKLERS)

- 1—HOUR FIRE—RATED PENETRATIONS OF WALLS WITHIN 5FT OF

5. CONCRETE LANDING WITH MIN 36" DEPTH AND A MAXIMUM OF 1-1/2" LOWER THAN TOP OF DOOR THRESHOLD

MUST BE FOLDING TYPE, NOT TO EXCEED MORE THAN 6 INCHES FROM MOUNTING WALL WHEN FOLDED

- LOCALED MINIMIN 27 INCHES OF SHOWER CONINCLS

MOUNTED MINIMUM 17 INCHES AND MAXIMUM 19 INCHES ABOVE
BATHROOM RINSHED FLOOR.

SEAT INSTALLED ON SIDE WALL ADJACENT TO CONTROLS AND EXTENDING
FROM BACK WALL TO POINT WITHIN 3 INCHES OF SHOWER COMPARTMENT

- STRUCTURAL ADEQUACY OF MOUNTING HARDWARE AND FASTENERS TO ACCOMMODATE 250 POUND POINT LOAD APPLIED AT ANY POINT ON THE GRAB BAR, FASTENER, MOUNTING DEVICE, OR SUPPORTING STRUCTURE

- MOUNTED MINIMUM 33 INCHES AND MAXIMUM 36 INCHES ABOVE SHOWER

- IF CROSS SECTION IS CIRCULAR, MINIMUM $1-\frac{1}{4}$ " AND MAXIMUM 2" - IF CROSS SECTION IS NON-CIRCULAR, MINIMUM 4" AND MAXIMUM 4.8" PERIMETER AND MAXIMUM $2-\frac{1}{4}$ " CROSS SECTION DIMENSION

- Grab bars mounted adjacent to a wall, 1-1/2" absolute space between wall and grab bar

- MINIMUM 1-1/2 SPACE BETWEEN GRAB BAR AND PROJECTING OBJECTS BELOW AND AT ENDS

MINIMUM 12 INCH SPACE BETWEEN GRAB BAR AND PROJECTING OBJECTS ABOVE

- SURFACE MATERIAL OF ANY WALLS OR OBJECTS ADJACENT TO GRAB BARS
MUST BE FREE OF SHARP OR ABRASIVE ELEMENTS AND HAVE ROUNDED

BOES.

STRUCTURAL ADEQUACY OF MOUNTING HARDWARE AND FASTENERS TO ACCOMMODATE 250 POUND POINT LOAD APPLIED AT ANY POINT ON THE GRAB BAR, FASTENER, MOUNTING DEVICE, OR SUPPORTING STRUCTURE

WALL REINFORCEMENT TO BE PROVIDED AT LOCATION OF GRAB BARS (E.G.

- INSTALLED ON BACK WALL OF SHOWER COMPARTMENT ADJACENT TO SEAT

- CENTERLINE AT MINIMUM 39 INCHES AND MAXIMUM 41 INCHES ABOVE

- OPERABLE WITH ONE HAND AND WITHOUT TIGHT GRASPING, PINCHING, OR TWISTING OF WRIST

SPRAYER UNIT AND ASSOCIATED OPERABLE PARTS SHALL BE PROVIDED PER

OPERABLE PARTS, INCLUDING HANDLE, TO BE INSTALLED ON BACK WALL OF SHOWER COMPARTMENT MINIMUM 19 INCHES AND MAXIMUM 27 INCHES FROM SEAT WALL

- OPERABLE PARTS LOCATED ABOVE GRAB BAR BUT NO HIGHER THAN 48 INCHES ABOVE SHOWER FLOOR, MEASURED TO TOP OF MOUNTING BRACKET

ADJUSTABLE -HEIGHT SHOWER HEADS ON VERTICAL BAR SHALL NOT OBSTRUCT USE OF BATHTUB GRAB BARS

WHERE SOAP DISHES ARE PROVIDED, MAXIMUM 40 INCHES ABOVE SHOWER FLOOR AND WITHIN REACH LIMITS FROM THE SHOWER SEAT MAXIMUM 2.1% SLOPE IN ALL DIRECTIONS OF ROLL-IN SHOWER FLOORS

maximum $\frac{1}{2}$ " high thresholds with maximum 50% beveled slope at roll—in showers WHERE DRAINS ARE PROVIDED AT ROLL—IN SHOWERS, MAXIMUM $\chi_4^{\prime\prime}$ GRATE OPENINGS FLUSH WITH SHOWER FLOOR SURFACE AGING-IN-PLACE AND FALL PREVENTION DESIGN

REINFORCEMENT FOR GRAB BARS: AT LEAST ONE BATHROOM ON THE ENTRY LEVEL SHALL BE PROVIDED WITH REINFORCEMENT INSTALLED IN ACCORDANCE WITH SECTION R327.1.1. REINFORCEMENT SHALL BE MINIMUM 2X8 SOLID LUMBER, LOCATED BETWEEN 32 AND 39-1/2 ABOVE THE FINISHED FLOOR FLUSH WITH WALL FRAMING ON BOTH SIDE WALLS OF THE FIXTURE.

ELECTRICAL OUTLETS, SWITCH, AND CONTROL HEIGHTS SHALL BE LOCATED NO MORE THAN 48" MEASURED FROM THE TOP OF THE OUTLET BOX AND NOT LESS THAN 15" MEASURED FROM THE BOTTOM OF THE OUTLET BOX ABOVE

THE FINISHED FLOOR (SECTION R327.1.2). SHOW DIMENSION ON ELEVATION.

DOORBELL BUTTONS SHALL NOT EXCEED 48" ABOVE EXTERIOR FLOOR OR LANDING. (SECTION R327.1.4). SHOW DIMENSION ON ELEVATION.

INTERIOR DOORS: EFFECTIVE JULY 1, 2024, AT LEAST ONE BATHROOM AND ONE BEDROOM ON THE ENTRY LEVEL SHALL PROVIDE A DOORMAY WITH A NET CLEAR OPENING OF NOT LESS THAN 32 INCHES, MEASURED WITH THE DOOR POSITIONED AT AN ANGLE OF 90 DEGREES FROM THE CLOSE POSITION; OR, IN THE CASE OF A TWO- OR THREE-STORY SINGLE FAMILY DWELLING, ON THE SECOND OR THIRD FLOOR OF THEY DWELLING IF A BATHROOM OR BEDROOM IS NOT LOCATED ON THE ENTRY LEVEL.

- CAPABLE FOR USE AS FIXED SHOWER HEAD AND HAND HELD SHOWER - ON/OFF CONTROL WITH NON-POSITIVE SHUT OFF


- LOCATED MINIMUM 19 INCHES AND MAXIMUM 27 INCHES FROM SEAT WALL LOCATED ABOVE GRAB BAR BUT NO HIGHER THAN 48 INCHES ABOVE SHOWER FLOOR

OPERABLE PARTS OF SHOWER CONTROLS AND FAUCETS:

- OPERABLE WITH MAXIMUM 5 POUNDS OF FORCE

OPTIONAL ROLL-IN SHOWER PLAN NOTES

Sheet Number

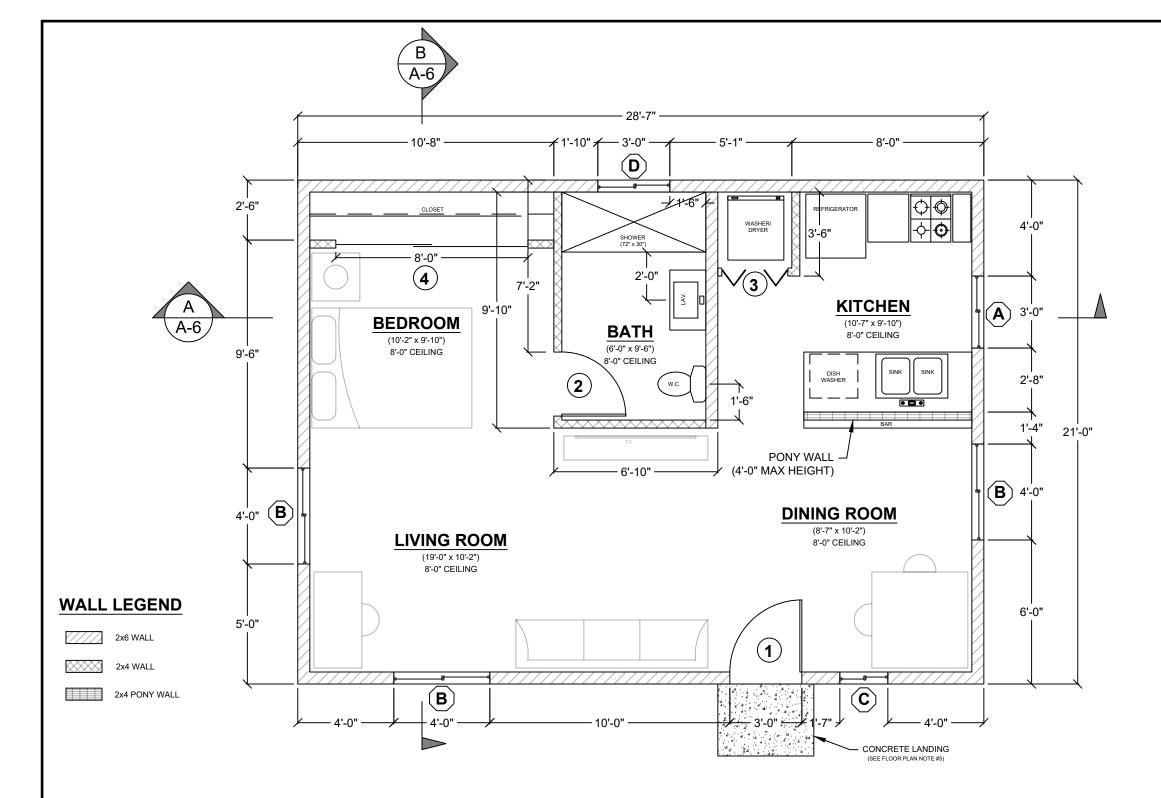

WINDOW SCHEDULE							
MARK	DIMENSION	TYPE	TEMPERED	NOTES			
(A)	3'-0" x 4'-0"	SLIDING					
(B)	4'-0" x 4'-0"	SLIDING					
0	2'-0" x 3'-0"	SLIDING	Y				
0	3'-0" x 2'-0"	SLIDING	Y				

EXTERIOR WINDOWS, EXTERIOR GLAZED DOORS, GLAZED OPENINGS WITHIN EXTERIOR DOORS, GLAZED OPENINGS WITHIN EXTERIOR GARAGE DOORS, AND EXTERIOR STRUCTURAL GLASS VENEER SHALL COMPLY WITH ONE OF THE

- EXTERIOR STRUCTURAL GLASS VENEER SHALL COMPLY WITH ONE OF THE FOLLOWING: (SELECT ONE)

 A. MULTI-PANE GLAZING WITH A MINIMUM OF ONE TEMPERED PANE MEETING THE REQUIREMENTS OF SECTION 2406 SAFETY GLAZING, AND WHERE ANY GLAZING FRAMES MADE OF VINYL MATERIALS SHALL HAVE WELDED CORNERS, METAL REINFORCEMENT IN INTERLOCK AREA, AND BE CEPTIFIED TO ANAMANDE AND THE CONTROL OF THE CONTROL OF THE PROPERTY O BE CERTIFIED TO AAMA/WDMA/CSA 101/I.S.2/A40
- B. MINIMUM 20-MIN FIRE-RESIS I ANCE-RATED.
 C. MEET PERFORMANCE REQUIREMENTS OF SFM STANDARD 12-7A-2 MINIMUM 20-MIN FIRE-RESISTANCE-RATED.

DOOR SCHEDULE								
MARK	DIMENSION	TYPE	TEMPERED	NOTES				
1	3'-0" x 6'-8"	SWINGING		1-3/8" SOLID CORE				
(2) 2'-8" x 6'-8"		SWINGING						
3		BI-FOLD		LAUNDRY ROOM				
(4) 8'-0" x 6'-8"		SLIDING		6FT CLOSET				
				·				

- STILES AND PAILS MINIMOM 1-1/4 INCHES THICK
- RAISED PANELS MINIMOM 1-1/4 INCHES THICK
- EXCEPTION: EXTERIOR PERIMETER OF RAISED PANEL MAY TAPER TO
A TONGUE MINIMUM 38 INCHES THICK
MINIMUM 20-MIN FIRE RATED WHEN TESTED PER NFPA 252

EXTERIOR DOORS SHALL COMPLY WITH ONE OF THE FOLLOWING: (SELECT ONE)
A. EXTERIOR SURFACE OR CLADDING OF NON-COMBUSTIBLE OR IGNITION-RESISTANT MATERIAL

SOLID CORE WOOD COMPLYING WITH THE FOLLOWING: STILES AND RAILS MINIMUM 1-3/8 INCHES THICK

C. MINIMUM 20-MIN FIRE RATED WHEN 1ESTED FER NITROGED.

D. MEET PERFORMANCE REQUIREMENTS OF SFM STANDARD 12-7A-1

FLOOR PLAN 1/4" = 1'-0"

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Sheet Number

using these a d all claims, li rsons or prop By and and per Service

LOCAL EXHAUST FANS TO EXTERIOR TO PROVIDE MINIMUM 50 CFM INTERMITTENT OR 20 CFM CONTINUOUS VENTILATION.

SMOKE DETECTORS TO BE INTERCONNECTED PER CRC R314.4 AND HARD-WIRED WITH BATTERY BACK-UP PER CRC R314.6

UTILITY PLAN NOTES

CARBON MONOXIDE ALARMS TO BE INTERCONNECTED PER CRC R315.7 AND HARD-WIRED WITH BATTERY BACK-UP PER CRC R315.5

4" Ø DRYER VENT WITH MAXIMUM 14 FOOT COMBINED HORIZONTAL AND VERTICAL LENGTH WITH TWO 90 DEGREE ELBOWS.

A MECHANICAL EXHAUST VENTILATION SYSTEM, SUPPLY VENTILATION SYSTEM, OR COMBINATION THEREOF SHALL BE INSTALLED FOR EACH DWELLING UNIT TO PROVIDE WHOLE-BUILDING VENTILATION WITH OUTDOOR AIR IN COMPLIANCE WITH ASHRAE STANDARD 62.2 AS ADOPTED BY THE CALIFORNIA ENERGY COMMISSION.

AN INTERMITTENTLY OR CONTINUOUSLY OPERATING LOCAL MECHANICAL EXHAUST VENTILATION SYSTEM SHALL BE INSTALLED IN EACH BATHROOM WITH A BATHTUB, SHOWER, OR SIMILAR MOISTURE SOURCE AND IN EACH KITCHEN IN COMPLIANCE WITH ASHRAE STANDARD 62.2 AS ADOPTED BY THE CALIFORNIA ENERGY COMMISSION. INTERMITTENT LOCAL EXHAUST VENTILATION AIRFLOW RATES SHALL BE 50 CFM IN BATHROOMS AND 100 CFM IN KITCHENS. CONTINUOUS LOCAL EXHAUST VENTILATION AIRFLOW RATES SHALL BE 20 CFM IN BATHROOMS AND 5 AIR CHANGES PER HOUR IN KITCHENS BASED ON KITCHEN VOLUME.

WATER HEATER OR FURNACE SHALL BE A DIRECT-VENT APPLIANCE

. LISTED GASKETED SELF-CLOSING DOOR REQUIRED FOR GAS FAU

LIGHTING PLAN NOTES

RESERVED SPACE SHALL BE PERMANENTLY MARKED AS 'FOR TUTURE 240V USE'; AND C. EITHER A DEDICATED COLD—WATER SUPPLY, OR THE COLD—WATER SUPPLY SHALL PASS THROUGH THE DESIGNATED HPWH LOCATION JUST BEFORE REACHING THE GAS OR PROPANE WATER HEATER; AND d. THE HOT WATER SUPPLY PIPE COMING OUT OF THE GAS OR PROPANE WATER HEATER SHALL BE ROUTED FIRST THROUGH THE DESIGNATED HPWH LOCATION BEFORE SERVING ANY THRURES; AND C. THE HOT AND COLD—WATER PIPING AT THE DESIGNATED HPWH LOCATION SHALL BE EXPOSED AND READILY ACCESSIBLE FOR FUTURE INSTALLATION OF AN HPWH; AND f. A CONDENSATE DRAIN THAT IS NO MORE THAN 2 INCHES HIGHER THAN THE BASE OF THE INSTALLED WATER HEATER AND ALLOWS NATURAL DRAINING WITHOUT PUMP ASSISTANCE. ALL LUMINARIES SHALL BE HIGH-EFFICACY IN ACCORDANCE WITH CBEES TABLE 150.0-A

2. ALL LED LUMINARIES AND LAMPS SHALL BE MARKED "JAB" AND LISTED IN THE CALIFORNIA ENERGY COMMISSION DATABASE AT: https://cacertappliances.energy.ca.gov/pages/appliancesearch.aspx

ALL RECESSED DOWNLIGHT AND ENCLOSED LUMINARIES SHALL BE MARKED "JA8-E" AND LISTED IN THE CALIFORNIA ENERGY COMMISSION DATABASE AT: HTTPS://CACERTAPPLIANCES.ENERGY.CA.GOV/PAGES/APPLIANCESEARCH.ASPX

RECESSED DOWNLIGHT LUMINARIES IN CEILINGS SHALL NOT BE

BATHROOMS, GARAGES, LAUNDRY ROOMS, AND UTILITY ROOMS: AT LEAST ONE LUMINARIES IN EACH SPACE SHALL BE CONTROLLED BY A VACANCY SENSOR

ALL LUMINARIES REQUIRING "JAB" OR "JAB-E" MARKING SHALL CONTROLLED BY A DIMMER OR VACANCY SENSOR EXCEPTION: CLOSETS LESS THAN 70 S.F. & HALLWAYS

OUTDOOR LIGHTING PERMANENTLY MOUNTED TO BUILDINGS SHALL BE CONTROLLED BY ONE OF THE FOLLOWING:

- PHOTOCONTROL AND MOTION SENSOR

- PHOTOCONTROL AND AUTOMATIC TIME-SWITCH CONTROL

- ENERGY MANAGEMENT CONTROL SYSTEM PER CBEES 150.0(K)3AIIIC ENERGY STORAGE SYSTEMS (ESS) NOTES

AT LEAST ONE OF THE FOLLOWING SHALL BE PROVIDED:

a. ESS READY INTERCONNECTION EQUIPMENT WITH A MINIMUM BACKED-UP CAPACITY OF 60 AMPS AND A MINIMUM OF FOUR ESS-SUPPLIED BRANCH CIRCUITS, OR

b. A DEDICATED RACEWAY FROM THE MAIN SERVICE TO A PANELBOARD (SUBPANEL) THAT SUPPLIES THE BRANCH CIRCUITS IN SECTION

(SUBPARELY) IN SUPPLIES THE BRANCH CIRCUITS ARE PERMITTED TO BE SUPPLIED BY THE MAIN SERVICE PANEL PRIOR TO THE INSTALLATION OF AN ESS. THE TRADE SIZE OF THE RACEWAY SHALL BE NOT LESS THAN ONE INCH. THE PANELBOARD THAT SUPPLIES THE BRANCH

CIRCUITS (SUBPANEL) MUST BE LABELED "SUBPANEL SHALL INCLUDE

GAS or PROPANE COOKTOPS NOTES

GAS or PROPANE HEAT PUMPS NOTES

SYSTEMS USING GAS OR PROPANE FURNACE TO SERVE INDIVIDUAL DWELLING UNITS SHALL INCLUDE THE FOLLOWING:

A DEDICATED 240-VOLT BRANCH CIRCUIT WIRING SHALL BE INSTALLED WITHIN 3 FEET FROM THE FURNACE AND ACCESSIBLE TO THE FURNACE WITH NO OBSTRUCTIONS. THE BRANCH CIRCUIT CONDUCTORS SHALL BE RATED AT 30 AMPS MINIMUM. THE BLANK COVER SHALL BE IDENTIFIED

AS '240V READY.' ALL ELECTRICAL COMPONENTS SHALL BE INSTALLED IN ACCORDANCE WITH THE CALIFORNIA ELECTRICAL CODE.

THE MAIN ELECTRICAL SERVICE PANEL SHALL HAVE A RESERVED SPACE TO ALLOW FOR THE INSTALLATION OF A DOUBLE POLE CIRCUIT BREAKER FOR A FUTURE HEAT PUMP SPACE HEATER INSTALLATION. THE RESERVED SPACE SHALL BE PERMANENTLY MARKED AS FOR

GAS or PROPANE WATER HEATERS NOTES

Systems using gas or propane water heaters to serve individual dwelling units shall designate a space at least 2.5 feet by 2.5 feet wide and 7 feet tall suitable for the future installation of

A HEAT PUMP WATER HEATER (HPWH) BY MEETING EITHER A OR B BELOW ALL ELECTRICAL COMPONENTS SHALL BE INSTALLED IN ACCORDANCE WITH

IF THE DESIGNATED SPACE IS WITHIN 3 FEET FROM THE WATER HEATER, THEN THIS SPACE SHALL INCLUDE THE FOLLOWING:

a. A DEDICATED 125-VOLT, 20-AMP ELECTRICAL RECEPTACLE THAT IS

A DEDICATED 125-VOLT, 20-AMP ELECTRICAL RECEPTACLE THAT IS CONNECTED TO THE LECTRIC PANEL WITH A 120/240-VOLT 3 CONDUCTOR, 10 AWG COPPER BRANCH CIRCUIT, WITHIN 3 FEET FROM THE WATER HEATER AND ACCESSIBLE TO THE WATER HEATER WITH NO OBSTRUCTIONS; AND

 BOTH ENDS OF THE UNUSED CONDUCTOR SHALL BE LABELED WITH THE WORD "SPARE" AND BE ELECTRICALLY ISOLATED; AND

C. A RESERVED SINGLE POLE CIRCUIT BREAKER SPACE IN THE ELECTRICAL PANEL ADJACENT TO THE CIRCUIT BREAKER FOR THE BRANCH CIRCUIT IN A ABOVE AND LABELED WITH THE WORDS "FUTURE 240V USE".

C. A CONDENSATE DRAIN THAT IS NO MORE THAN 2 INCHES HIGHER THAN THE BASE OF THE INSTALLED WATER HEATER AND ALLOWS NATURAL DRAINING WITHOUT PUMP ASSISTANCE.

IF THE DESIGNATED SPACE IS MORE THAN 3 FEET FROM THE WATER HEATER, THEN THIS SPACE SHALL INCLUDE THE FOLLOWING:

a. A DEDICATED 240-VCUT BRANCH CIRCUIT SHALL BE INSTALLED WITHIN 3 FEET FROM THE DESIGNATED SPACE. THE BRANCH CIRCUIT SHALL BE REATED AT 30 AMPS MINIMUM. THE BLANK COVER SHALL BE INSTALLED.

SHALL BE KAIED AT 30 AMPS MINIMUM. THE BLANK COVER SHALL BE IDENTIFIED AS "240V READY", AND
THE MAIN ELECTRICAL SERVICE PANEL SHALL HAVE A RESERVED SPACE TO ALLOW FOR THE INSTALLATION OF A DOUBLE POLE CIRCUIT BREAKER FOR A FUTURE HPWH INSTALLATION. THE RESERVED SPACE SHALL BE PERMANENTLY MARKED AS "FOR INTERIOR OF ALLOW, LIST".

SYSTEMS USING GAS OR PROPANE COOKTOP TO SERVE INDIVIDUAL DWELLING UNITS SHALL INCLUDE THE FOLLOWING:

A DEDICATED 240-VOLT BRANCH CIRCUIT WIRING SHALL BE INSTALLED WITHIN 3 FEET FROM THE COOKTOP AND ACCESSIBLE TO THE COOKTOP WITH NO OBSTRUCTIONS. THE BRANCH CIRCUIT CONDUCTORS SHALL BE RATED AT 50 AMPS MINIMUM. THE BLANK COVER SHALL BE IDENTIFIED AS '240V READY.' ALL ELECTRICAL COMPONENTS SHALL BE INSTALLED IN ACCORDANCE WITH THE CALIFORNIA ELECTRICAL CODE.

THE MAIN ELECTRICAL SERVICE PANEL SHALL HAVE A RESERVED SPACE TO ALLOW FOR THE INSTALLATION OF A DOUBLE POLE CIRCUIT BREAKER FOR A FUTURE ELECTRIC COOKTOP INSTALLATION. THE RESERVED SPACE SHALL BE PERMANENTLY MARKED AS 'FOR FUTURE

GAS or PROPANE CLOTHES DRYERS NOTES

CLOTHES DRYER LOCATIONS WITH GAS OR PROPANE PLUMBING TO SERVE INDIVIDUAL DWELLING UNITS SHALL INCLUDE THE FOLLOWING:

A DEDICATED 240-VOLT BRANCH CIRCUIT WIRING SHALL BE INSTALLED WITHIN 3 FEET FROM THE CLOTHES DRYER LOCATION AND ACCESSIBLE TO THE CLOTHES DRYER LOCATION WITH NO OBSTRUCTIONS. THE BRANCH CIRCUIT CONDUCTORS SHALL BE RATED AT 30 AMPS MINIMUM. THE BLANK COVER SHALL BE IDENTIFIED AS '240V READY.' ALL ELECTRICAL COMPONENTS SHALL BE INSTALLED IN ACCORDANCE WITH THE CALIFORNIA ELECTRICAL CODE.

THE MAIN ELECTRICAL SERVICE PANEL SHALL HAVE A RESERVED SPACE TO ALLOW FOR THE INSTALLATION OF A DOUBLE POLE CIRCUIT BREAKER FOR A FUTURE ELECTRIC CLOTHES DRYER INSTALLATION. THE RESERVED SPACE SHALL BE PERMANENTLY MARKED AS 'FOR FUTURE


A MINIMUM OF FOUR BRANCH CIRCUITS SHALL BE IDENTIFIED AND HAVE THEIR SOURCE OF SUPPLY COLLOCATED AT A SINGLE PANELBOARD SUITABLE TO BE SUPPLIED BY THE ESS. AT LEAST ONE CIRCUIT SHALL SUPPLY THE REFRIGERATOR, ONE LIGHTING CIRCUIT SHALL BE LOCATED NEAR THE PRIMARY EGRESS, AND AT LEAST ONE CIRCUIT SHALL SUPPLY A SLEEPING ROOM RECEPTACLE OUTLET.

THE MAIN PANELBOARD SHALL HAVE A MINIMUM BUSBAR RATING OF 225 AMPS.

SUFFICIENT SPACE SHALL BE RESERVED TO ALLOW FUTURE INSTALLATION OF A SYSTEM ISOLATION EQUIPMENT/TRANSFER SWITCH WITHIN 3 FEET OF THE MAIN PANELBOARD. RACEWAYS SHALL BE INSTALLED BETWEEN THE PANELBOARD AND THE SYSTEM ISOLATION EQUIPMENT/TRANSFER SWITCH LOCATION TO ALLOW THE CONNECTION OF DISCUILE PROMED SOLIDES. OF BACKUP POWER SOURCE.

SOLAR READY KEY NOTES

- THE MAIN ELECTRICAL SERVICE PANEL SHALL NOT BE OF A TYPE WITH A CENTER-FED MAIN CIRCUIT BREAKER AND SHALL INCLUDE RESERVED SPACE ALLOWING FOR INSTALLATION OF DOUBLE-POLE CIRCUIT BREAKERS FOR A FUTURE SOLAR PHOTOVOLTAIC SYSTEM. SUCH RESERVED SPACE SHALL BE POSITIONED AT THE OPPOSITE (LOAD) END FROM THE INPUT FEEDER OR MAIN CIRCUIT BREAKER LOCATION. THE RESERVED SPACE SHALL BE PERMANENTLY AND VISIBLY MAPPER AS FOR ELITIBLE SOLAR PHOTOVOLTAIC. VISIBLY MARKED AS "FOR FUTURE SOLAR PHOTOVOLTAIC"
- APPROVED MINIMUM 4-INCH SQUARE ELECTRICAL JUNCTION BOX LOCATED WITHIN 72 INCHES HORIZONTALLY AND 12 INCHES VERTICALLY OF MAIN ELECTRICAL SERVICE PANEL
- MINIMUM 1 INCH DIAMETER LISTED ELECTRICAL METALLIC RACEWAY ORIGINATING AT READILY ACCESSIBLE ATTIC LOCATION WITH PROXIMITY TO SOLAR ZONE AREA AND TERMINATING AT THE REQUIRED ELECTRICAL JUNCTION BOX
- MINIMUM 1 INCH DIAMETER LISTED ELECTRICAL METALLIC RACEWAY ORIGINATING AT THE REQUIRED ELECTRICAL JUNCTION BOX AND TERMINATING AT THE MAIN ELECTRICAL SERVICE PANEL
- ELECTRICAL JUNCTION BOX AND SEGMENT OF METALLIC RACEWAY IN THE ATTIC SHALL BE PERMANENTLY AND VISIBLY MARKED AS "FOR FUTURE SOLAR PHOTOVOLTAIC"

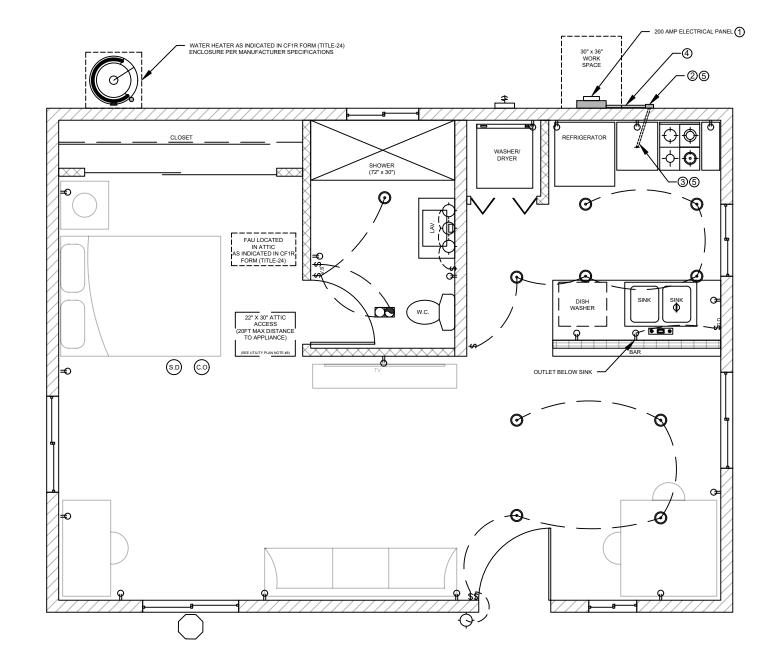

ELECTRICAL LEGEND O= 0 HIGH EFFICACY RECESSED LIGHT DUPLEX OUTLET WALL SWITCH GARBAGE DISPOSAL \$ GARBAGE DISPOSAL SWITCH VACANCY SENSOR 4" DIA DRYER VENT ➂ SMOKE DETECTOR CARBON MONOXIDE ALARM FAN & LIGHT COMBO 08 FAN AND LIGHT COMBINATION HIGH EFFICACY LIGHT FIXTURE

ELECTRICAL PLAN

1/4" = 1'-0'

WILDFIRE ZONE PLAN NOTES

- IN ROOF COVERINGS WHERE THE PROFILE CREATES SPACE BETWEEN THE ROOF COVERING AND COMBUSTIBLE ROOF DECKING, SPECIFY ONE OF THE FOLLOWING MEANS OF PROTECTING SPACES AT EAVES ENDS: 0. FIRE-STOPPING WITH APPROVED MATERIALS
- G. FIRE—STOPPING WITH APPROVED MATERIALS

 D. ONE LAYER OF 72 POUND (32.4 KG) MINERAL—SURFACED

 NON—PERFORATED CAP SHEET COMPLYING WITH ASTM D 3909

 INSTALLED OVER THE COMBUSTIBLE DECKING

 C. OTHERWISE CONSTRUCTED TO PREVENT INTRUSION OF FLAMES AND
- 2. EXPOSED VALLEY FLASHINGS SHALL BE CONSTRUCTED WITH NOT LESS THAN 0.019-INCH (NO. 26 GALVANIZED SHEET GAGE) CORROSION-RESISTANT METAL INSTALLED OVER A MINIMUM 36-INCH-WIDE UNDERLAYMENT CONSISTING OF ONE LAYER OF NO. 72 ASTM CAP SHEET RUNNING THE FULL LENGTH OF THE VALLEY.
- 3. ANY ROOF GUTTERS SHALL BE PROVIDED WITH MEANS TO PREVENT ACCUMULATION OF LEAVES AND DEBRIS.
- 4. SKYLIGHTS SHALL BE TEMPERED GLASS.
- 5. ALL VENTS (ROOF, FOUNDATION, COMBUSTION—AIR, ETC) SHALL RESIST THE INTRUSION OF FLAMES AND EMBERS
- VENTILATION OPENINGS FOR ENCLOSED ATTICS, EAVE SOFFIT SPACES, ENCLOSED RAFTER SPACES FORMED WHERE CELINGS ARE APPLIED DIRECTLY TO THE UNDERSIDE OF ROOF RAFTERS, UNDERFLOOR VENTILATION OPENINGS, AND VENT OPENINGS IN EXTERIOR WALLS AND EXTERIOR DOORS SHALL BE LISTED TO ASTM E 2886 AND COMPLY WITH ALL OF THE FOLLOWING:

 a. THERE SHALL BE NO FLAMING IGNITION OF THE COTTON MATERIAL DURING THE EMBER INTRUSION TEST
 b. THERE SHALL BE NO FLAMING IGNITION DURING THE INTEGRITY TEST PORTION OF THE FLAME INTRUSION TEST
 c. THE MAXIMUM TEMPERATURE OF THE UNEXPOSED SIDE OF THE VIPIL SHALL NOT EXCEPT AS Q. DEGREES EAMPENHETI (350 DEGREES
- VENT SHALL NOT EXCEED 662 DEGREES FAHRENHEIT (350 DEGREES
- 7. EXTERIOR WALL FINISH SHALL COMPLY WITH ONE OF THE FOLLOWING: a. NON-COMBUSTIBLE MATERIAL (STUCCO, CEMENT FIBER BOARD, ETC)
 - STUCCO AND CEMENT PLASTER USED AS AN EXTERIOR WALL COVERING SHALL BE 7/8-INCH THICK
 - OVERING SHALL BE 78—INCH IHICK

 NONCOMBUSTIBLE OR FIRE—RETARDANT—TREATED WOOD SHAKE
 USED AS AN EXTERIOR WALL COVERING SHALL HAVE AN
 UNDERLAYMENT OF MINIMUM 1/2—INCH FIRE—RATED GYPSUM
 SHEATHING THAT IS TIGHTLY BUTTED, OR TAPED AND MUDDED, OR
 AN UNDERLAYMENT OF OTHER IGNITION—RESISTANT MATERIAL
 APPROVED BY THE BUILDING OFFICIAL.
- b. IGNITION-RESISTANT MATERIAL
- 8. PATIO COVER, CARPORT AND TRELLIS CONSTRUCTION WITH ALL EXPOSED ELEMENTS SHALL COMPLY WITH ANY OF THE FOLLOWING:
 - 1-HOUR FIRE-RESISTANT-RATED MATERIAL
 - APPROVED EXTERIOR FIRE-RETARDANT TREATED WOOD
 - MODIFIED HEAVY TIMBER (MIN 2X TONGUE-AND-GROOVE SHEATHING, 4X6 RAFTERS/BEAMS, 6X6 POSTS)
- . DECK, BALCONY, AND EXTERIOR STAIR CONSTRUCTION, WITH ALL EXPOSED ELEMENTS SHALL COMPLY WITH THE FOLLOWING: a. FRAMING - NON-COMBUSTIBLE MATERIAL

 - 1-HOUR FIRE-RESISTANT-RATED MATERIAL
 - APPROVED EXTERIOR FIRE-RETARDANT TREATED WOOD - MODIFIED HEAVY TIMBER (MIN 4X8 JOISTS, 4X10 OR 6X8 BEAMS,
- b. DECKING AND TREAD MATERIAL (ANY OF THE FOLLOWING):
- NON-COMBUSTIBLE MATERIAL
- 1-HOUR FIRE-RESISTANT-RATED MATERIAL - APPROVED EXTERIOR FIRE-RETARDANT TREATED WOOD
- APPROVED ALTERNATIVE DECKING MATERIAL MEETING TESTS REQUIREMENTS OF COUNTY BUILDING CODE 92.1.709A.1.4)
- 10. EXTERIOR GARAGE DOORS SHALL RESIST THE INTRUSION OF EMBERS INTO THE GARAGE BY LIMITING THE SIZE OF ANY GAPS AT THE BOTTOM, SIDES, AND TOP OF THE DOOR TO 1/8 INCH OR LESS
- USING ONE OF THE FOLLOWING METHODS:

 a. WEATHER-STRIPPING PRODUCTS WITH TENSILE STRENGTH AND FLAMMABILITY RATING PER CBC 708A.4
- b. DOOR OVERLAPS ONTO JAMBS AND HEADERS
 C. GARAGE DOOR JAMBS AND HEADERS COVERED WITH METAL FLASHING
- PAPER—FACED INSULATION PROHIBITED IN ATTICS OR OTHER VENTILATED SPACES.
- 12. FENCES OR ANY STRUCTURE WITHIN 5 FEET OF BUILDING SHALL BE CONSTRUCTED PER ONE OF THE FOLLOWING:
- a. NON-COMBUSTIBLE MATERIAL
- b. APPROVED EXTERIOR FIRE-RETARDANT TREATED WOOD c. MATERIAL MEETING SAME FIRE—RESISTIVE STANDARDS AS EXTERIOR WALLS OF BUILDINGS

Sheet Number

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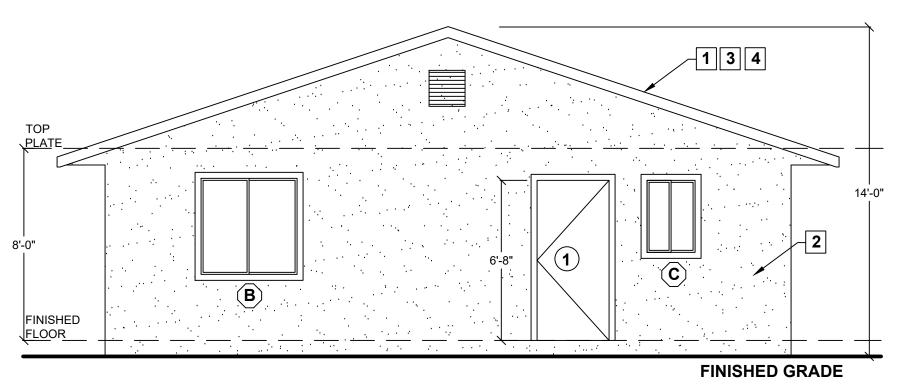
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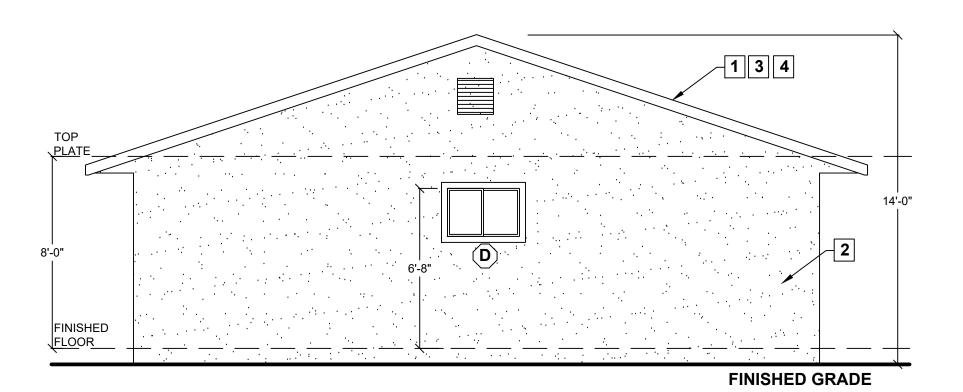
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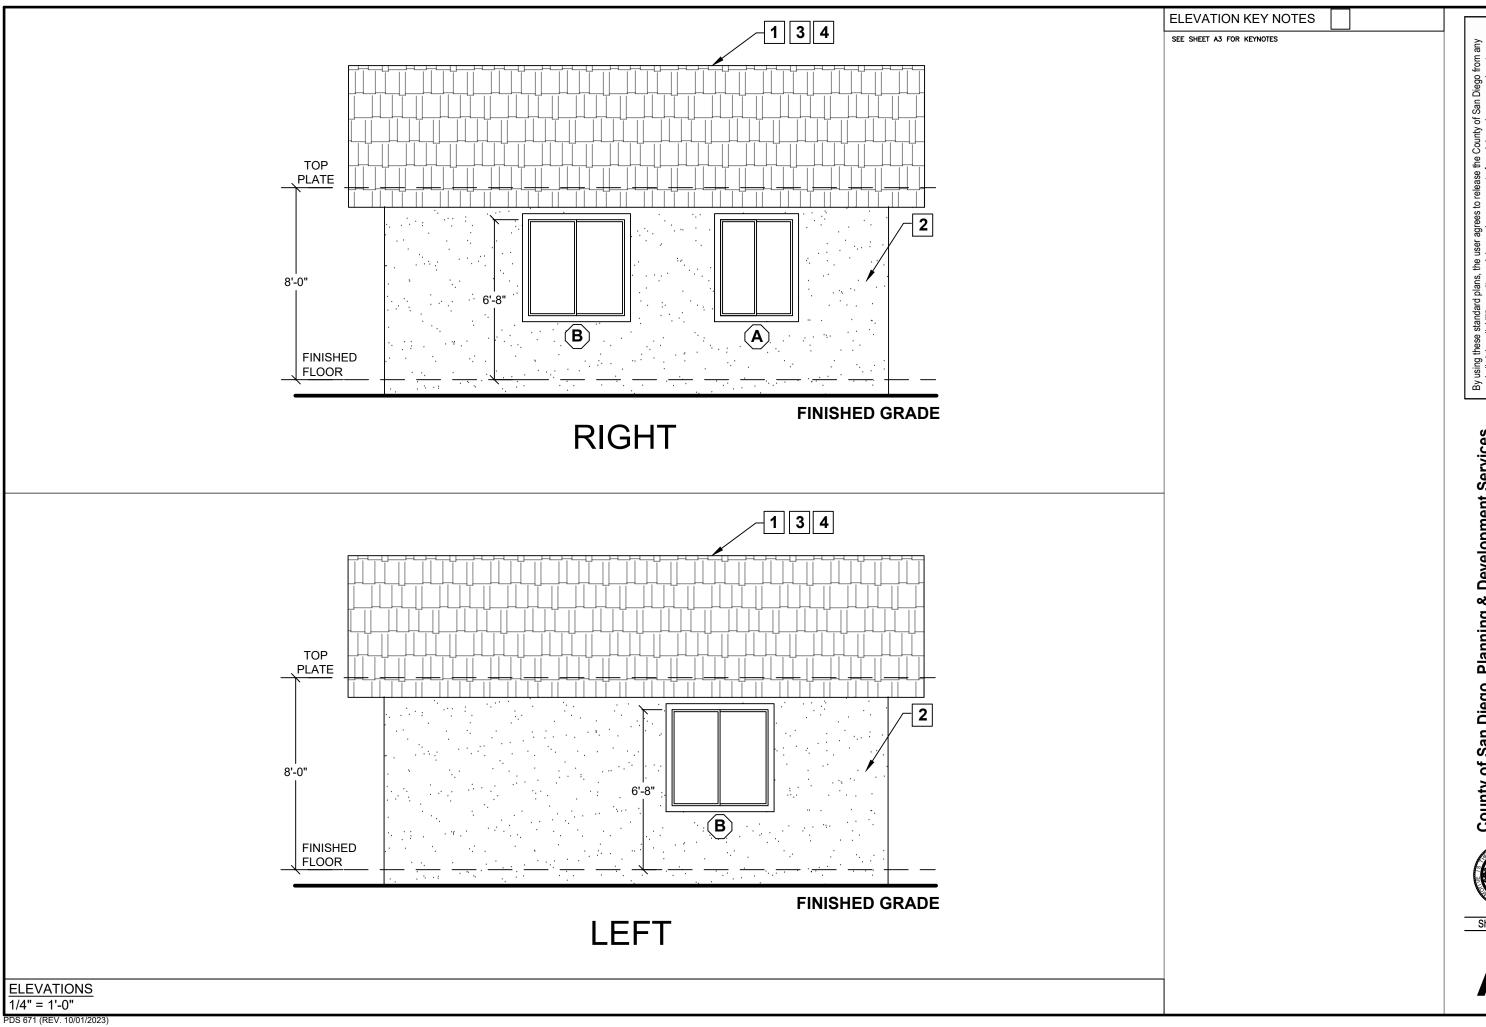
FRONT



BACK

ELEVATIONS 1/4" = 1'-0"

PDS 671 (REV. 10/01/2023)




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County of San Diego, Planning & Development Services DWELLING UNIT (Plan F - 600 SF)

BUILDING DIVISION

Sheet Number

A4

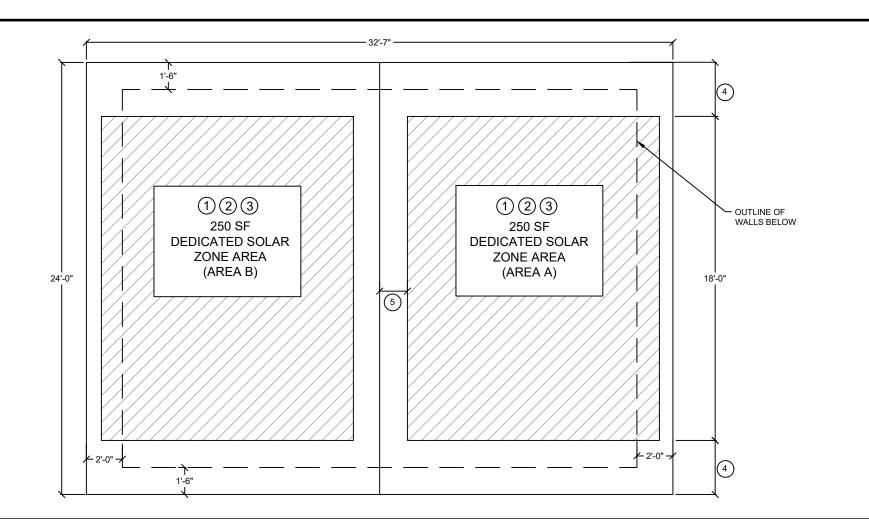

SOLAR READY KEY NOTES (

WHEN PV SYSTEM NOT REQUIRED PER ENERGY COMPLIANCE DOCUMENTATION OR OTHERWISE EXEMPTED:

- 1. MIN 250 S.F. SOLAR ZONE AREA
- DEDICATED SOLAR ZONE AREA LOCATED BETWEEN 110 AND 270 DEGREES OF TRUE NORTH – USE AREA A OR B AS NEEDED.
- 3. NO OBSTRUCTIONS INCLUDING VENTS, CHIMNEYS, SKYLIGHTS, ARCHITECTURAL FEATURES, ROOF—MOUNTED EQUIPMENT LOCATED WITHIN SOLAR ZONE.
- 4. 3' MIN FIRE FIGHTER ACCESS
- 5. 3' SMOKE VENTILATION SETBACK AT RIDGES

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ATTIC VENTILATION

ATTIC VENTILATION REQUIRED
(SEE WILDFIRE NOTES 5 & 6 ON SHEET A3)

NET FREE CROSS VENTILATION AREA = $\frac{1}{300}$

Vent area required = 600 ft²/ 300 = 2ft² x 144 = $\frac{288 \text{ in}^2}{\text{Area Provided}} < \frac{1}{\text{Total Vent}} \text{ in}^2$

	GABLE	VENT	(MIN	ONE	VENT	ΑT	EACH	GABLE	END)
--	-------	------	------	-----	------	----	------	-------	------

MANUFACTURER:	_
MODEL:	
QTY: NFVA:	ir
VENT AREA PROVIDED = QTY x NFVA =	i

2. EAVE VENT

MANUFACTURER:	-
MODEL:	
QTY: NFVA:	i
VENT AREA PROVIDED = QTY x NFVA =	i

3. ROOF VENT

MANUFACTURER:		
MODEL:		
QTY:	NFVA:	. in²
VENT AREA PROVIDED = QTY	× NFVA =	_ in²

4. INSTALL BETWEEN 40% AND 50% OF THE REQUIRED NET FREE VENT AREA A MAXIMUM OF 3 FEET BELOW THE RIDGE OR THE HIGHEST POINT OF THE SPACE (MEASURED VERTICALLY), AND INSTALL THE BALANCE OF THE REQUIRED VENTILATION IN THE BOTTOM ONE—THIRD OF THE ATTIC SPACE.

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A5

GABLE END TRUSS ID:


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GABLE END TRUSS ID:

ROOF PLAN / TRUSS LAYOUT

3/16" = 1'-0"


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			WOOD STR	RUCTURAL PANI	EL SHEATHING		
MARK	MINIMUM NAIL		MINIMUM WOOD STRUCTURAL PANEL SPAN	MINIMUM NOMINAL PANEL THICKNESS	MAXIMUM WALL STUD SPACING (in)	PANEL NAIL SPACING	
	SIZE	PENETRATION (in)		(in)	,	EDGES (inches o/c)	FIELD (inches o/c)
	6D COMMON	1.5	24:0	³ / ₈ "	16	6	12
	8D COMMON	1.75	24:16	⁷ / ₁₆ "	16	6	12

WOOD STRUCTURAL PANELS SHALL CONFORM TO DOC PS 1, DOC PS 2 OR ANSI/APA PRP 210, CSA O437 OR CSA O325. PANELS SHALL BE IDENTIFIED BY A GRADE MARK OR CERTIFICATE OF INSPECTION ISSUED BY AN APPROVED AGENCY

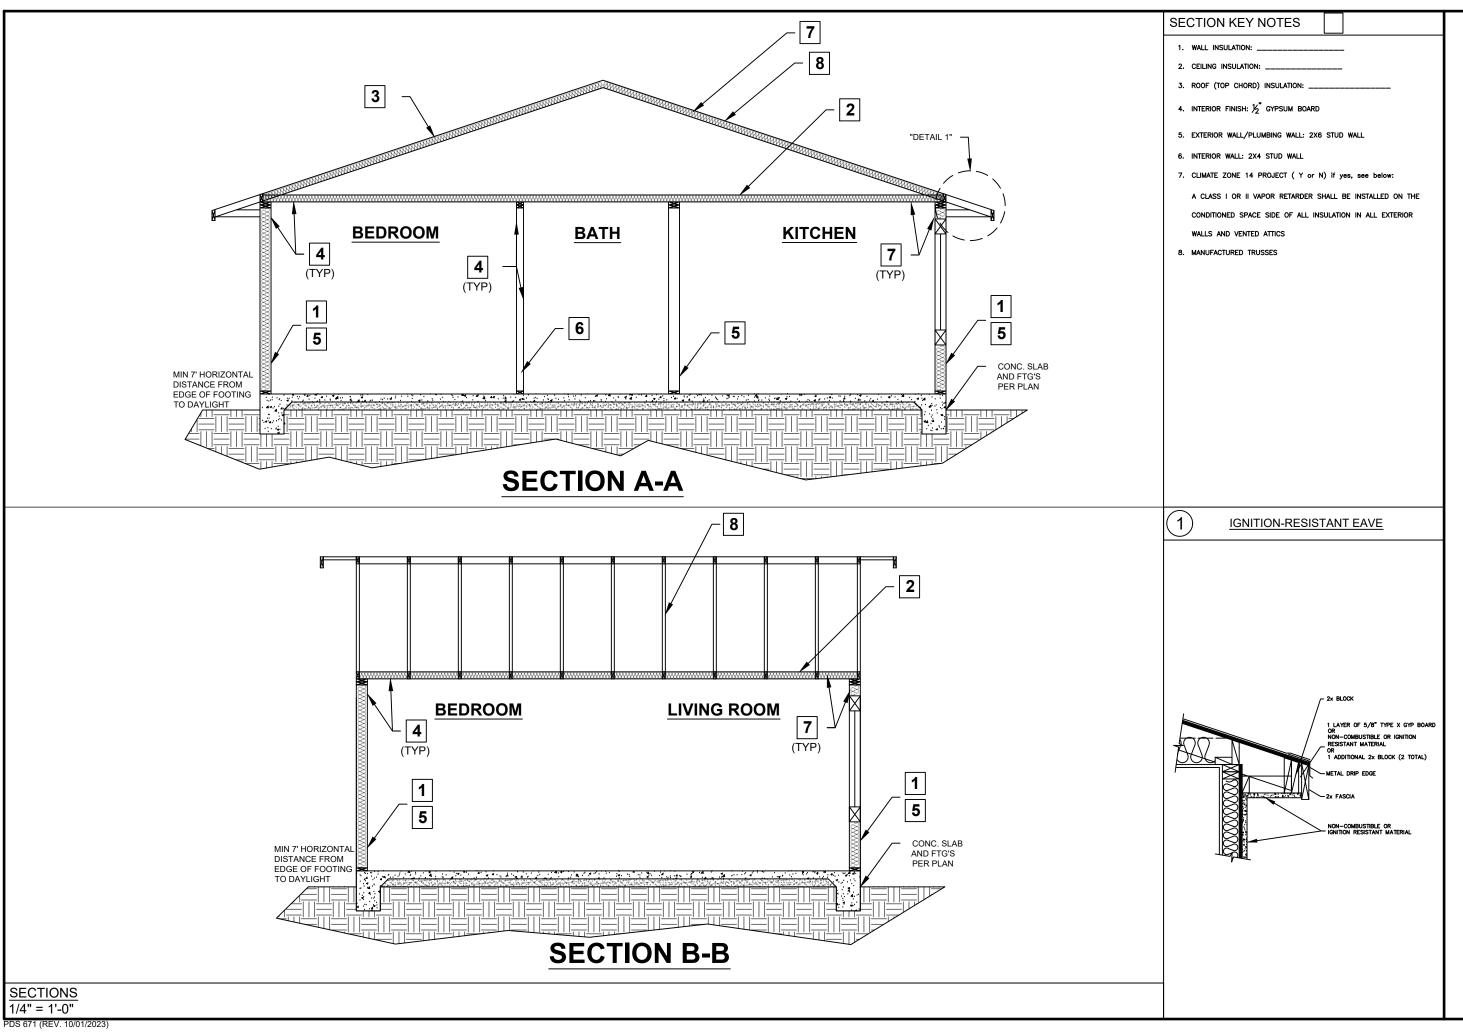VERTICAL JOINTS OF PANEL SHEATHING SHALL OCCUR OVER AND BE FASTENED TO COMMON STUDS. HORIZONTAL JOINTS IN BRACED WALL PANELS SHALL OCCUR OVER AND BE FASTENED TO COMMON BLOCKING OF A MINIMUM 1 ½ INCH THICKNESS.

FOUNDATION PLAN

3/16" = 1'-0"

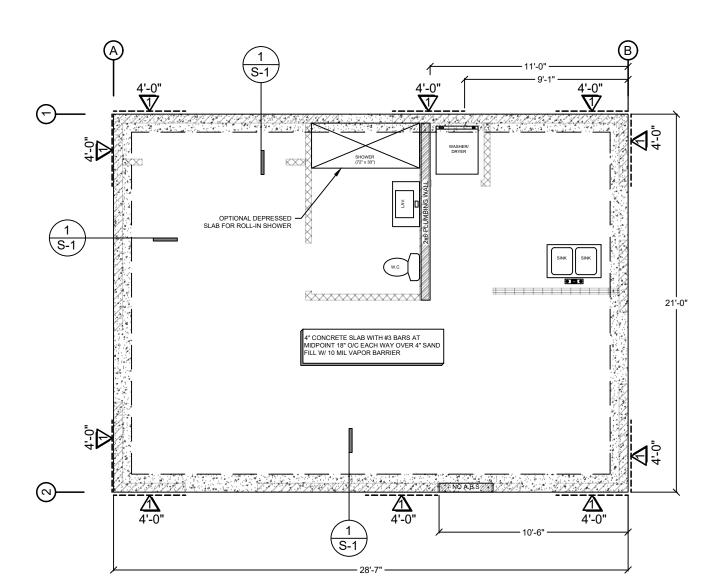FOUNDATION PLAN NOTES

SEE EXTERIOR ELEVATION FOR

2X P.T.D.F. BOTTOM PLATE W/

%" DIA X 10" A.B.'s AT 72" O/C

— 1 - #4 BAR TOP & BOTTOM

MIN 7' HORIZONTAL DISTANCE FROM EDGE OF

FOOTING TO DAYLIGHT

METAL STUCCO SCREED MIN 4" A.F.G.

SURFACE FINISH

OCCURS PER PLAN

- ALL ANCHORS BOLTS SHALL BE % DIAMETER AND HAVE A MINIMUM EMBEDMENT OF 7 INCHES INTO CONCRETE (UNO) AND NOT SPACED MORE THAN 6 FEET APART
- 3"X3"X0.229" PLATE WASHERS SHALL BE USED ON EACH SILL PLATE ANCHOR BOLT
- 3. FOR STANDARD CUT WASHERS PLACED BETWEEN PLATE WASHER AND NUT. HOLE IN PLATE WASHER MAY BE DIAGONALLY SLOTTED WITH MAXIMUM $\frac{3}{4}$ 6" LARGER WIDTH THAN BOLT DIAMETER AND MAXIMUM $1-\frac{3}{4}$ " SLOT LENGTH
- PROVIDE A MINIMUM OF TWO ANCHOR BOLTS PER SILL PLATE WITH ONE BOLT LOCATED MAXIMUM 12" AND MINIMUM 7 BOLT DIAMETERS FROM EACH END OF EACH SECTION.
- 5. BOLTS LOCATED IN THE MIDDLE THIRD OF THE SILL PLATE WIDTH
- 6. FASTENERS FOR PRESSURE-PRESERVATIVE TREATED AND FIRE RETARDANT TREATED WOOD SHALL BE HOT-DIPPED ZINC COATED GALVANIZED, STAINLESS STEEL OR COPPER
- 7. NO LPG PIPING ASSEMBLIES ALLOWED IN OR BENEATH SLABS WITHIN THE STRUCTURE

EXTERIOR FOOTING

SLAB PER

FOUNDATION PLAN


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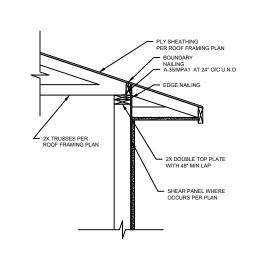
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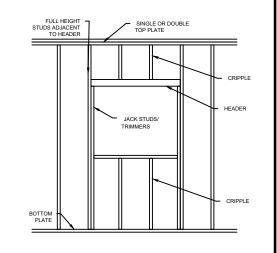


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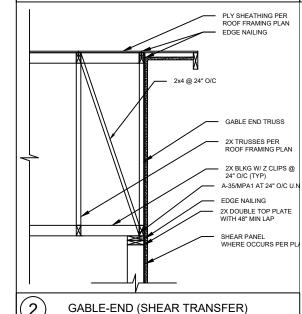
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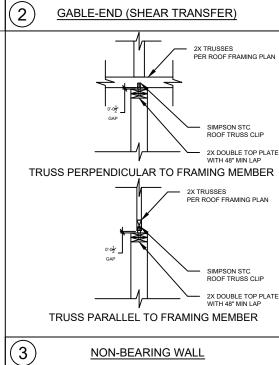






〔1〕 **EAVE (SHEAR TRANSFER)** (4)TYPICAL FRAMING AT OPENING

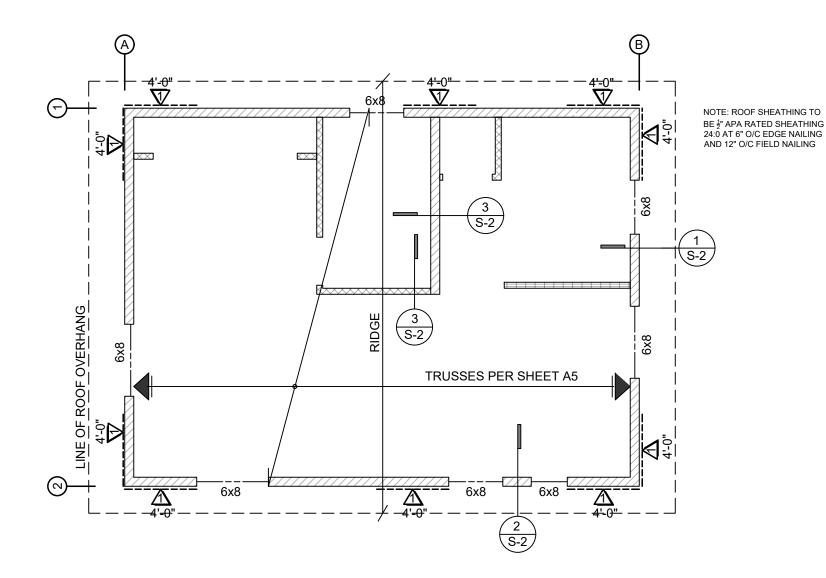



NON-BEARING WALL

WOOD STRUCTURAL PANEL SHEATHING MINIMUM WOOD MINIMUM NAIL MINIMUM NOMINAL PANEL NAIL SPACING STRUCTURAL MAXIMUM WALL STUD MARK PANEL THICKNESS PANEL SPAN SPACING (in) (in) PENETRATION **RATING** SIZE EDGES (inches o/c) FIELD (inches o/c) (in) ³/₈" **6D COMMON** 16 12 1.5 24:0 6 ⁷/₁₆" **8D COMMON** 1.75 24:16 16 6 12

WOOD STRUCTURAL PANELS SHALL CONFORM TO DOC PS 1, DOC PS 2 OR ANSI/APA PRP 210, CSA O437 OR CSA O325. PANELS SHALL BE IDENTIFIED BY A GRADE MARK OR CERTIFICATE OF INSPECTION ISSUED BY AN APPROVED AGENCY

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ROOF FRAMING PLAN

3/16" = 1'-0"