PROJECT DESCRIPTION:

AN ADMINISTRATIVE PERMIT FOR A 750kW PHOTOVOLTAIC SOLAR ENERGY SYSTEM — OFFSITE USE (LESS THAN 10 ACRES) IN ACCORDANCE WITH THE COUNTY OF SAN DIEGO ZONING ORDINANCE SOLAR 395W PANELS, 6 YASKAWA-SOLECTRIA XGI 1500 125kW INVERTERS, AND RELATED ELECTRICAL EQUIPMENT SUCH AS A PAD-MOUNTED TRANSFORMER.

BASIS OF BEARING:

THE BASIS OF BEARING IS THE MEASURED BEARING OF S00°36'45"E ALONG THE EAST LINE OF THE NORTHEAST QUARTER OF SECTION 22, TOWNSHIP 11 SOUTH, RANGE 6 EAST, SAN BERNARDINO BASE AND MERIDIAN, SAN DIEGO COUNTY, CALIFORNIA

LEGAL DESCRIPTION:

THE LAND REFERRED TO HEREIN IS SITUATED IN THE COUNTY OF SAN DIEGO, STATE OF CALIFORNIA, AND IS DESCRIBED AS FOLLOWS:

LOT "B" OF DEEP WELL TRAIL, ACCORDING TO MAP THEREOF #3207, FILED IN THE OFFICE OF THE COUNTY RECORDER OF SAN DIEGO COUNTY, MARCH 30, 1955.


EXCEPTING THEREOF THAT PORTION OF THE ABOVE DESCRIBED PROPERTY COMMENCING AT THE NORTHEAST CORNER OF SECTION 22, TOWNSHIP 11 SOUTH, RANGE 6 EAST, SAN BERNARDINO MERIDIAN, IN THE COUNTY OF SAN DIEGO, STATE OF CALIFORNIA, ACCORDING TO OFFICIAL PLAT THEREOF; THENCE SOUTHERLY ALONG THE EAST LINE OF SECTION 22 SOUTH 0°36'45" EAST A DISTANCE OF 1113.96 FEET; THENCE AT RIGHT ANGLES SOUTH 89°23'15" WEST A DISTANCE OF 293.41 FEET TO THE TRUE POINT OF BEGINNING; THENCE WEST A DISTANCE OF 20.0 FEET; THENCE NORTH A DISTANCE OF 20.0 FEET; THENCE EAST A DISTANCE OF 20.0 FEET; THENCE SOUTH A DISTANCE OF 20.0 FEET TO THE TRUE POINT OF BEGINNING.

APN: 200-067-03-00

BENCHMARK:

REBAR WITH ALUMINUM CAP. "POINT 100"

N = 2020012.18 E = 6538551.52 ELEV = 543.32

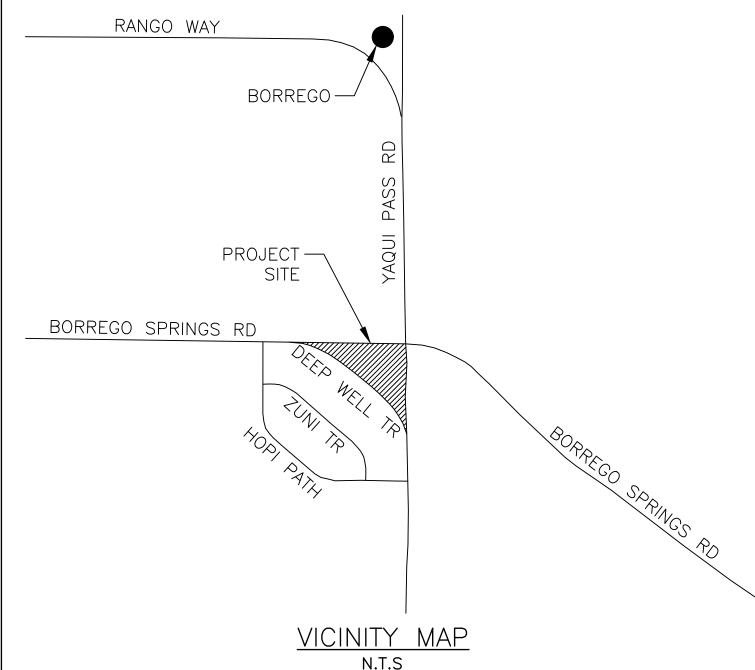

OWNER:

JOHN WELLS

(858)724 - 6040

CWC CASA DEL ZORRO LLC

SAN DIEGO, CA 92130

CWC ASSET ADVISORS

11236 EL CAMINO REAL #200

ADMINISTRATIVE PERMIT PLAN SET

CASA DEL ZORRO SOLAR

3845 YAQUI PASS ROAD BORREGO SPRINGS, CALIFORNIA 92004



APPLICANT:

SUITE 106

ZACH SAWICKI

150 MATILDA PLACE,

SUNNYVALE, CA 94086

PHONE:(720)638-6548

CLEAN FOCUS RENEWABLES

ZACHSAWICKI@CLEANFOCUS.US CURTIS W. SLAGELL

CIVIL ENGINEER

PHOENIX, AZ 85008


LICENSED ENGINEER:

(602)-454-0402

PE#:46218

AZTEC ENGINEERING GROUP, INC.

501 N. 44th STREET, SUITE 300

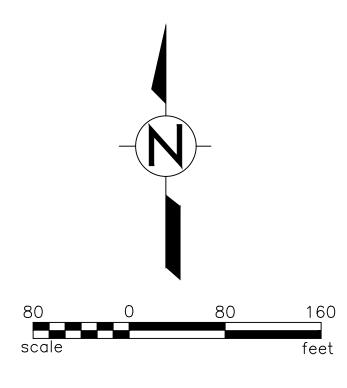

	SHEET INDEX		
SHEET NUMBER	SHEET TITLE		
EX1.01	COVER SHEET		
EX2.01	PLOT PLAN		
EX3.01	EROSION CONTROL PLAN		
EX4.01	PRELIMINARY GRADING PLAN		
EX5.01	STRUCTURAL DETAILS		
EX2.01 EX3.01 EX4.01	PLOT PLAN EROSION CONTROL PLAN PRELIMINARY GRADING PLAN		

<u>LEGEND</u>	
	SECTION LINE
	RIGHT OF WAY LINE
	PROPERTY BOUNDARY
	ACCESS ROAD
	GAME FENCE
— — — — —5510— —	EXISTING MAJOR CONTOUR
— — — — — 5508— —	EXISTING MINOR CONTOUR
	EASEMENT

LAND USE & DEVELOPMENT CONSULTING

MARK J. LINMAN MJLINMAN@COX.NET (619)997-8288

CONTACT

LAND SURVEYOR

PHOENIX, AZ 85008

(602)-454-0402

PLS#:26900

4561 E. MCDOWELL ROAD

JOANNE CHAPIN SINGER

REGISTERED LAND SURVEYOR:


AZTEC ENGINEERING GROUP, INC.

11316 ROLLING HILLS DRIVE EL CAJON, CA 92020

MARK J. LINMAN

Know what's **below. Call** before you dig.

SDC PDS RCVD 11-30-20 AD19-028

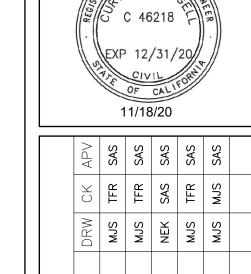

ns= CLEAN FOCUS

CONTRACTOR

REVISIONS	DESCRIPTION	CLIENT REVIEW	ISSUED FOR ADMINISTRATIVE PERMIT	03/20/20 COUNTY COMMENTS	COUNTY COMMENTS	11/18/20 COUNTY COMMENTS	
	DATE	10/23/19	11/0/11	03/20/20	08/11/20	11/18/20	
	REV	0	1	2	3	4	
						1 "_	o

9200

SOLAR Ings, california


ZORRO REGO SPF


CASA SS ROA

EX1.01

22"x34'


AZENE1944

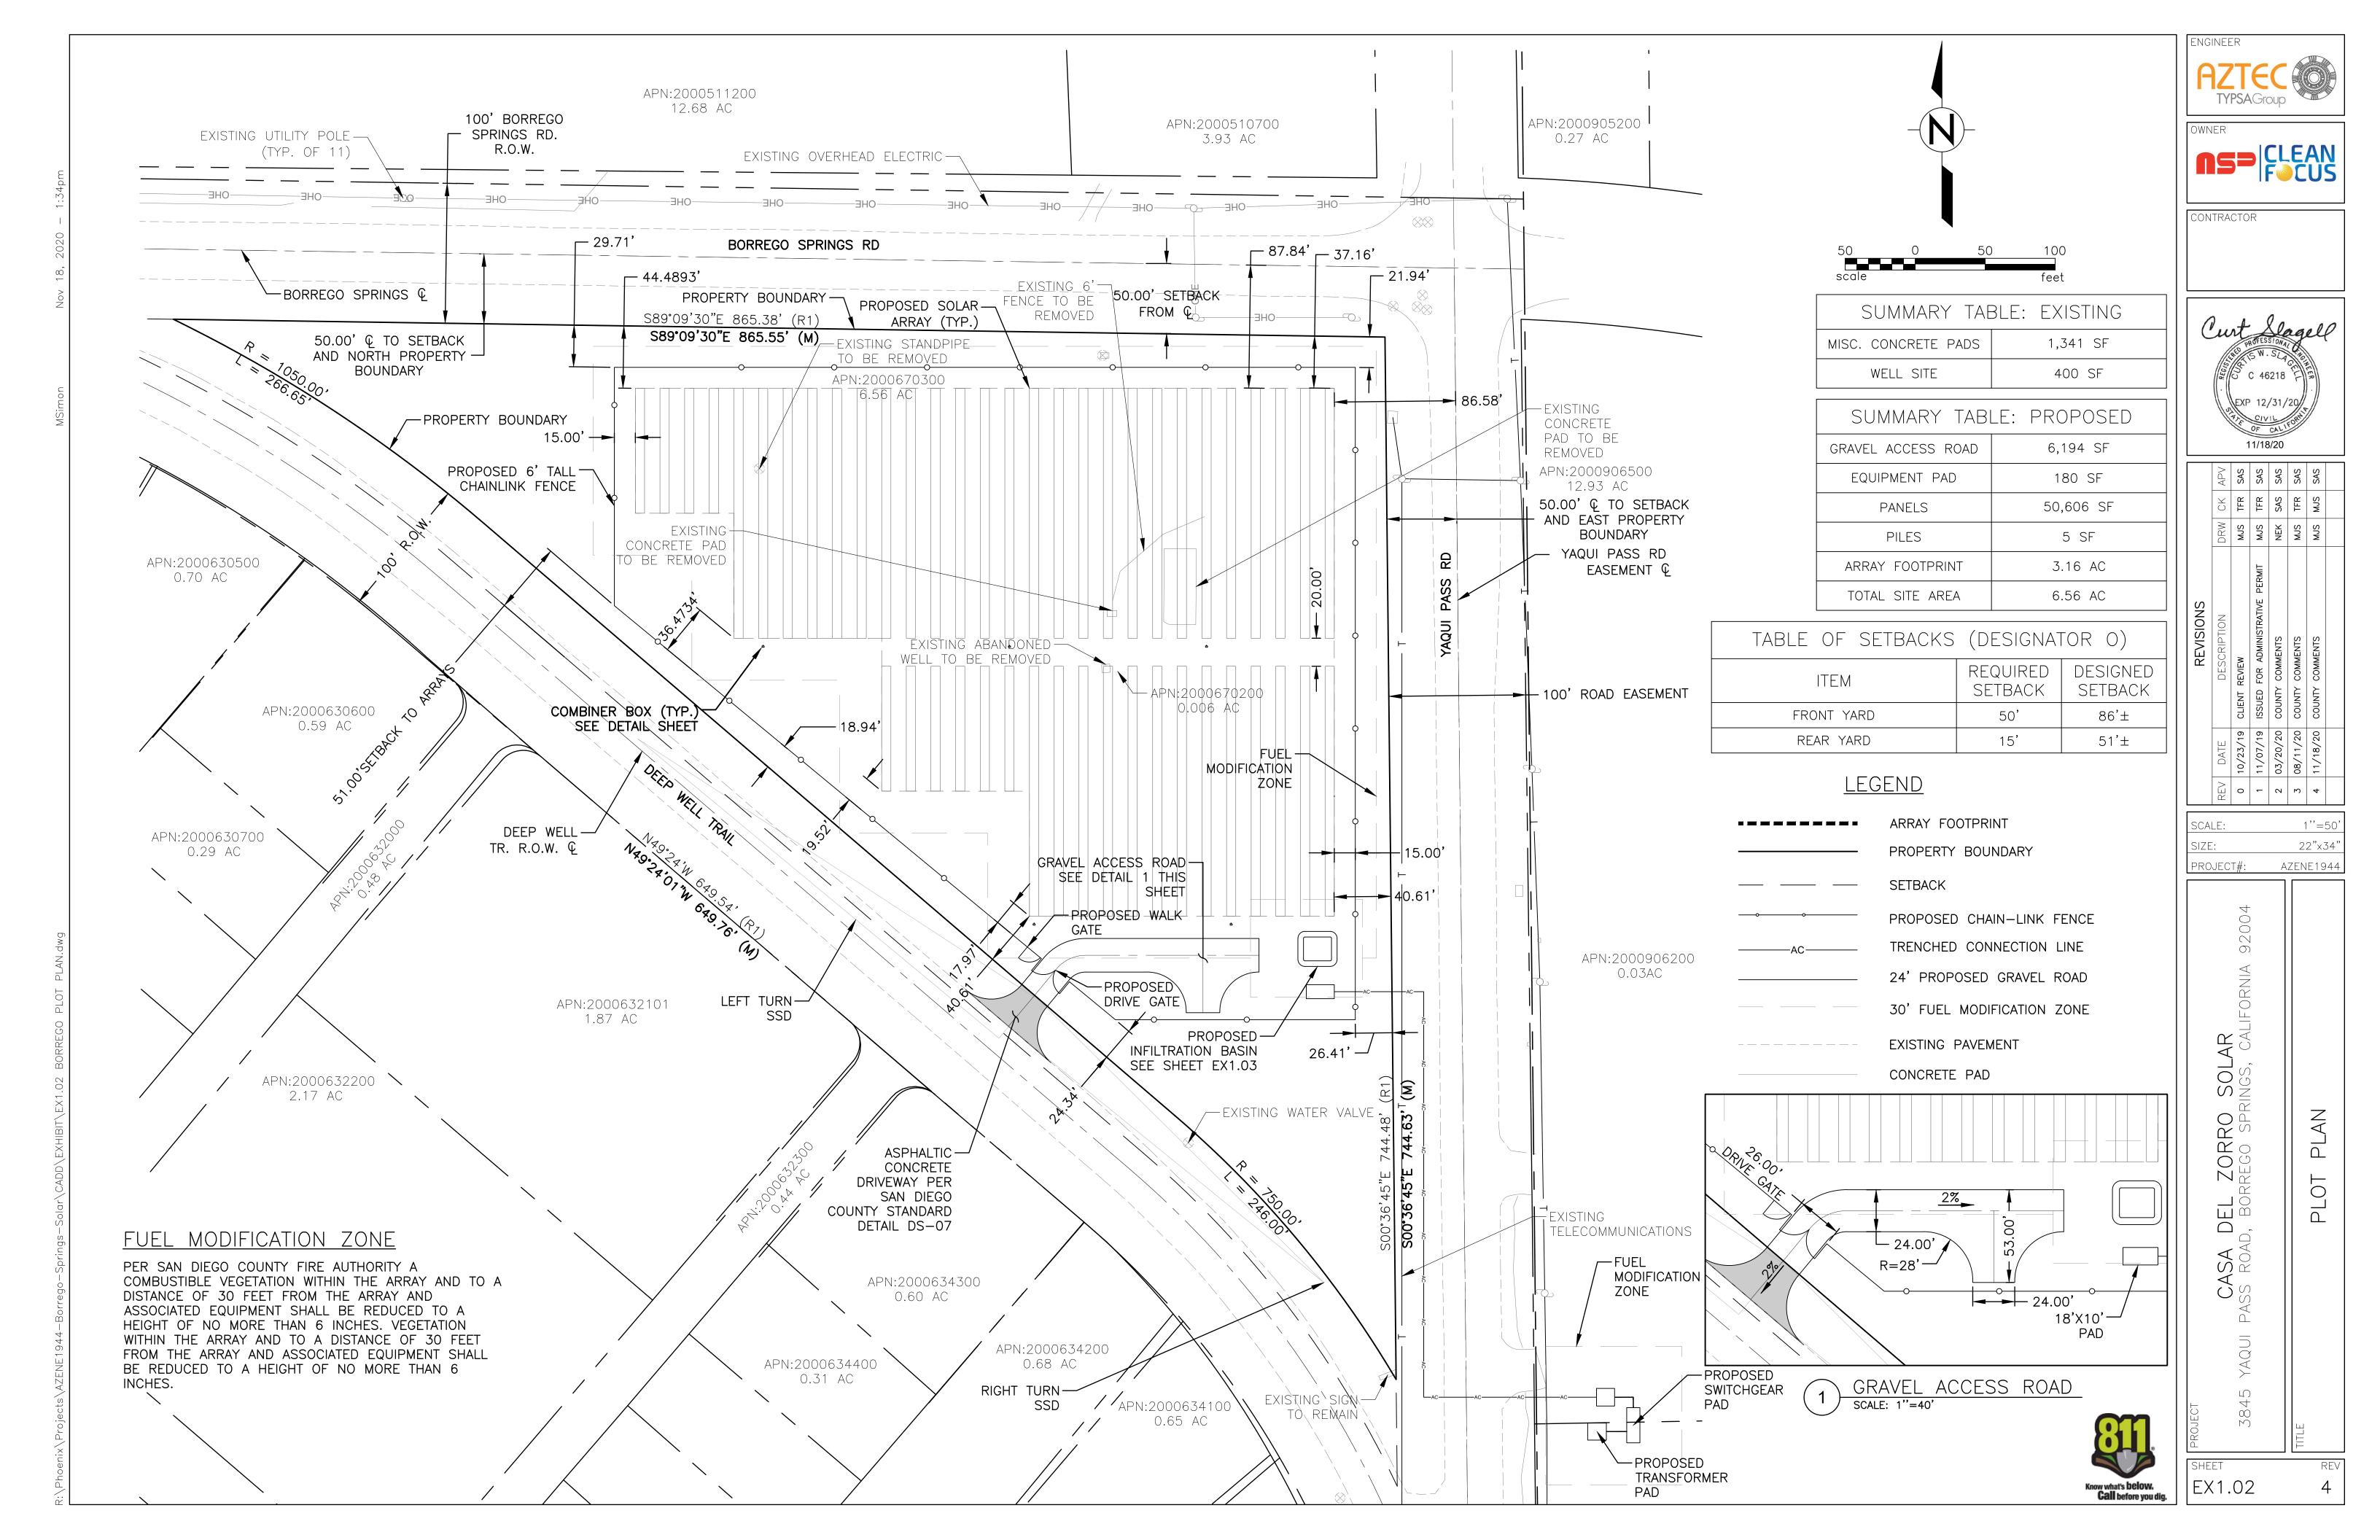


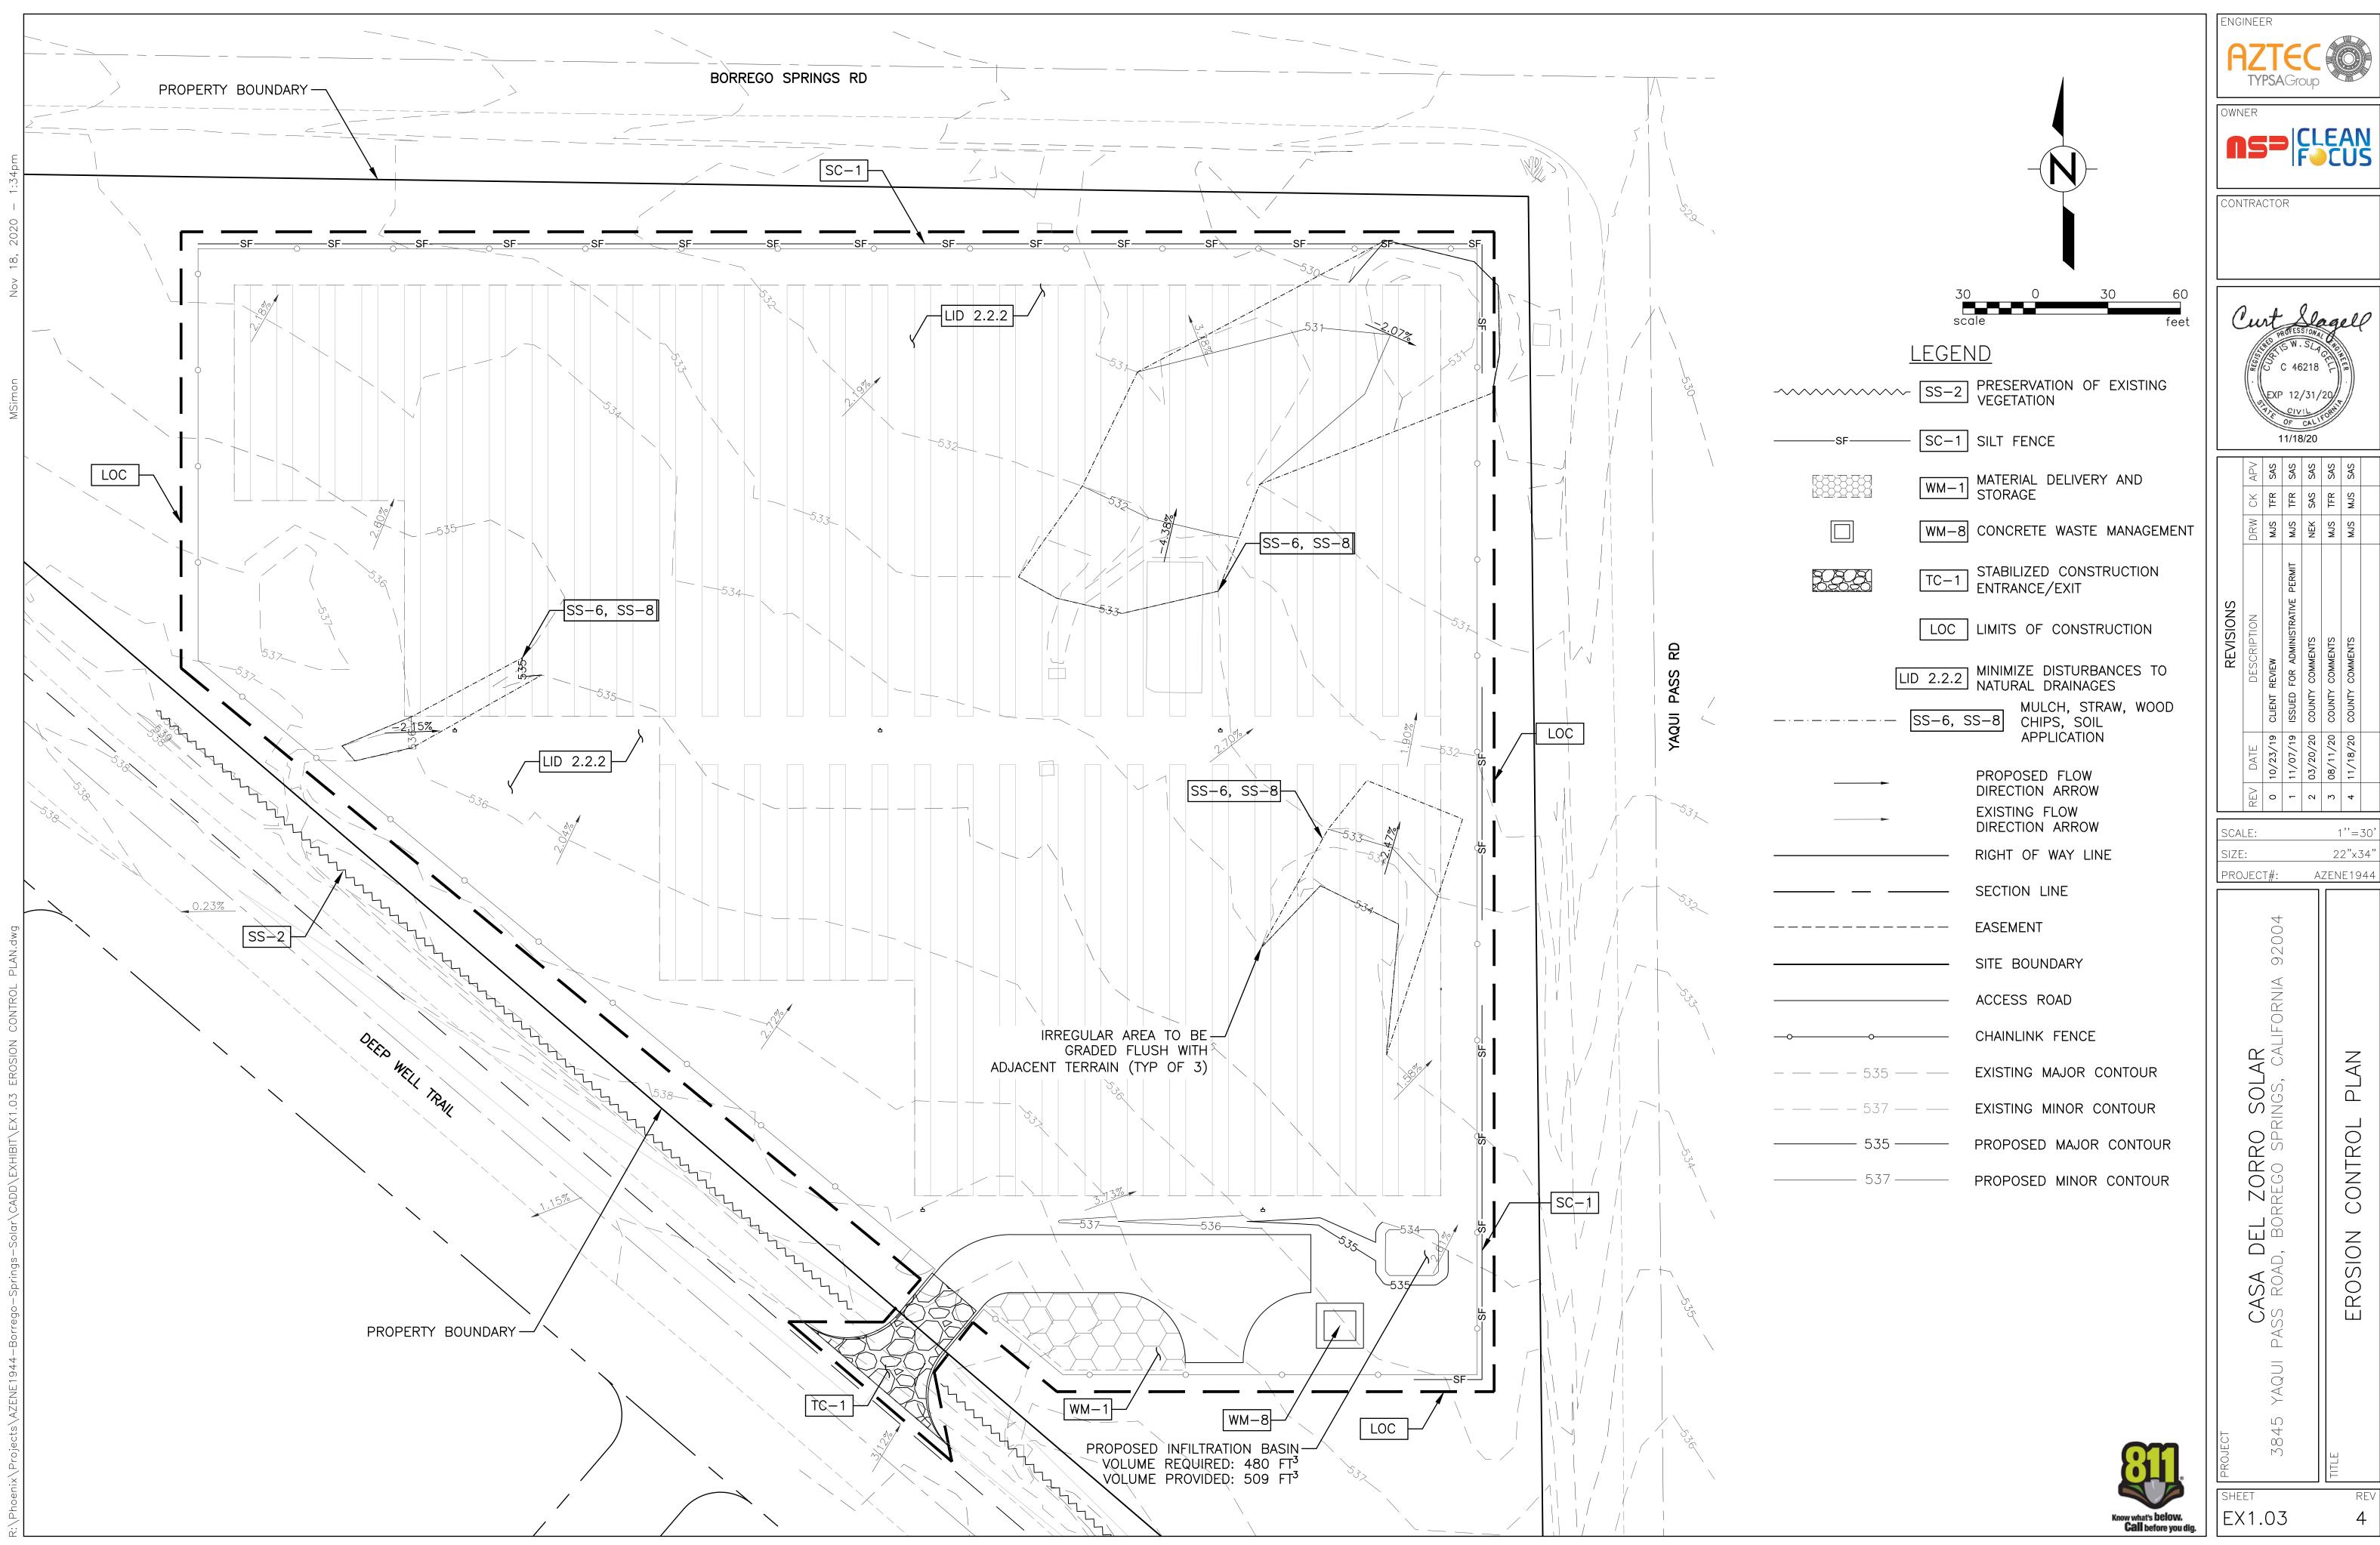


OF CALLEDRA									
	11/18/20								
APV	SAS	SAS	SAS	SAS	SAS				
DRW CK APV	TFR	TFR	SAS	TFR	MJS				
DRW	SCM	MUS	NEK	MJS	MJS				
NOIL		ISTRATIVE PERMIT							


22"x34' AZENE1944

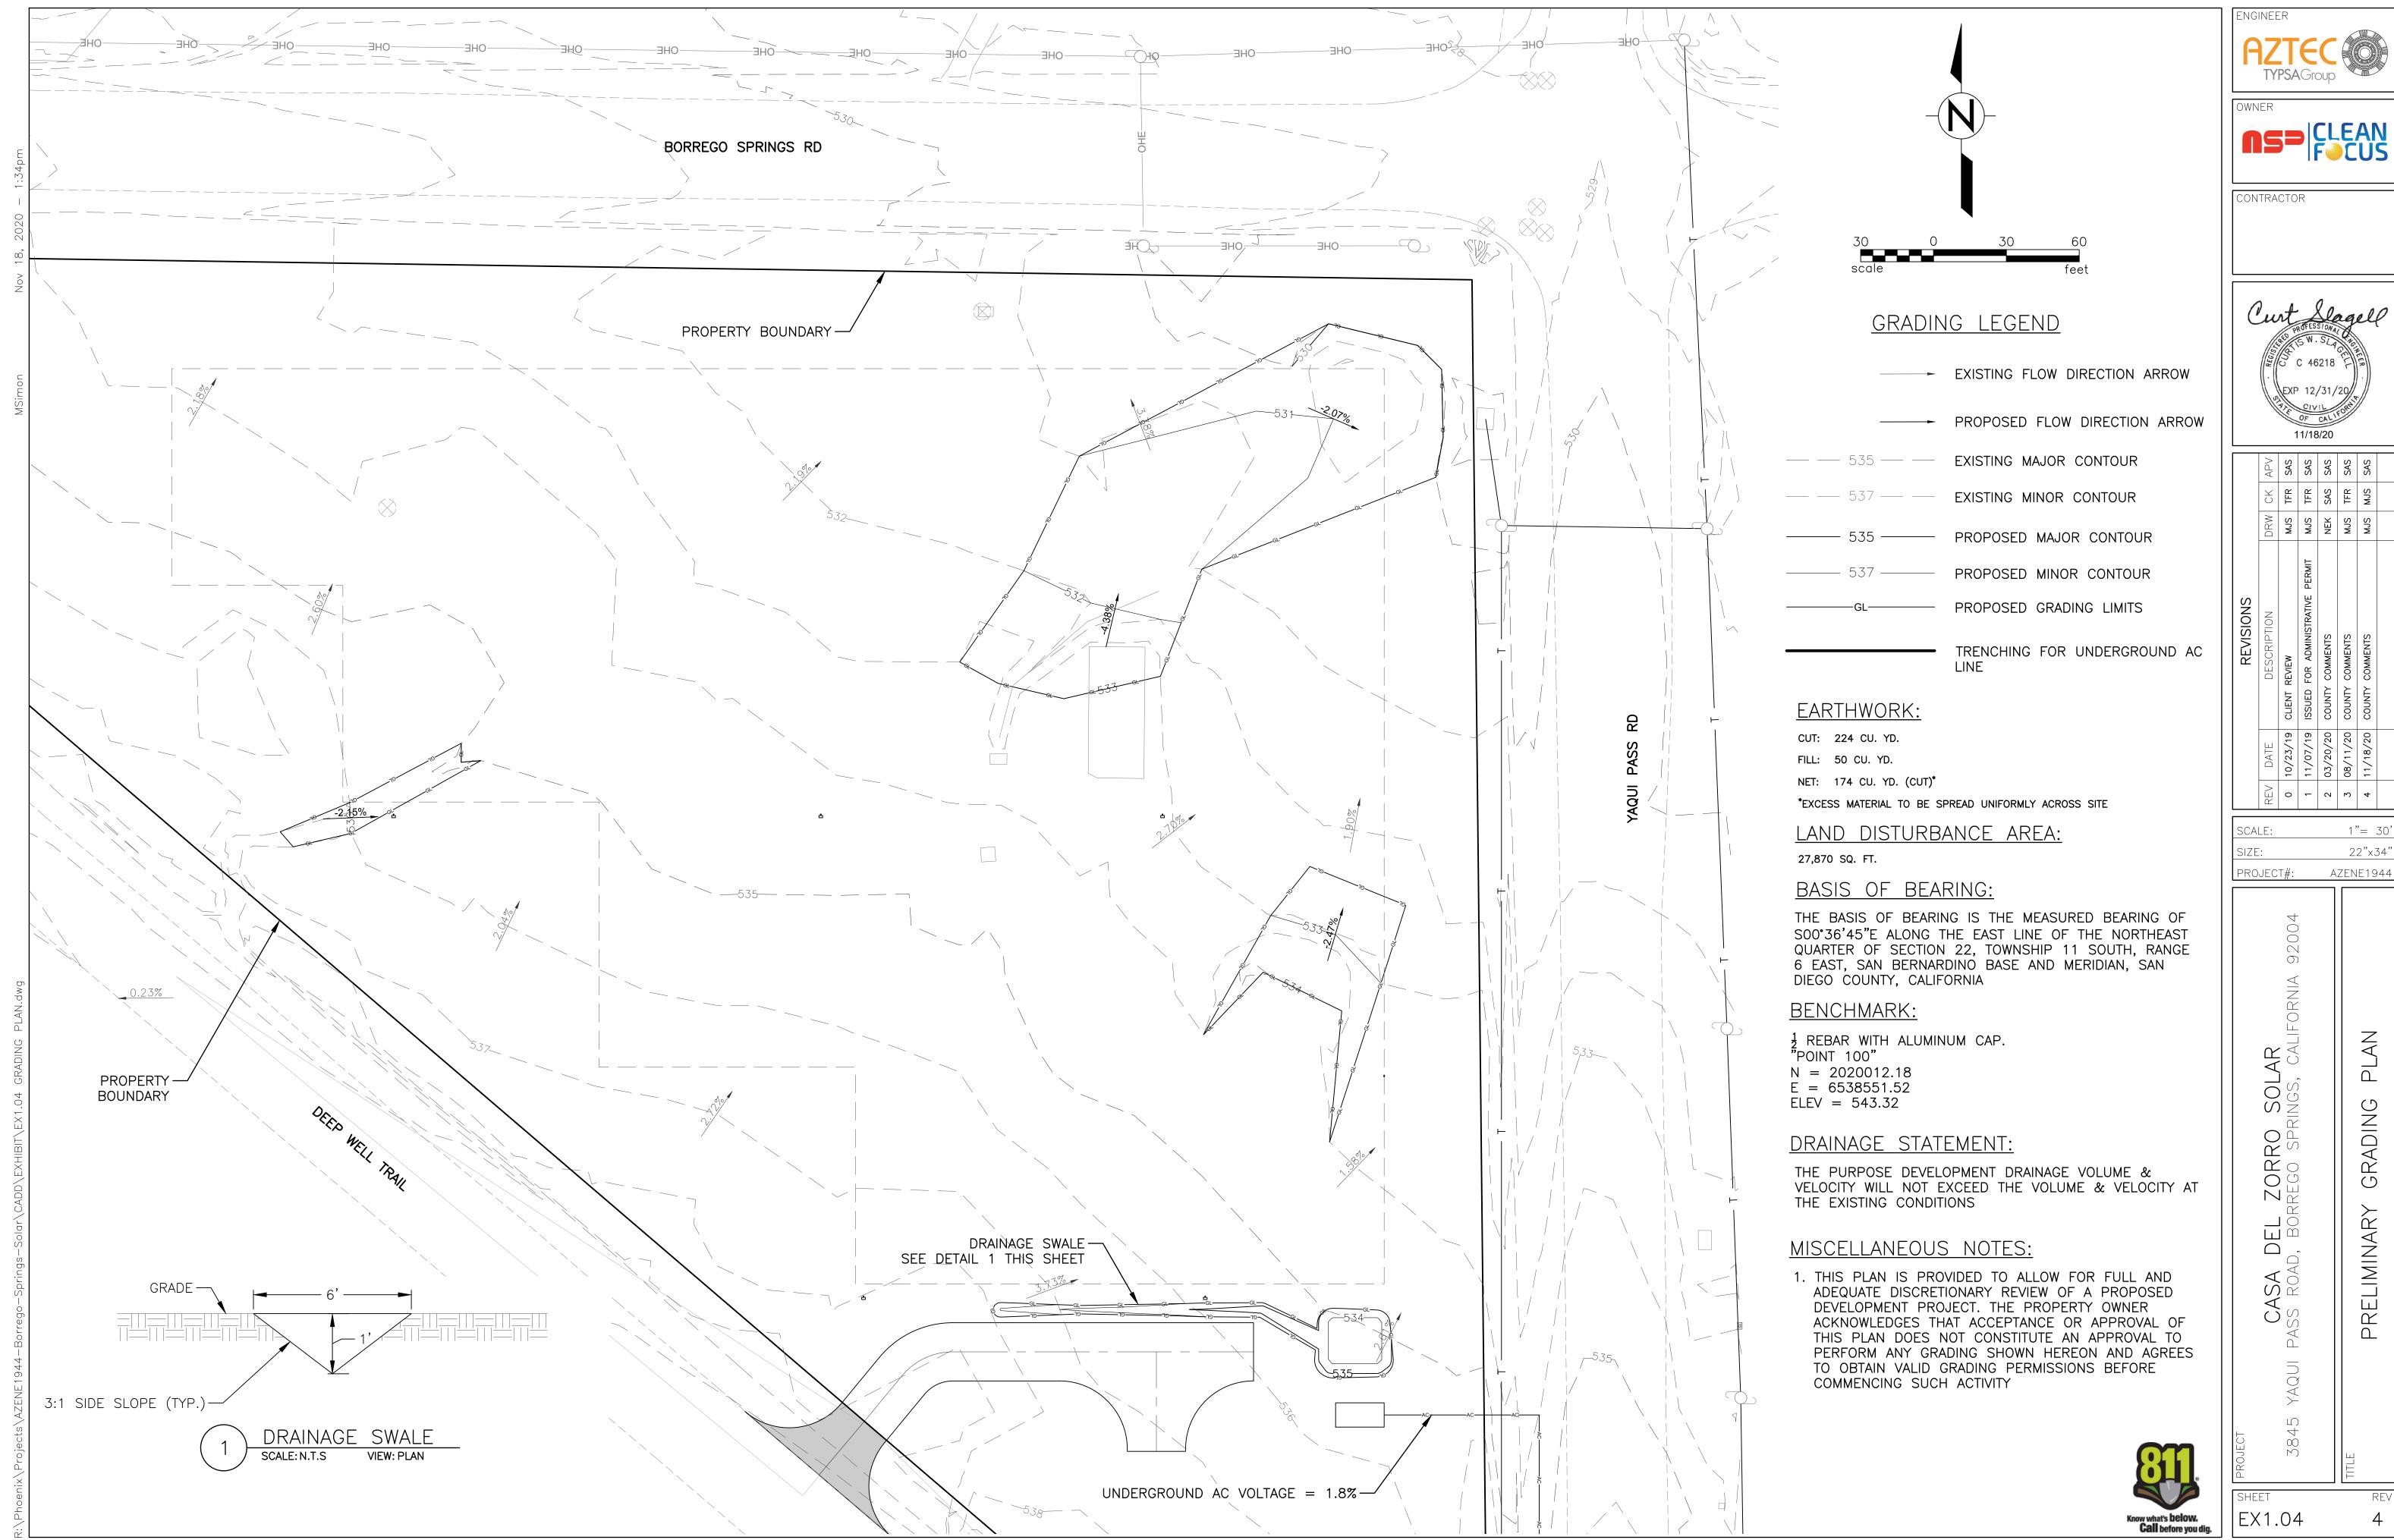

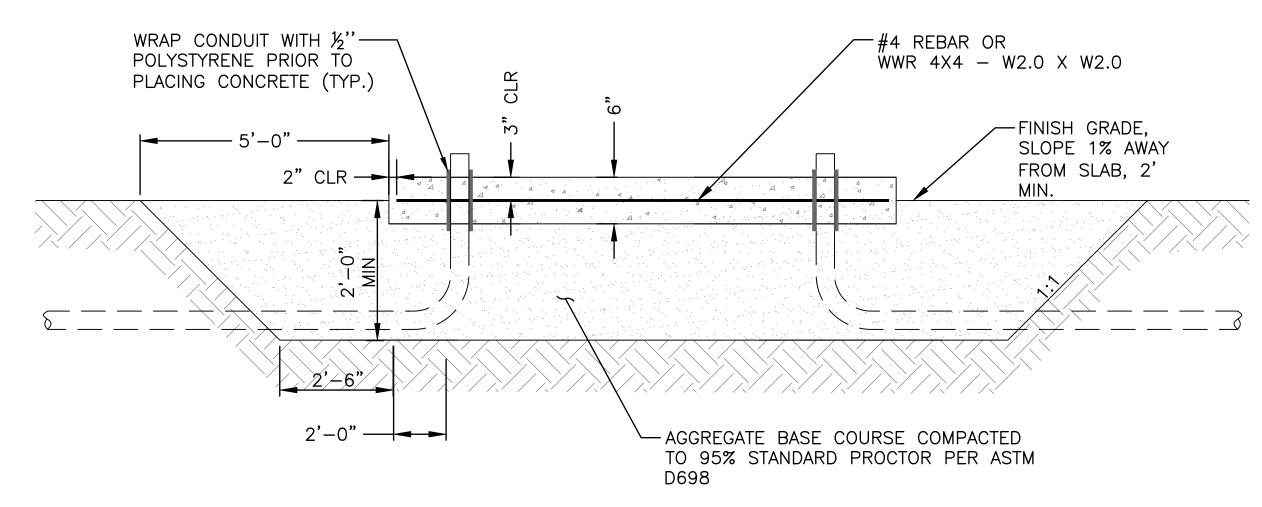

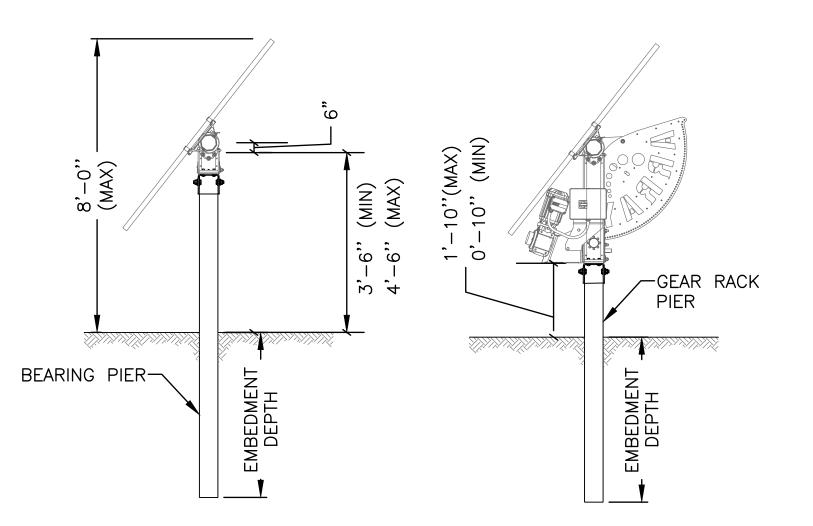


TRACKER FOUNDATIONS

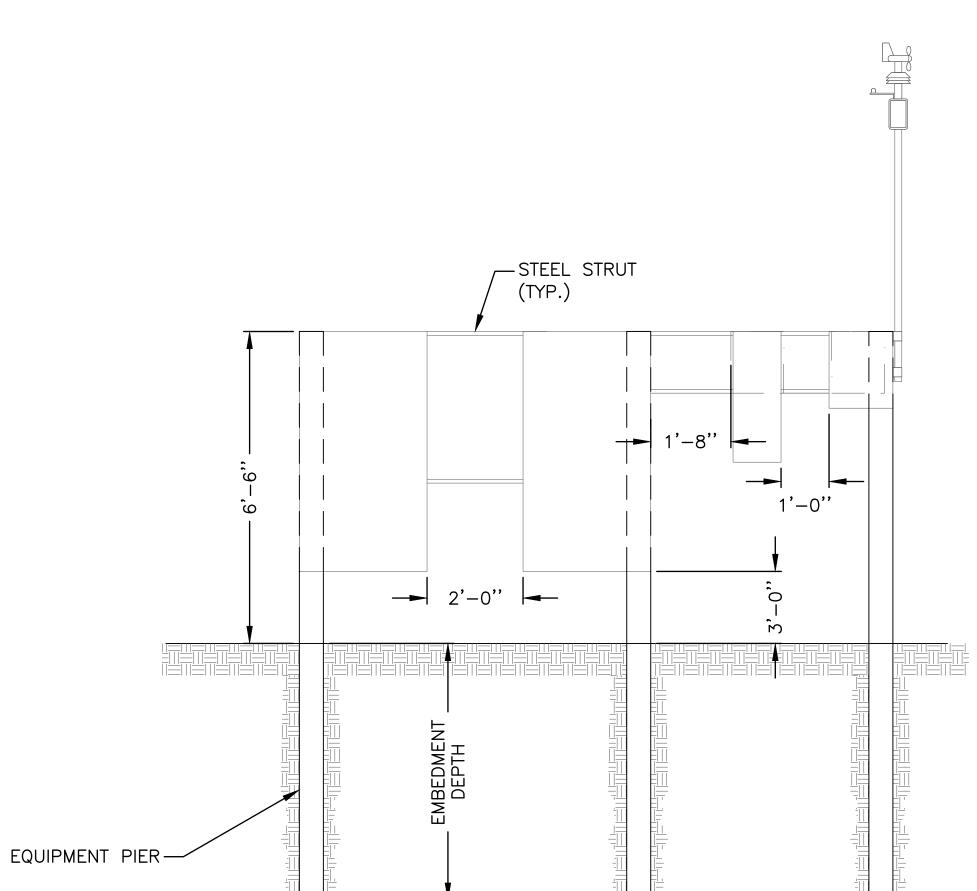

EQUIPMENT PAD FOUNDATIONS

VIEW: SECTION

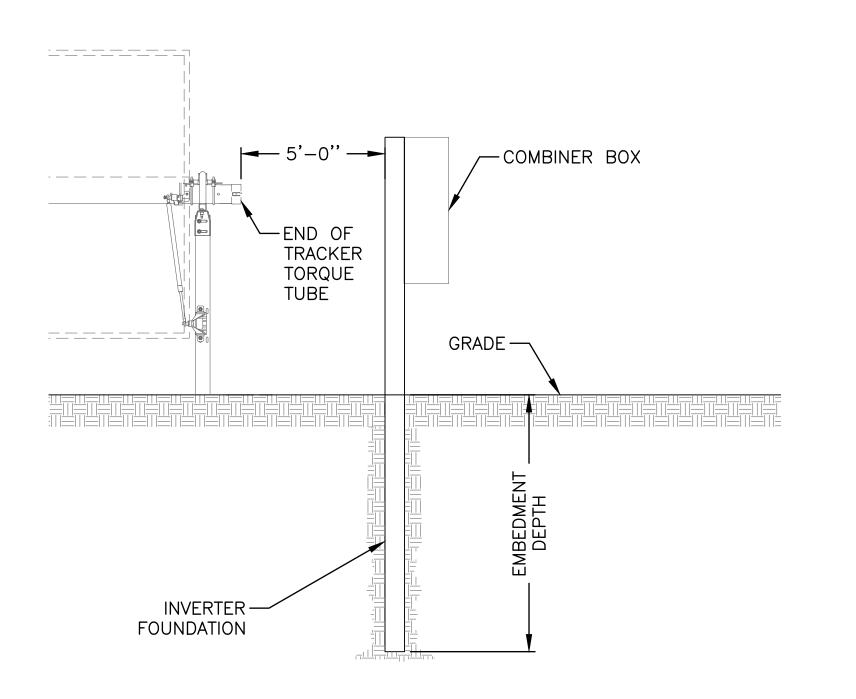

COMBINER BOX FOUNDATION SCALE: N.T.S. **VIEW: SECTION**

NOTES:


- 1. General
- 1.1 These plans include the structural portion of the foundations
- 1.2 The contractor shall verify all existing elevations and dimensions prior to construction.
- 1.3 Details marked "Typical" shall apply in all cases, unless noted
- 1.4 For foundation location and equipment placement, see Civil or Electrical plans under separate cover.
- 2. Design Specifications
- 2.1 San Diego County Adopted Building Code
- 2.2 2015 International Building Code (IBC)
- 2.3 American Concrete Institute (ACI) 318-11
- 2.4 American Institute of Steel Construction 360-10 (AISC)
- 2.5 For soil information, see geotechnical report prepared by ECS Southeast LLC, project number 30-1729dated September 21, 2018.
- 2.6 Design Loads
- 2.6.1 Snow Loads
 - 2.6.1.1 Ground Snow Load, PG = 0 psf
- 2.6.2 Wind Loads
 - 2.6.2.1 3-Second Gust, Vult = 105 mph
 - 2.6.2.2 Risk Category I
 - 2.6.2.3 Exposure Category C
- 2.6.3 Seismic Loads
 - 2.6.3.1 Risk Category I
 - 2.6.3.2 Seismic Importance Factor, IE = 1.00
 - 2.6.3.3 SS = 0.922 g
 - 2.5.3.4 S1 = 0.328 g
 - 2.5.3.5 Site Class D
 - 2.5.3.6 SDS = 0.695 g
 - 2.5.3.7 SD1 = 0.382 g
 - 2.5.3.8 Seismic Design Category D
- 3. Construction Specification
- 3.1 All construction shall conform to the 2015 International Building Code.
- 4. Reinforced Concrete
- 4.1 Cement shall be ASTM C 150 Type I or II, or equivalent. The maximum water cementitious ratio shall be 0.40. The concrete shall have total entrained air of 6%, \pm /- 1.5%. Minimum compression strength shall be 3000 psi at 28 days.
- 4.2 Welded wire reinforcing shall conform to the specifications of ASTM A1064.
- 4.3 Deformed reinforcing bars shall conform to the specifications
- 4.4 All reinforcing steel shall have 2 inch clear cover unless noted otherwise.
- 4.5 Chamfer all exposed corners 3/4 inch unless noted otherwise.
- 4.6 Top surface to have float finish or light broom finish.
- 4.7 Slab Tolerance: max 1/8" in 6' non—cumulative.
- 5. Equipment Anchors
- 5.1 Equipment shall be secured to the concrete pad by means of post—installed anchors. Either adhesive or expansion anchors may be used.
- 5.2 The mounting holes on the equipment frame shall be used as a template to accurately locate the anchors.
- 5.3 The anchors shall be 1/2" diameter nominal (minimum) and shall be embedded in the concrete a minimum of 4 inches. The anchors shall be able to develop a nominal tension capacity of 1000 lbs and a nominal shear capacity of 1000 lbs.
- 5.4 Anchors shall be installed per manufacturer's instructions. Washer plates shall be placed under the anchor head in order to completely cover the mounting hole in the equipment frame if the anchor head cannot completely cover the mounting hole.



AZTEC TYPSAGroup



CONTRACTOR

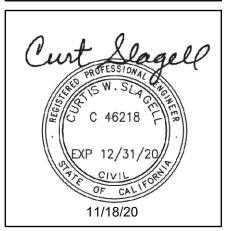

SAS SAS MJS

MJS NEK MJS MJS MJS MJS MJS MJS MJS

	1.1	(19 Cl	,19 SI	,20 c	,20 C	,20 C	
	REV DATE	0 10/23/19	11/07/19	03/20/20	08/11/20 C	4 11/18/20 C	
	REV	0	1	2	3	4	
CAI	_E:			Þ	4S S	SHO	WN
ZE					2:	2"x3	34"
RO	JEC [°]	Τ#:		A	ZEN	E19	44
	CASA DFI ZORRO SOLAR	AQUI PASS ROAD, BORREGO SPRINGS, CALIFORNIA 92004				STRUCTURAL DETAILS	

 \Box

384

EX1.04

EQUIPMENT RACK SCALE: N.T.S. VIEW: SECTION