# LIBERTY CHARTER HIGH SCHOOL

EL CAJON, CA



#### PROJECT DIRECTORY

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#### SHEET INDEX

C-1 PRELIMINARY GRADING PLAN

LANDSCAPE L-1.0 LANDSCAPE CONCEPT PLAN L-2.0 LANDSCAPE DETAILS AND LEGEND

ARCHITECTURAL

SITE LIGHTING SL-1 SITE LIGHTING PLAN

#### ZONE INFORMATION

USE REGULATIONS:	RR
ANIMAL REGULATIONS:	J/Q
LOT SIZE:	0.5 AC
BUILDING TYPE:	С
HEIGHT:	G
SETBACKS:	0/G
OPEN SPACE	-/A
SPECIAL AREA REGULATIONS:	NONE

- REFER TO LANDSCAPE DRAWINGS FOR LOCATION OF ALL LANDSCAPE, IRRIGATION, HARDSCAPE ETC. GENERAL CONTRACTOR SHALL USE LANDSCAPE PLANS FOR BIDDING THESE ITEMS.
- REFER TO CIVIL DRAWINGS FOR CURBS PAVING SITE DRAINAGE CONTROLS ETC.
- REFER TO ELEC. DRAWINGS FOR ALL ON-SITE ELECTRICAL
- ALL KNOWN PROPERTY LINES, EASEMENTS AND BUILDINGS, BOTH EXISTING AND PROPOSED ARE SHOWN ON THIS SITE PLAN.

  YARDS USED FOR AREA INCREASES SHALL BE PERMANENTLY MAINTAINED.
- PROVIDE CONCRETE PAD @ ALL TRASH DUMPSTERS. SEE PLAN FOR LOCATION AND EXTENT
- PROVIDE 4" WIDE WHITE PAINTED (CAL TRANS HIGHWAY ENAMEL) STRIPES @ ALL PARKING. REFERENCE ARCHITECTURAL SITE PLAN FOR HANDICAPPED ACCESS.
- SETBACK FOR P.I.V. AND F.D.C., SHALL BE FOUR FEET FROM CURB AND 3' X 3' CONCRETE PAD POURED AROUND BOTH. SEE CIVIL DRAWINGS.
- ALL DIMENSIONS TO CURBS ARE TO FRONT FACE OF CURB. GENERAL CONTRACTOR SHALL FIELD VERIFY ALL EXISTING SITE CONDITIONS, PROPERTY DIMENSIONS, ETC. PRIOR TO ANY CONSTRUCTION AND SHALL NOTIFY THE ARCHITECT FOR CLARIFICATION OF ANY DISCREPANCIES.
- PRIOR TO THE SIJUANCE OF ANY INSCREPANCIES.

  PRIOR TO THE SIJUANCE OF ANY BUILDING PERMITS, THE APPLICANT SHALL OBTAIN A GRADING PERMIT FROM THE COUNTY OF SAN DIEGO (REFERRED TO AS AN "ENCINEERING PERMIT") FOR THE GRADING PROPOSED FOR THIS PROJECT. ALL GRADING SHALL CONFORM TO THE REQUIREMENTS IN ACCORDANCE WITH THE COUNTY OF SAN DIEGO MUNICIPAL CODE IN A MANNER SATISFACTORY TO THE COUNTY EMPORED.
- THE DRAINAGE SYSTEM PROPOSED WITH THIS DEVELOPMENT IS SUBJECT TO APPROVAL BY THE COUNTY ENGINEER.

# MISC. PLAN CHECK NOTES

- NOTE "STATE HEALTH & SAFETY CODE SEC. 17921.9 BANS THE USE OF CHLORINATED POLYVINY CHLORIDE (CPVC) FOR INTERIOR WATER-SUPPLY PIPING"
- BUILDING SIGNAGE AND MONUMENT SIGNAGE ARE NOT PART OF THIS PROJECT AND WILL BE PROPOSED UNDER A SEPARATE PERMIT, IF ADDED.
- A CONDITION, THIS PROLECT SHALL COMPLY WITH ALL CURRENT STREET LIGHTING STANDARDS ACCORDING TO THE COUNTY OF SAN DIESO MUNICIPAL CODE. THIS MAY REQUIRE (BUT NOT BE LIMITED TO) INSTALLATION OF NEW STREET LIGHTIS), UPGRADING LIGHT FROM LOW PRESSURE TO HIGH PRESSURE SODIUM MAPOR ANDIOR UPGRADING WATTAGE.
- ALL SIGNAGE ASSOCIATED WITH THE PROJECT IS NOT A PART OF THIS APPLICATION AND WILL BE PROPOSED UNDER A SEPARATE PERMIT
- ANY PROPOSED WALL / FENCE (WHICH INCLUDES RETAINING WALLS), SHALL COMPLY WITH THE FENCE REGULATIONS OF THE COUNTY OF SAN DIEGO MUNICIPAL CODE:
- A FIRE ALARM SYSTEM SHALL BE INSTALLED PER NFPA-72 STANDARDS.
- A FIRE SPRINKLER SYSTEM SHALL BE INSTALLED PER NFPA-13 STANDARDS AND SAN MIGUEL CONSOLIDATED FIRE PROTECTION DISTRICT STANDARDS.

# PROJECT DESCRIPTION


PROPOSED CONSTRUCTION OF A NEW CHARTER HIGH SCHOOL, SPORTS FIELD (WITH LIGHT POLES), PARKING LOT (WITH LIGHT POLES), AND ALL SITE IMPROVEMENTS TO SUPPORT. THE BUILDING WILL BE 2-STORY, APPROX. 46,000 SF TOTAL, WITH CAPACITY TO HOUSE APPROX. 33 FACULTY / STAFF AND NO MORE THAN 450 STUDENTS.

\* SEE SITE PLAN SHEET AS 1.0 FOR ADDITIONAL INFORMATION

#### LEGAL DESCRIPTION:

A PORTION OF THE SOUTHEAST QUARTER OF THE NORTHEAST QUARTER OF A PORTION OF THE SOUTHEAST QUARTER OF THE NORTHEAST QUARTER OF SECTION 24, TOWNSHIP 16 SOUTH, RANGE 1 WEST, SAN BERNARDINO MERIDIAN, ACCORDING TO OFFICIAL PLAT THEREOF, AS SHOWN ON RECORD OF SURVEY MAP NO. 21359.

\* APN: 498-330-39-00

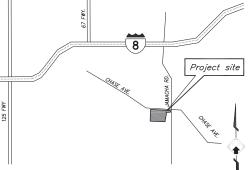




Date Issued	Remarks
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02/08/18	MUP RE-SUBMITTAL

LIBERTY CHARTER - MAJOR USE PERMIT -



COVER SHEET

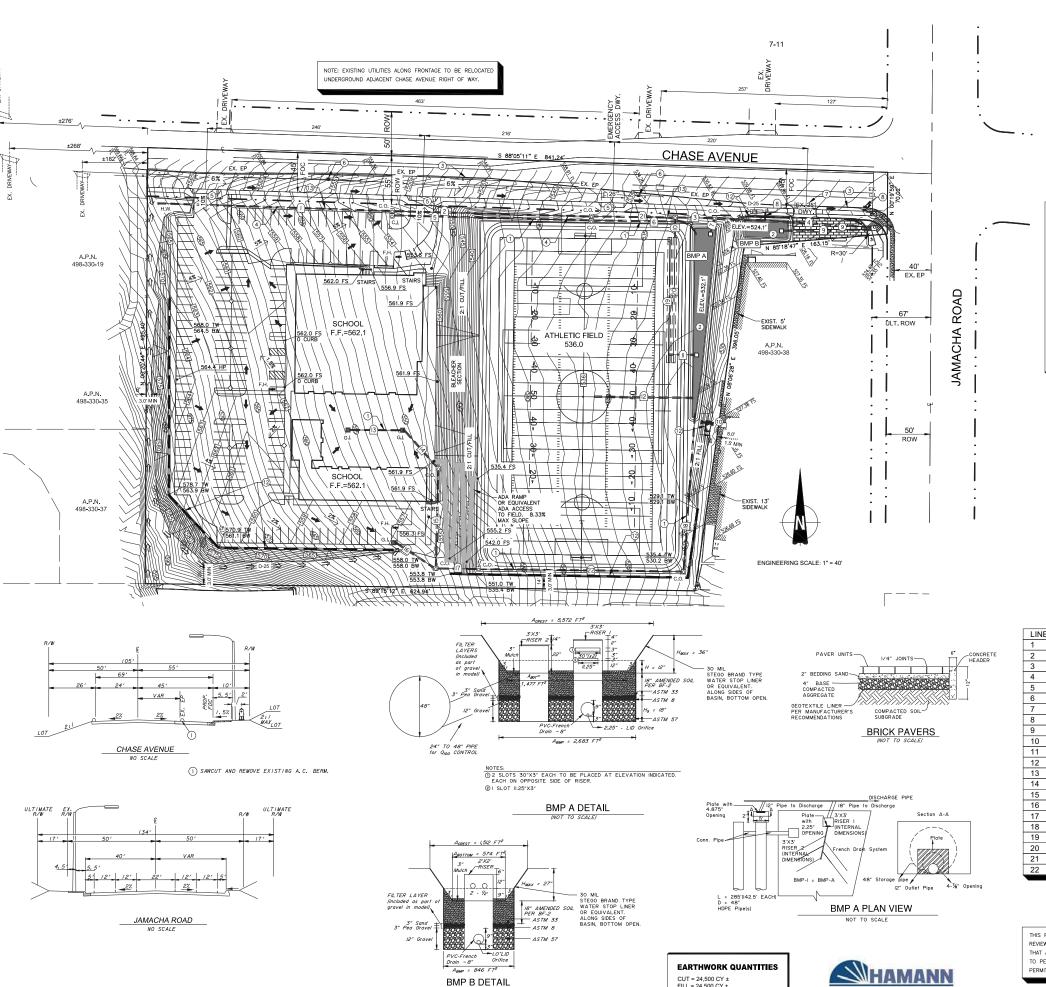

BMP B DETAIL

CUT = 24,500 CY ± FILL = 24,500 CY ±

COMPANIES




EXISTING CONTOUR PROP. CONTOUR

FLOW DIRECTION PROP. C.M.U. WALL

PROPERTY BOUNDARY EXISTING STREET CENTERLINE

RIGHT OF WAY CUT/FILL (2:1)

PERVIOUS PAVERS

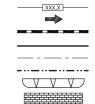

#### NOTES:

- ) HDPE STORM DRAIN.
  ) BIOFILTRATION BASIN. SEE SWQMP AND DRAINAGE STUDY.
- SAWCUT LINE.
- HDPE STORM DRAIN. BYPASS PIPE. 30' TYPE G-14 CONCRETE DRIVEWAY.
- EXISTING POWER POLE. EXISTING UTILITIES TO BE RELOCATED UNDERGROUND ALONG PROPOSED PROJECT FRONTAGE.
- (7) EXISTING DRIVEWAY TO REMAIN
- 8) EXISTING CURB INLET/STORM DRAIN TO BE RELOCATED TO PROPOSED CURB.
- PERVIOUS PAVERS.
   EXISTING FIRE HYDRANT. PROTECT IN PLACE.
   48 INCH HDPE STORAGE PIPES BENEATH FIELD.
- 285 FEET TOTAL LENGTH (142.5 FEET EACH OR EQUIVALENT) SEE DETAIL THIS SHEET.
- PROPOSED RETAINING WALL.
   BYPASS PIPE FOR HYDRAULICALLY SEPARATE OFF-SITE RUN-ON.

#### STRUCTURAL STORM WATER BMPs

# BMP A

BIOFILTRATION BASIN. SEE DETAILS THIS SHEET.

- AREA BOTTOM = 1,477 SF DEPTH = 36 INCHES
- 2 OUTLET RISERS
- CONNECTS TO 2-48 INCH HDPE STORAGE PIPES (FLOW CONTROL)

### BMP B

BIOFILTRATION BASIN. SEE DETAILS THIS SHEET.
- AREA BOTTOM = 574 SF

- DEPTH = 27 INCHES 1 OUTLET RISER

# X STORM DRAIN TABLE

7 OTOTIM BITAIN TABLE				
LINE	BEARING	DISTANCE	REMARKS	
1	N 88°06'05" W	265.28'	30" HDPE	
2	N 88°26'55" W	222.13'	30" HDPE	
3	N 89°15'35" W	40.73'	30" HDPE	
4	N 86°42'11" W	176.09'	30" HDPE	
5	N 88°32'19" W	222.22'	24" HDPE	
6	S 89°16'04" E	126.51'	24" HDPE	
7	N 17°45'54" E	14.86'	18" HDPE	
8	N 01°54'49" E	14.00'	24" HDPE	
9	S 89°11'00" W	100.10'	18" HDPE	
10	N 00°44'25" E	21.76'	12" HDPE	
11	S 89°17'36" E	30.10'	24" HDPE	
12	S 89°16'04" E	112.42'	18" HDPE	
13	S 89°42'06" E	58.35'	18" HDPE	
14	N 41°30'13" W	58.37'	18" HDPE	
15	N 01°26'42" E	111.42'	18" HDPE	
16	S 56°41'15" E	54.42'	24" HDPE	
17	S 89°17'12" E	44.58'	30" HDPE	
18	S 04°10'09" W	178.75'	30" HDPE	
19	N 00°42'24" E	142.50'	48" HDPE	
20	S 00°42'24" W	142.50'	48" HDPE	
21	S 89°15'35" E	91.02'	30" HDPE	
22	N 89°16'25" W	229.00'	30" HDPE	

THIS PLAN IS PROVIDED TO ALLOW FOR FULL AND ADEQUATE DISCRETIONARY REVIEW OF A PROPOSED DEVELOPMENT PROJECT. THE PROPERTY OWNER ACKNOWLEDGE: THAT ACCEPTANCE OR APPROVAL OF THIS PLAN DOES NOT CONSTITUTE AN APPROVAL TO PERFORM ANY GRADING SHOWN HEREON, AND AGREES TO OBTAIN A VALID GRADING PERMIT BEFORE COMMENCING SUCH ACTIVITY.

**NOT FOR CONSTRUCTION** 



KARK


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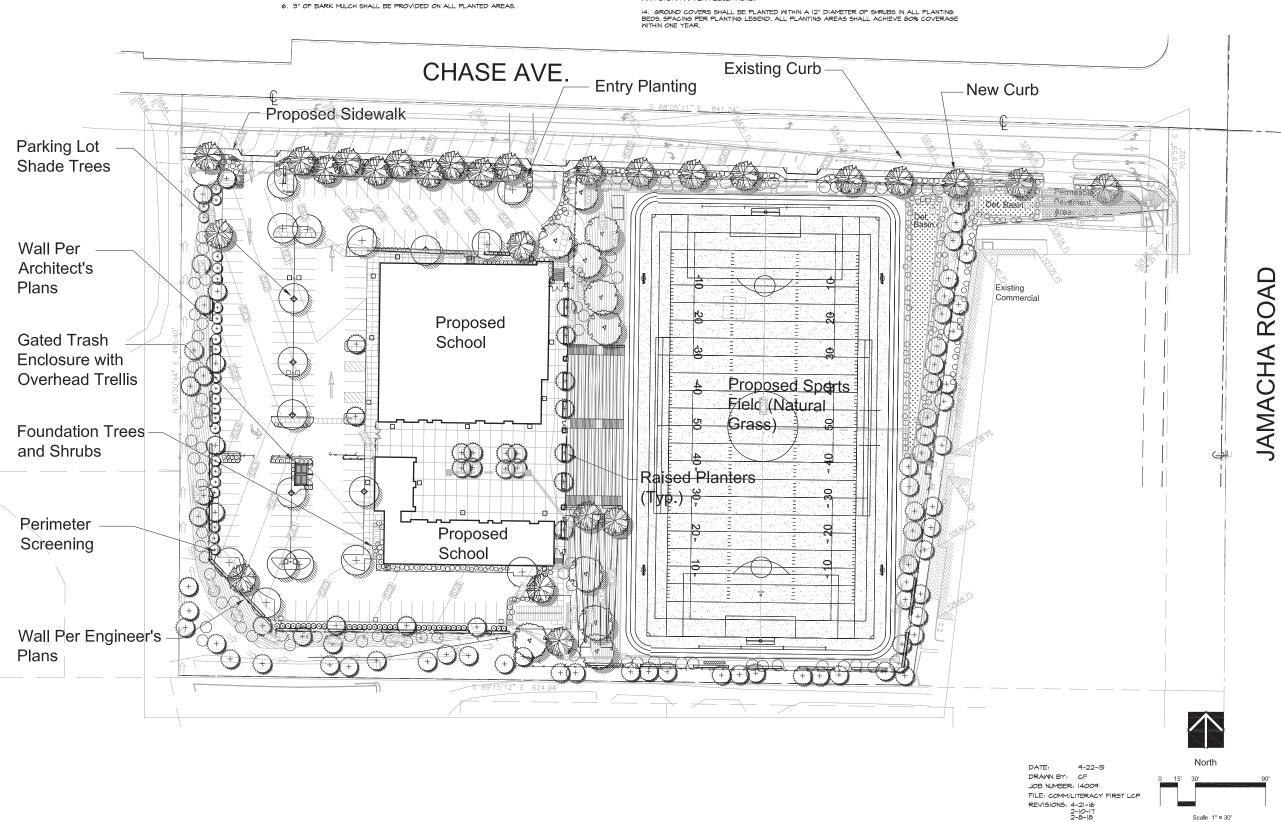
LIBERTY CHARTER - MAJOR USE PERMIT -



PRELIMINARY GRADING PLAN



- 7. ALL PLANTINGS SHALL BE MAINTAINED IN A HEALTHY AND THRIVING AND RELATIVELY WEED FREE CONDITION.
- 6. PLANTS HAVE BEEN CHOSEN FROM THE SAN DIEGO COUNTY LANDSCAPE ORDINANCE AND WATER EFFICIENT LANDSCAPE DESIGN MANUAL.
- 9. PLANTS USED DO NOT APPEAR ON THE "UNDESIREABLE PLANTS" LIST MAINTAINED BY THE COUNTY OF SAN DIEGO DEPARTMENT OF PLANNING AND LAND USE AS PART OF THE DECOMMENDATIONS OF DIFFERSILE ESPACE.
- IO. PLANTING AND IRRIGATION PLANS SHALL COMPLY WITH THE COUNTY OF SAN DIEGO WATER CONSERVATION STANDARDS SET FORTH IN THE LANDSCAPE ORDINANCE AND WATER EFFICIENT LANDSCAPE DESIGN MANUAL.
- II. ON-GOING MAINTENANCE, INCLUDING THAT IN THE AREAS OF THE RIGHT-OF-WAY SHALL BE THE RESPONSIBILITY OF THE OWNER.
- 2 STREET TREES WILL BE PLANTED IN THE PUBLIC RIGHT OF WAY
- 13. ALL PLANTING AREAS SHALL CONTAIN TREES, SHRUBS OR GROUND COVERS AND BARK MULCH AS SPECIFIED IN NOTE #6. BARE SOIL SHALL BE PROTECTED FROM EROSION, AND COMPLIANT WITH STORM WATER BREAL BATIONS.

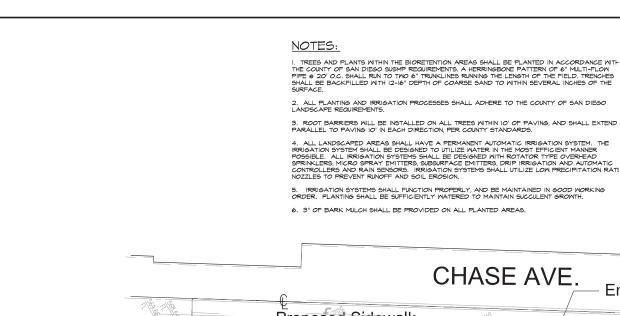

ARCHITECTURE / PLANNING / INTERIORS 11750 SORRENTO VALLEY RO STE 100 SAN DEGO CA 92721 WWW. PACCOGNERS TONE COM





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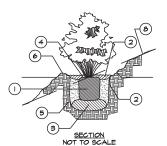
Proposed Project:
LIBERTY CHARTER
HIGH SCHOOL
- MAJOR USE PERMIT -



PCA Project No. **15-**Sheet Title:

Sheet Title: LANDSCAPE CONCEPT PLAN

L1.0



NOTE: ALSO SEE TREE STAKING DETAIL

TREE OR SHRUB ROOTBALL


(2) DIG HOLE 2X WIDTH AND PEPTH OF ROOTBALL AND FILL WITH WATER AND ALLOW TO PERCOLATE INTO SUBSOIL.

- 3 FILL HOLE WITH 6" DEPTH NATIVE BACKFILL MATERIAL. TAMP AND MOUND SLIGHTLY.
- (4) SET ROOT BALL IN HOLE SO THAT ROOT CROWN IS I" ABOVE FINISH GRADE.
- (5) REPLACE BACKFILL MATERIAL (PER SPECIFICATIONS) UP TO 2/3 THE HEIGHT OF THE ROOT BALL, TAMPING AND SETTLING AROUND REMAINING 1/3 OF ROOT BALL.
- 6 CREATE IRRIGATION BASIN A MINIMUM OF 6" BEYOND SIDES OF ROOT BALL.
- 7 IRRIGATE FROM TOP TO SETTLE BACKFILL AND BERM, FILLING BASIN.
- 8 FINISH GRADE



Tree / Shrub Planting

NOT TO SCALE

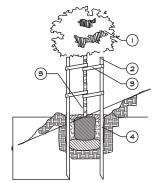

TREE PLANTED PER DETAIL

2) STAKE BELOW CROWN OF TREE


3 CORDED RUBBER TREE TIE - 2 PER STAKE. SECURE MITH 16d GALVANIZED NAIL

4 2" DIAMETER X IO' LONG LODGEPOLE PINE STAKE (2 TOTAL)

NOTE: ALSO SEE TREE/SHRUB PLANTING DETAIL

Tree Staking

NOT TO SCALE

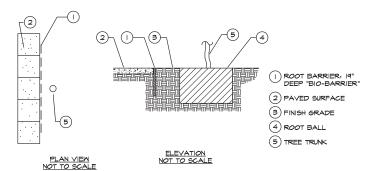

Root Barrier

NOT TO SCALE

# PLANT LEGEND

	SYMBOL	BOTANICAL NAME	COM	MON NAME	SIZE	
	yerry.					
	<b>(X)</b>	TREES SUCH AS:				
	- Allendary	CHILOPSIS LINEARIS	DESE	RT MILLOW	24" BOX	
( +	- )	CERCIS OCCIDENTALIS	WEST	TERN REDBUD	24" BOX	
1	The said	LOPHOSTEMON CONFERTA	BRIS	BANE BOX	24" BOX	
	{ · }	OLEA EUROPAEA	SWA	N HILL' OLIVE	24" BOX	
W.	The second					
	<b>A</b>	QUERCUS AGRIFOLIA	COA	ST LIVE OAK	24" BOX	
All		LARGE SHRUBS (6' TALL AND UP) S	SUCH A	<u>s.</u>		
	juuq	ARBUTUS UNEDO	STRA	MBERRY TREE	5 GALLON	
	_{+ <i>}</i> }	HETEROMELES ARBUTIFOLIA	TOYO	N	I5 GALLON	
		PHOTINIA FRASERI	CHINE	SE PHOTINIA	5 GALLON	
	$\cup$	MEDIUM SHRUBS (4' TO 6' TALL AN	D (IP) (	AICH AG.		
			0,7,	<del>2011 / 10.</del>		
		CARPENTERIA CALIFORNICA		ANENOME	I5 GALLON	
	$O_{\odot}$	CISTUS PURPUREA		D ROCKROSE	I GALLON	
	್ರ	COLEONEMA PULCHRUM LANTANA 'DWARF PINK'		BREATH OF HEAVEN	5 GALLON	
	0		LANTA	ENLY BAMBOO	I GALLON	
	$\sim$ $\sim$			D FERN	I GALLON I GALLON	
(	1)	PITTOSPORUM TOBIRA	TOBIE	- · <del>-</del> · · ·	5 GALLON	
>	$\preceq$ $\odot$	RHAPHIOLEPIS I. 'BALLERINA'		HAWTHORN	5 GALLON	
	, 100			HAWTHORN	5 GALLON	
	'ノ(・)	ROMNEYA COULTERI	MATIL	IILA POPPY	5 GALLON	
		SMALL SHRUBS (3' TALL AND LOWER) SUCH AS:				
	$\bigcirc$	HELIANTHEMUM NUMMULARIUM	SUNRO	95E	I GALLON	
	ŏ	HEMEROCALLIS 'YELLOM'	DAY!	LILY	I GALLON	
	0	MONARDELLA VILLOSA	COYC	OTE MINT	2" LINERS	
	$\circ$	OENOTHERA CALIFORNICA	CALIF	EVENING PRIMROSE	2" LINERS	
	0	PENSTEMON H. 'MARGARITA BOP'	FOOT	HILL PENSTEMON	2" LINERS	
		SALVIA GREGGII	AUTUN	√N SAGE	I GALLON	
	O	TRACHELOSPERMUM JASMINOIDES	STAR	JASMINE	I GALLON	
		GROUND COVERS SUCH AS:				
	z	TRACHELOSPERMUM JASMINIODES		STAR JASMINE	FLTS @ 24" 00	5.
	0 <u>0</u> ×	MYOPORUM PARVIFOLIUM PUTAH CI	REEK'	PROSTRATE MYOPORUM	FLTS. @ 18" OC	5.
	z ± o	BACCHARIS PILULARIS		COYOTE BRUSH	FLTS. ⊚ 18" OC	5.
	* + AGROSTIS PALENS (FOR SIDES OF BASIN) THINGRASS (BMP   \$ 2)			FLTS. ⊗ 18" OC	5.	
	+ + +	MUHLENBERGIA RIGENS(BOTTOM OF			FLTS. ⊕ 18" OC	
	4	MARATHON III		DWARF FESCUE	BY SOD	







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LIBERTY CHARTER HIGH SCHOOL - MAJOR USE PERMIT -





PCA Project No. 15-135

LANDSCAPE DETAILS AND LEGEND

L2.0

DATE: 9-21-15 DRAWN BY: CF JOB NUMBER: 14009 FILE: COMM/LITERACY FIRST LCP REVISIONS:

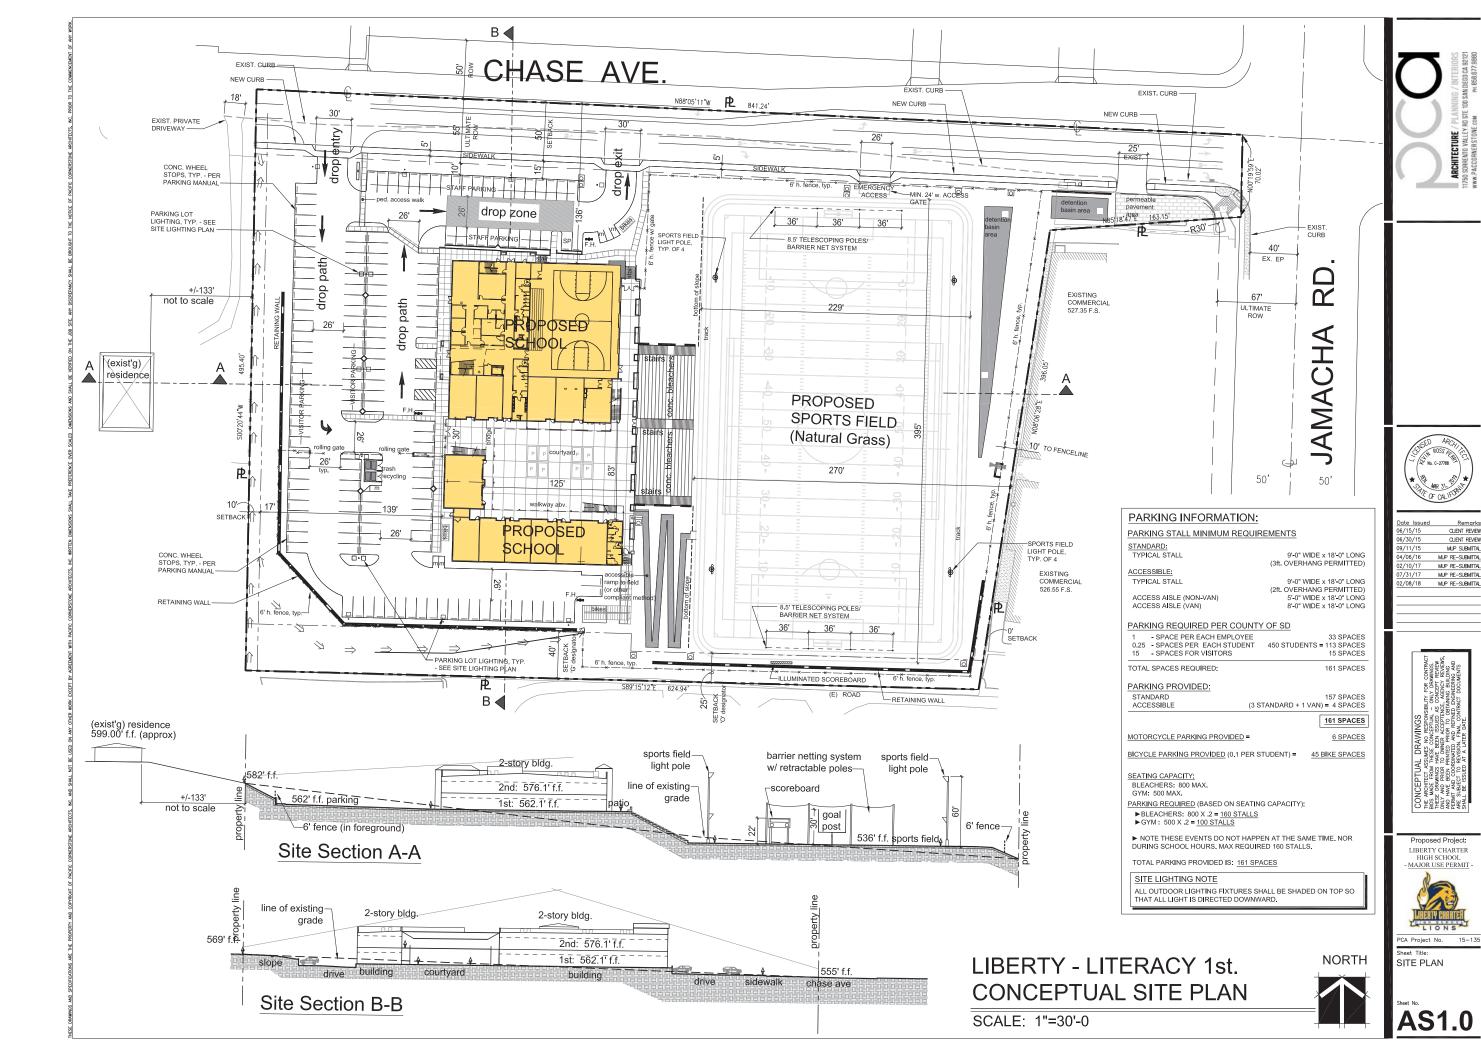

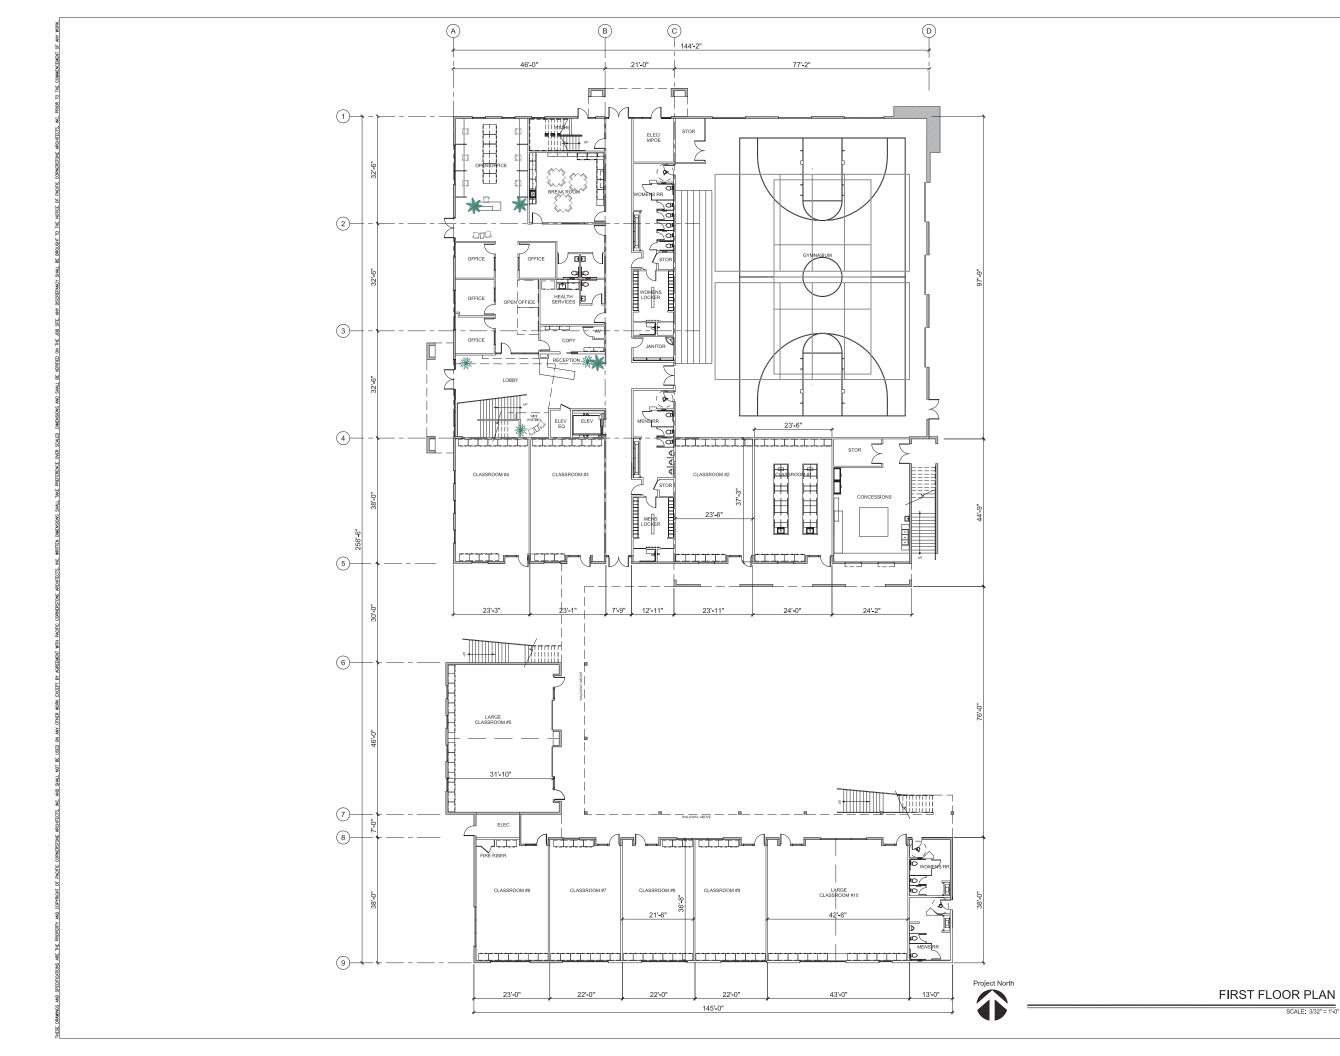





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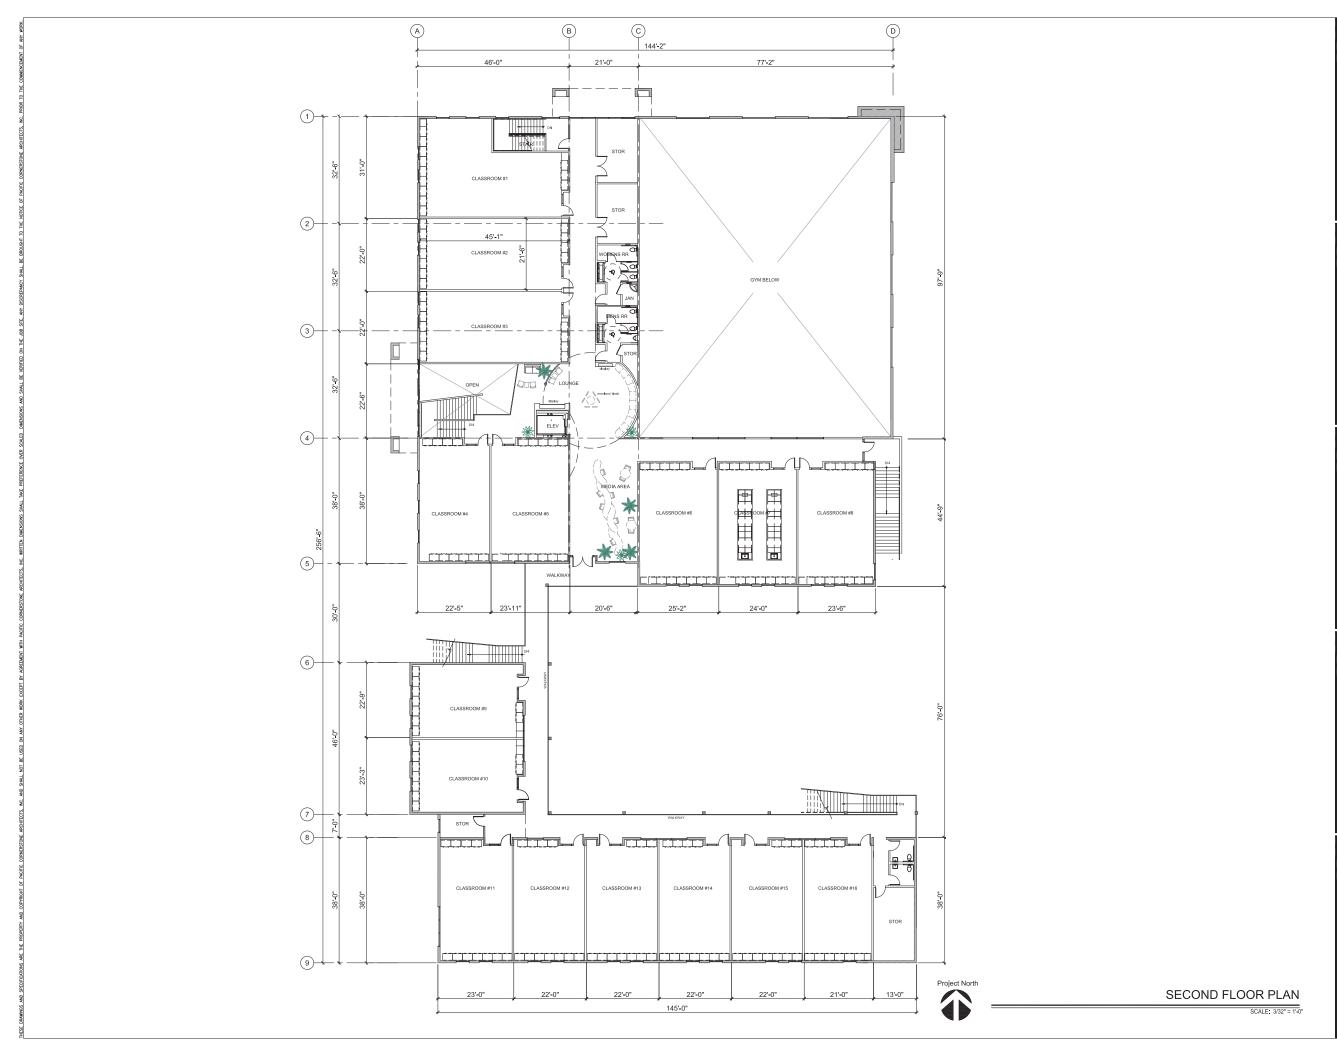


Proposed Project: LIBERTY CHARTER HIGH SCHOOL - MAJOR USE PERMIT -



PCA Project No. 15–13.
Sheet Title:
FIRST FLOOR
PLAN

Sheet No. **A1.0** 







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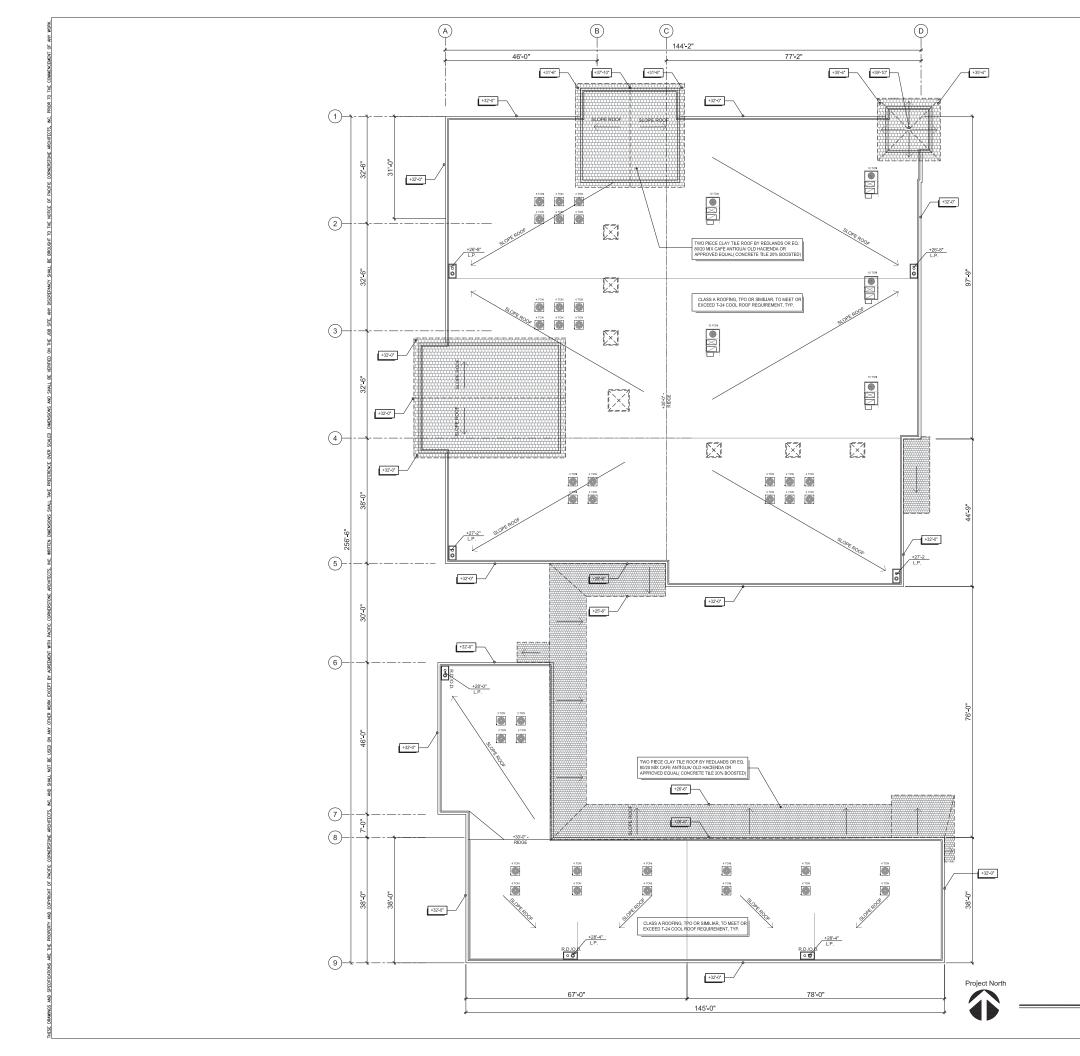


Proposed Project: LIBERTY CHARTER HIGH SCHOOL - MAJOR USE PERMIT -



Sheet Title: SECOND FLOOR PLAN

A2.0







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Proposed Project: LIBERTY CHARTER HIGH SCHOOL - MAJOR USE PERMIT -



PCA Project No. 15–135
Sheet Title:
ROOF PLAN

A3.0

ROOF PLAN



EXTERIOR ELEVATIONS

SCALE: 3/32" = 1'-0"

4) 7)

2 16

(D) NORTH ELEVATION

③ DUAL GLAZED - WINDOW SYSTEM W/ ACCENT MULLIONS

(4) DUAL GLAZED - STOREFRONT WINDOW/ DOOR SYSTEM

(5) METAL AND CONCRETE STAIR w/ STEEL SUPPORTS AND DECORATIVE TILE

SITE KEY MAP



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CONCEPTUAL

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Proposed Project: LIBERTY CHARTER



PCA Project No. 15-135

A4.0

NORTH

HIGH SCHOOL - MAJOR USE PERMIT -

EXTERIOR ELEVATIONS



#### ELEVATION LEGEND

- ① CONCRETE WALL PANEL COLOR 1
- ② CONCRETE WALL PANEL COLOR 2
- ③ DUAL GLAZED WINDOW SYSTEM W/ ACCENT MULLIONS
- DUAL GLAZED STOREFRONT WINDOW/ DOOR SYSTEM
- METAL AND CONCRETE STAIR w/ STEEL SUPPORTS AND DECORATIVE TILE
- 6 STEEL GATE
- 7 DECORATIVE TILES
- CANOPY FEATURE

- GLASS AND ALUMINUM FIREHOUSE DOORS
   LOGO / SIGNAGE w/ ACCENT LIGHTING
   METAL RAILING AND SUPPORT POSTS
   ELDORADO STONE CAPISTRANO ADOBE
- (13) CHAMFERED EDGE
- (4) HEAVY TIMBER RAFTERS
- (3) TWO PIECE CLAY TILE ROOF BY REDLANDS OR EQ. 80/20 MIX CAFE ANTIGUA/ OLD HACIENDA OR APPROVED EQUAL( CONCRETE TILE 20% BOOSTED)


  (3) ORNAMENTAL TRELLIS







G NORTH ELEVATION: COURTYARD

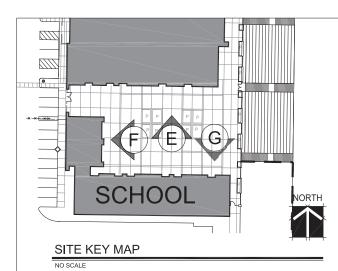

**EXTERIOR ELEVATIONS: COURTYARD** 

SCALE: 3/32" = 1'-0"



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Proposed Project: LIBERTY CHARTER HIGH SCHOOL - MAJOR USE PERMIT -



PCA Project No. 15-135 Sheet Title: EXTERIOR ELEVATIONS: COURTYARD

Sheet No.



COURTYARD VIEW - LOOKING WEST





BUILDING ENTRY FROM PARKING LOT - LOOKING EAST note: landscape not shown for building clarity, see landscape plan for additional info



COURTYARD VIEW FROM 2ND FLOOR - LOOKING EAST



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PCA Project No. 15-13

Sheet Title: CONCEPTUAL PROJECT PERSPECTIVES







OVERALL AERIAL PERSPECTIVE - LOOKING NORTH-EAST note: landscape not shown for building darity, see landscape plan for additional info

