±0.46 MILES _±0.43 MILES ~ BRADLEY **AVENUE** PROJEC SITE TE GYJDN VICINITY MAP NOT TO SCALE THOMAS BROS. GUIDE GREENFIELD | DRIVE PAGE 1251 G-2

PLOT PLAN EXHIBIT

FOR BRADLEY COURT HEALTHCARE CENTER MUP MODIFICATION

PROPOSED ASSISTED

LIVING BUILDING

269'

EXISTING BUILDING

PROPOSED SKILLED

NURSING BUILDING

ENGINEER'S SEAL

PREPARED BY:

KYLE KOIVUNIEMI, PE


REGISTERED ENGINEER


58449

RCE NUMBER

EXISTING BUILDING

MONUMENT SIGN

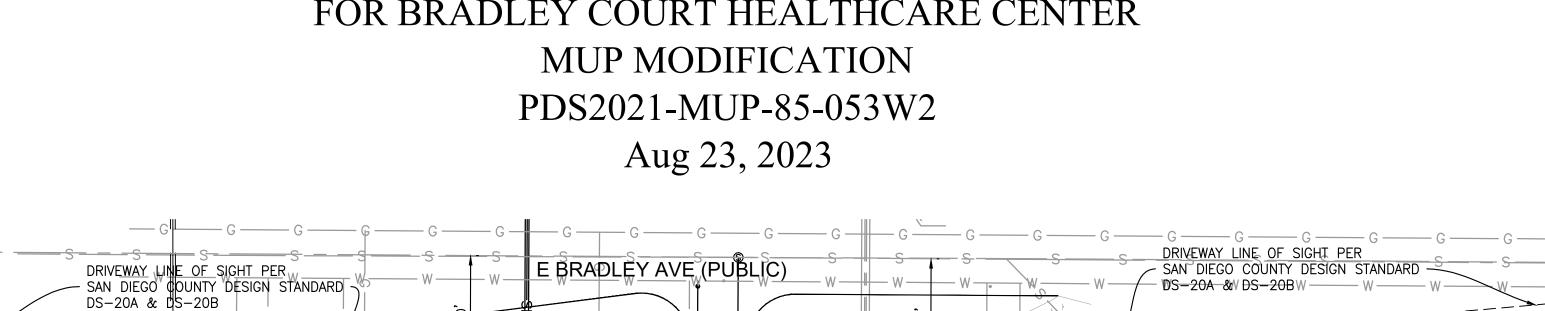

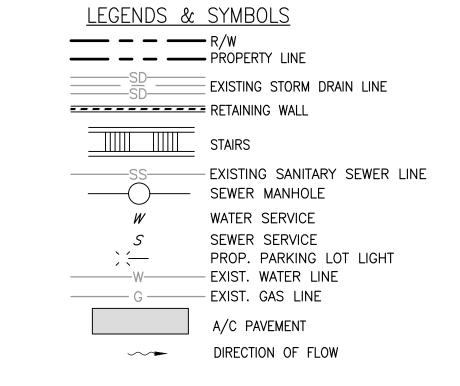


	ZONE BOX	
USE REGULA	TIONS	RU
ANIMAL REG	ULATIONS	Q
	DENSITY	
	LOT SIZE	6000
N.S.	BUILDING TYPE	L
ME	MAXIMUM FLOOR AREA	
OP AT	FLOOR AREA RATIO	
DEVELOPMENT REGULATIONS	HEIGHT	G
	LOT COVERAGE	
	SETBACK	К
	OPEN SPACE	A
SPECIAL ARE	EA REGULATIONS	С


COMMUNITY PLAN:

DISCRETIONARY PERMIT #:


CERTIFICATE OF COMPLIANCE REC.

MUP P85-053W2

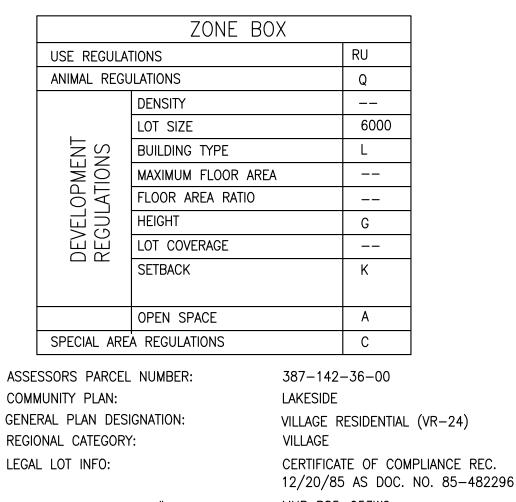

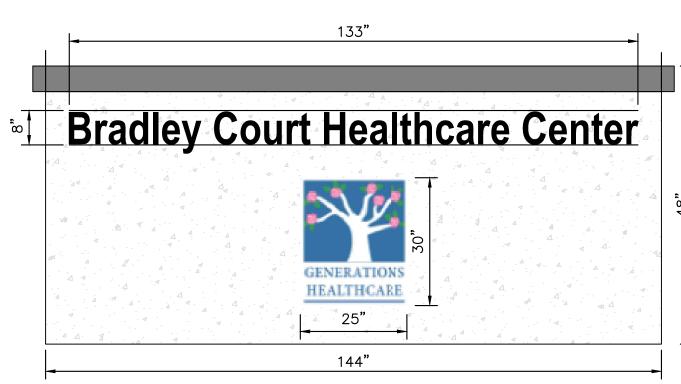

1. CMU WALL WITH STUCCO FINISH. 2. CONCRETE FOOTING / REBAR SIZE AND SPACING SHALL BE PER STRUCTURAL CALCULATIONS. ENTRY MONUMENT WALL DETAIL NOT TO SCALE

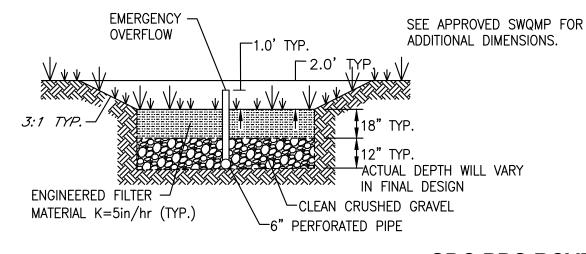

BIO-FILTRATION BASIN TYPICAL SECTION NOT TO SCALE

SDC PDS RCVD 09-24-24 MUP85-053W2

COUNTY APPROVED	CHANGES	PRIVATE CONTRACT			
DESCRIPTION:	APPROVED BY:	DATE:	SHEET COUNTY OF SAN DIEGO DEPARTMENT OF PUBLIC WORKS SHEETS		
			GRADING PLAN FOR:		
			COVER SHEET		
			CALIFORNIA COORDINATE INDEX <u>NAD83 – ZONE VI</u>		
			APPROVED DIRECTOR OF PUBLIC WORKS ENGINEER OF WORK		
			BY:		

PROJECT INFORMATION

APN:

LANDOWNER: EL CAJON REAL ESTATE, LLC 6 HUTTON CENTRE DRIVE, SUITE 400 SANTA ANA, CA 92707

REPRESENTATIVE: MR. THOMAS JURBALA

E-MAIL: THOMASJURBALA@LIFEGEN.COM

675 EAST BRADLEY AVENUE SITE ADDRESS: EL CAJON, CA 92021

GROSS AREA 3.40 ACRES/147,886.26 SF LAND AREA: NET AREA 3.36 ACRES/146,465.97 SF

387-142-36-00

ZONING: RU (RESIDENTIAL-URBAN)

PLANNING GROUP LAKESIDE PLANNING GROUP FIRE DISTRICT: SAN MIGUEL FIRE PROTECTION DISTRICT

SCHOOL DISTRICT: GENERAL ELEMENTARY—CAJON VALLEY UNION HIGH SCHOOL-GROSSMONT UNION

WATER DISTRICT: HELIX WATER DISTRICT

USE CLASSIFICATION:

SEWER DISTRICT PADRE DAM MUNICIPAL WATER DISTRICT

BRADLEY AVENUE (SA 890)(A PUBLIC STREET) IS CLASSIFIED AS A 4.1B MAJOR ROAD.

<u>LEGAL DESCRIPTION;</u> PARCEL B OF BC 86-0183

SOURCE OF TOPO: AERIAL TOPOGRAPHY PREPARED BY AEROTECH

HEALTHCARE/SKILLED NURSING/MUP

MAPPING, INC. WITH CONTROL SURVEY BY EXCEL ENGINEERING.

EC0263-EL CAJON, STREET CENTERLINE MONUMENT

BENCHMARK: ON BRADLEY AVE. 48 FEET EAST OF MAGNOLIA, EL.=394.937

PROJECT TEAM CONSULTANTS

OWNER/APPLICANT:

MR. THOMAS JURBALA GEL CAJON REAL ESTATE, LLC 6 HUTTON CENTRE DRIVE, SUITE 400 SANTA ANA, CA 92707

E-MAIL: THOMASJURBALA@LIFEGEN.COM

MR. GREGG MAEDO **ARCHITECT:**

GREGG MAEDO AND ASSOCIATES 321 NORTH RAMPART STREET, SUITE 101 ORANGE, CA 92868

PHONE: 714-937-1985

CIVIL ENGINEERING: MR. KYLE KOIVUNIEMI, P.E. KIMLEY-HORN AND ASSOCIATES, INC. 1100 W TOWN AND COUNTRY RD, SUITE 700

ORANGE, CA 92782

PH (714) 939-1030 KYLE.KOIVUNIEMI@KIMLEY-HORN.COM

CONTRACTOR: MR. STEVE L'HOMMEDIEU ARCO CONSTRUCTION CO. 900 N. ROCKHILL ROAD

> ST. LOUIS, MO 63119 SLHOMMEDIEU@ARCO1.COM

LANDSCAPE ARCHITECT: MR. JAKE PATTON KSA DESIGN STUDIO 6150 WASHINGTON BLVD. CULVER CITY, CA 90232

GEOTECHNICAL ENGINEERING; MR. ANDY GUATELLI

DIAL TOLL FREE

AT LEAST TWO DAYS

BEFORE YOU DIG

GEOSOILS, INC. 5741 PALMER WAY CARLSBAD, CA 92010 PH 760-438-3155 AGUATELLI@GEOSOILSINC.COM

PH (310) 574-4460

J,PATTON@KSA-LA.COM

SHEET 1-COVER SHEET

SHEET INDEX

SHEET 2-EXISTING CONDITIONS EXHIBIT SHEET 3-HORIZONTAL CONTROL AND PAVING PLAN SHEET 4-GRADING AND DRAINAGE PLAN SHEET 5-GRADING AND DRAINAGE SECTIONS

SHEET 6-GRADING AND DRAINAGE SECTIONS SHEET 7-AUTOTURN EXHIBIT SHEET 8-DMA AND BIOFILTRATION BASIN EXHIBIT SHEET 9-ARCHITECTURAL PLOT PLAN

BUILDING USE DESCRIPTION BUILDING 1-SKILLED NURSING (EXISTING) TO REMAIN SIZE: 6,950 SF/28 BEDS

BUILDING 2-SKILLED NURSING (EXISTING) TO REMAIN SIZE: 6,500 SF/28 BEDS

BUILDING 3-SKILLED NURSING (PROPOSED)

SIZE: 10,613 SF/31 BEDS

SIZE: 26,515 SF/66 BEDS

BUILDING 4-ASSISTED LIVING (PROPOSED)

PARKING TABULATION

PARKING SPACES REQUIRED: 94 TOTAL BEDROOM X 0.33 (SPACES PER BED)= 31 SPACES EMPLOYEE PARKING = 40 SPACES

TOTAL PARKING REQUIRED (40+31): 71 SPACES

PARKING PROVIDED: STANDARD SPACES CLEAN AIR/ELECTRICAL VEHICLE SPACE ELECTRIC VEHICLE CHARGING SPACE ACCESSIBLE ELECTRIC VEHICLE CHARGING SPACE ACCESSIBLE PARKING SPACES MOTORCYCLE PARKING SPACES

TOTAL PARKING PROVIDED: BICYCLE SPACES PROVIDED: TOTAL =3 SPACES

ALL OUTDOOR LIGHTING AS A RESULT OF THIS PROJECT SHALL COMPLY WITH THE REQUIREMENTS SPECIFIED IN THE COUNTY LIGHT POLLUTION CODE WHICH COMMENCES AT SECTION 51.201 OF THE COUNTY CODE OF REGULATORY ORDINANCE.

73 SPACES

DISTURBED AREA

3.10 ACRES/135,174 SQ. FT.

EARTHWORK

GRADING QUANTITIES CUT VOLUME = 4,525 CY (ASSOCIATED WITH MAJOR FILL VOLUME = 4,525 CY ROADS/INFRASTRUCTURE) IMPORT = 0 CY0 CY

PROJECT DESCRIPTION

THE PROPOSED SITEWORK WILL INCLUDE 73 NEW PARKING SPACES, AND A NEW FIRE LANE ACCESS ROAD ALLOWING ACCESS TO THE REAR OF EXISTING BUILDING 2 AND THE NEW BUILDING 3. A NEW DRIVEWAY APPROACH ALONG BRADLEY AVENUE WILL BE PLACED FOR FULL FIRE TRUCK ACCESS. NEW SEWER, DOMESTIC WATER, AND FIRE WATER (INCLUDING ONE ADDITIONAL FIRE HYDRANT) WILL BE PROVIDED WITH THE SITEWORK. TWO TRASH ENCLOSURES FOR REFUSE AND RECYCLED GOODS WILL BE PROVIDED. ALONG WITH NEW LANDSCAPING THROUGHOUT THE FACILITY, SITE LIGHTING WILL BE INSTALLED TO PROVIDE A MINIMUM OF 1.0 FC OF LIGHTING ALONG ALL EGRESS PATHS TO THE PUBLIC WAY. THE CURRENT FACILITY IS SERVED BY AN EXISTING EMERGENCY GENERATOR, A NEW GENERATOR WILL BE PROVIDED TO MEET ALL AIR QUALITY REQUIREMENTS. ALL WORK OUTSIDE OF THE BUILDING ENVELOPS FALLS UNDER LOCAL JURISDICTION, WITH JOINT REVIEW AND OVERSIGHT BY HCAI ON SOME ITEMS SUCH AS

PRECONSTRUCTION NOTE PRIOR TO ANY CLEARING, GRUBBING, TRENCHING, GRADING, OR ANY LAND DISTURBANCES. HAPPENS AFTER THE GRADING

PERMIT HAS BEEN ISSUED AND THE APPLICANT IS READY FOR GROUND DISTURBING ACTIVITY. PRE-CON IS A MEETING IN WHICH THE PDCI INSPECTOR MEETS WITH THE EOW, CONTRACTORS, MONITORS, PDS STAFF, CONSULTANTS, AND THE OWNER TO DISCUSS RESPONSIBILITIES AND EXPECTATIONS.

ATE)

NORTH


BUILDING PAD CERTIFICATION, FIRE SERVICE INSTALLATION, ETC. GRAPHIC SCALE IN FEET

DATE DRAWN BY DATE CHECKED BY REV. SYMBOL **DESCRIPTION OF CHANGE** R.C.E. DATE P.D.E. DATE

UNDERGROUND SERVICE ALERT OF SOUTHERN CALIFORNIA

Know what's **below.**

Call before you dig.

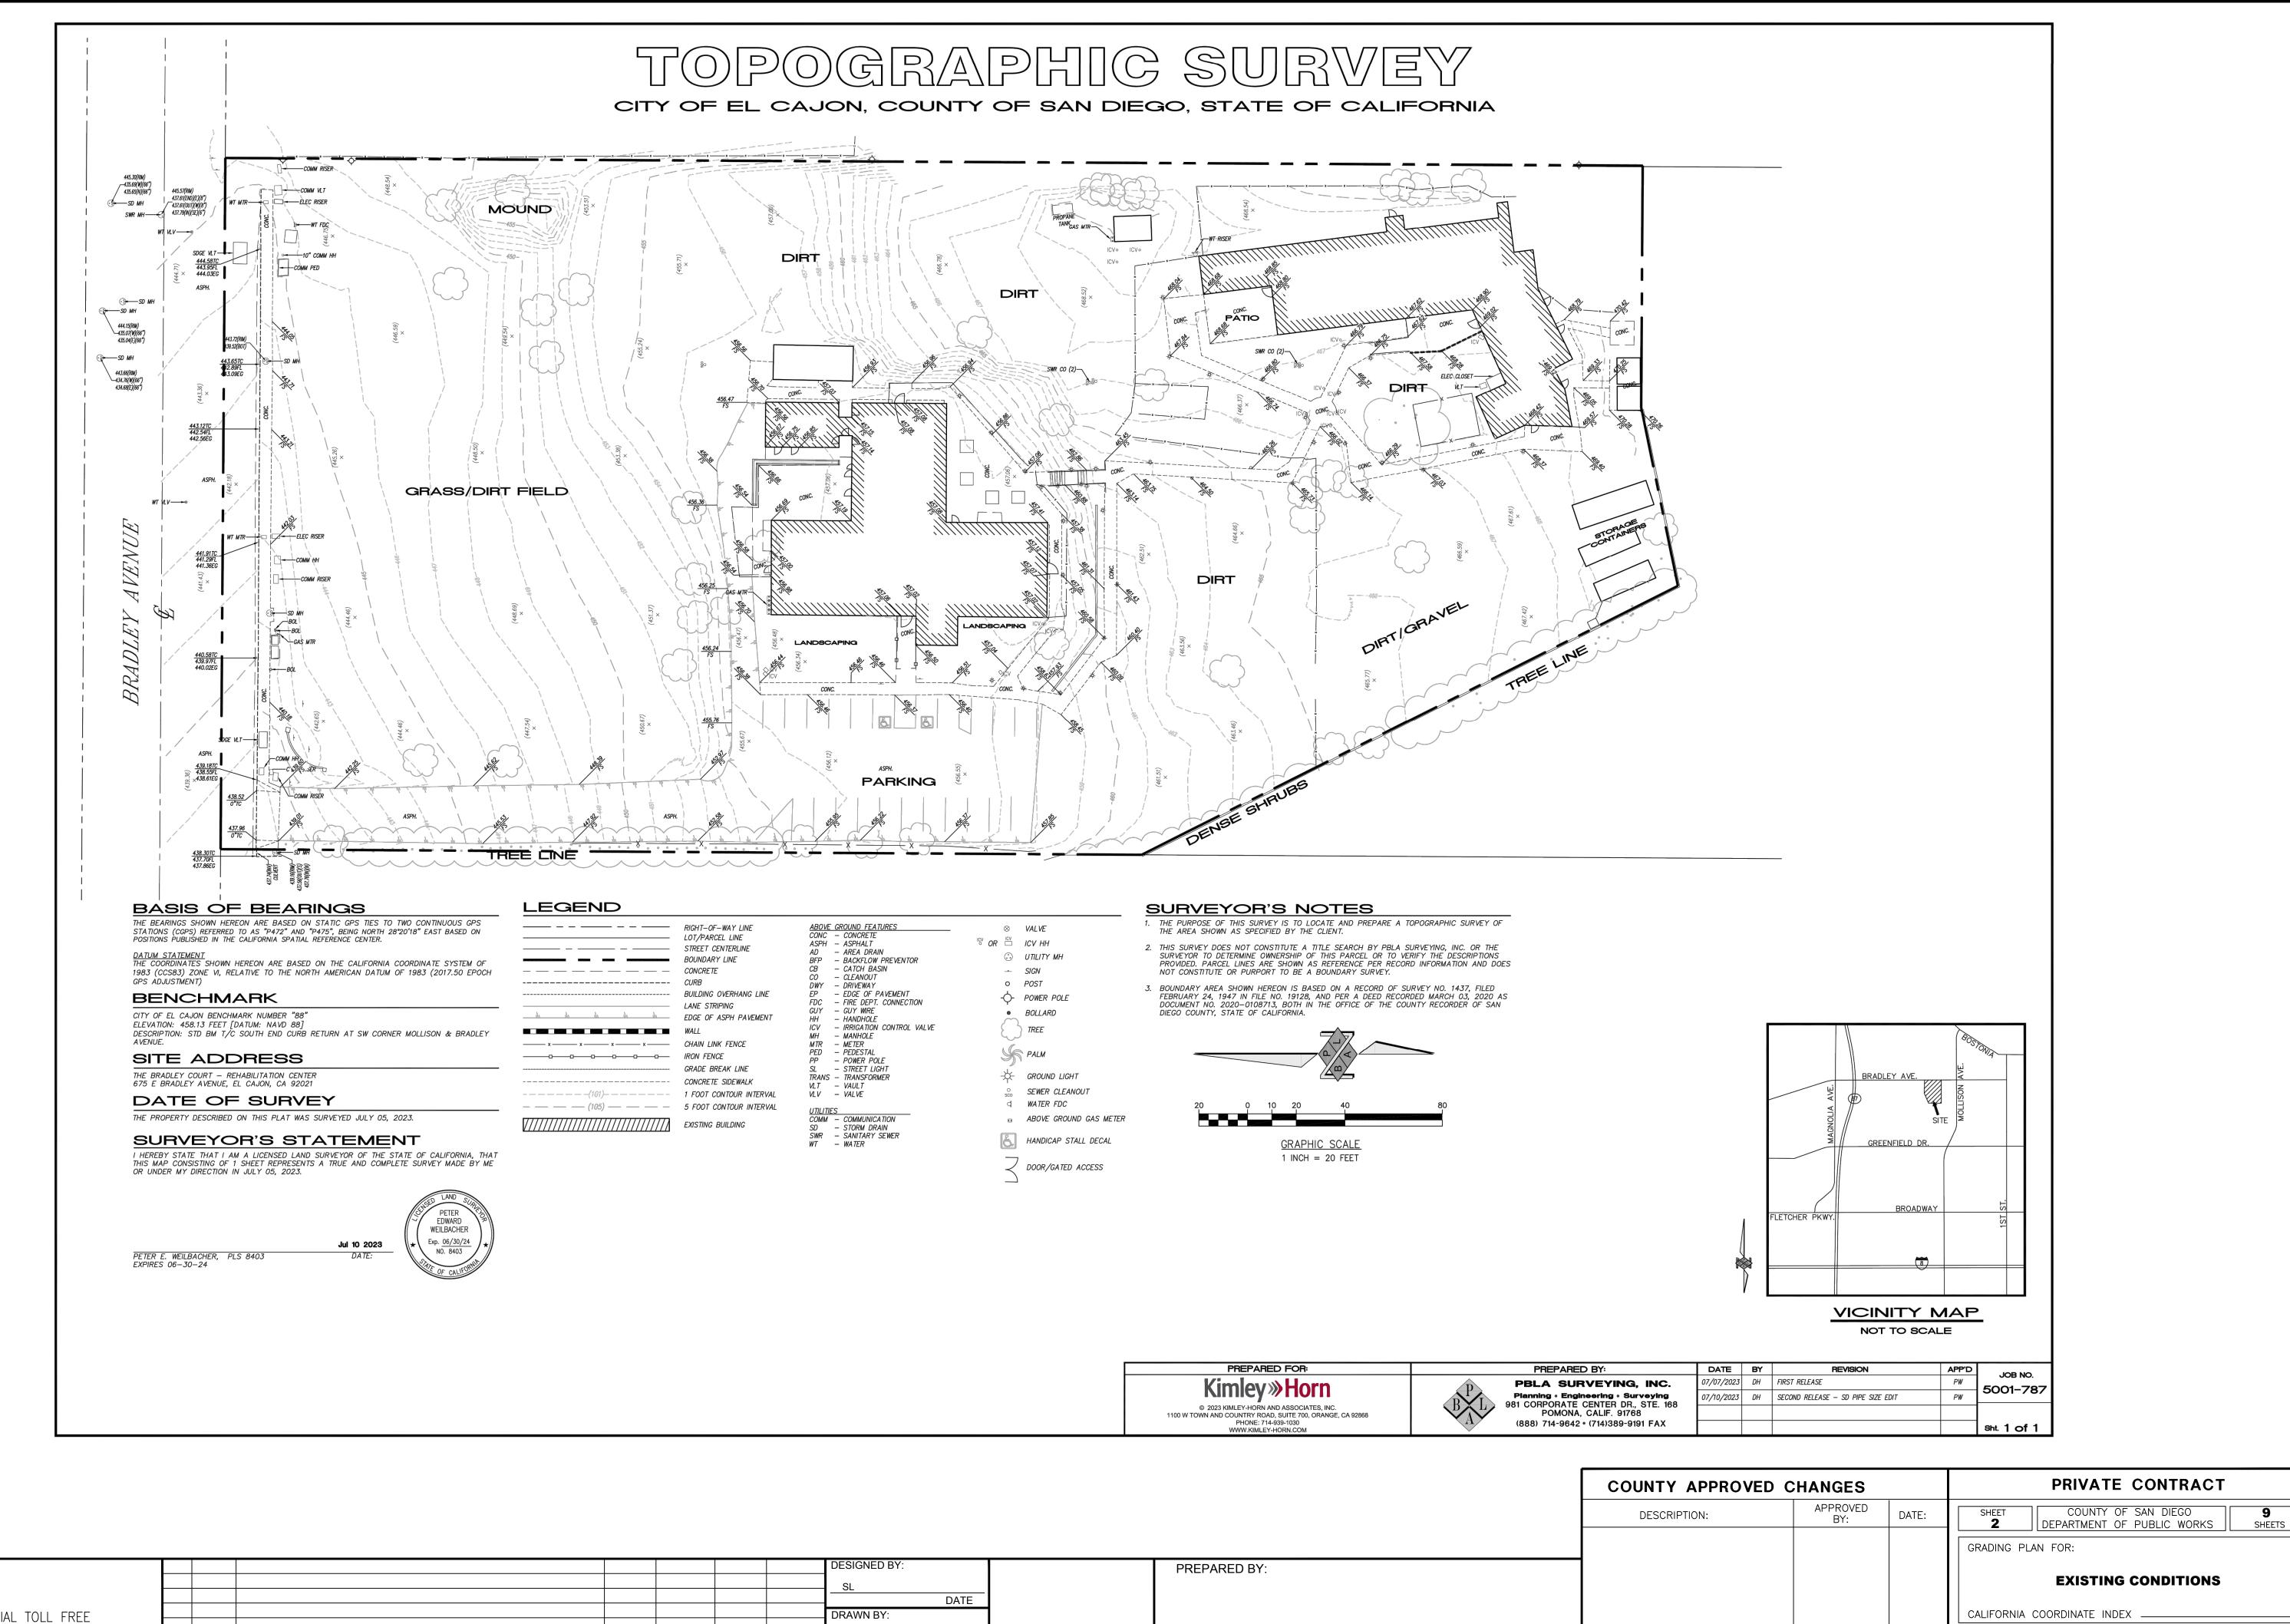

ENGINEER'S SEAL

Know what's **below.** Call before you dig.


BEFORE YOU DIG UNDERGROUND SERVICE ALERT OF SOUTHERN CALIFORNIA


DIAL TOLL FREE AT LEAST TWO DAYS


							DESIGNED BY:	
							SL	
								DATE
							DRAWN BY:	
							SL	
								DATE
							CHECKED BY:	
							KK	
REV.	SYMBOL	DESCRIPTION OF CHANGE	R.C.E.	DATE	P.D.E.	DATE		DATE

KYLE KOIVUNIEMI, PE 58449 REGISTERED ENGINEER RCE NUMBER DIRECTOR OF PUBLIC WORKS


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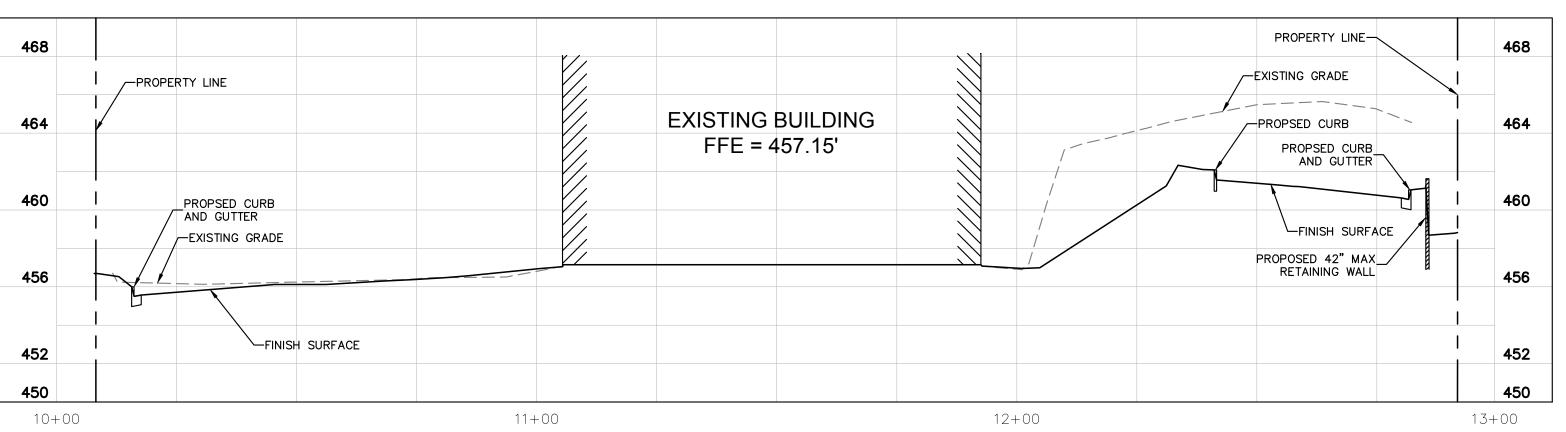


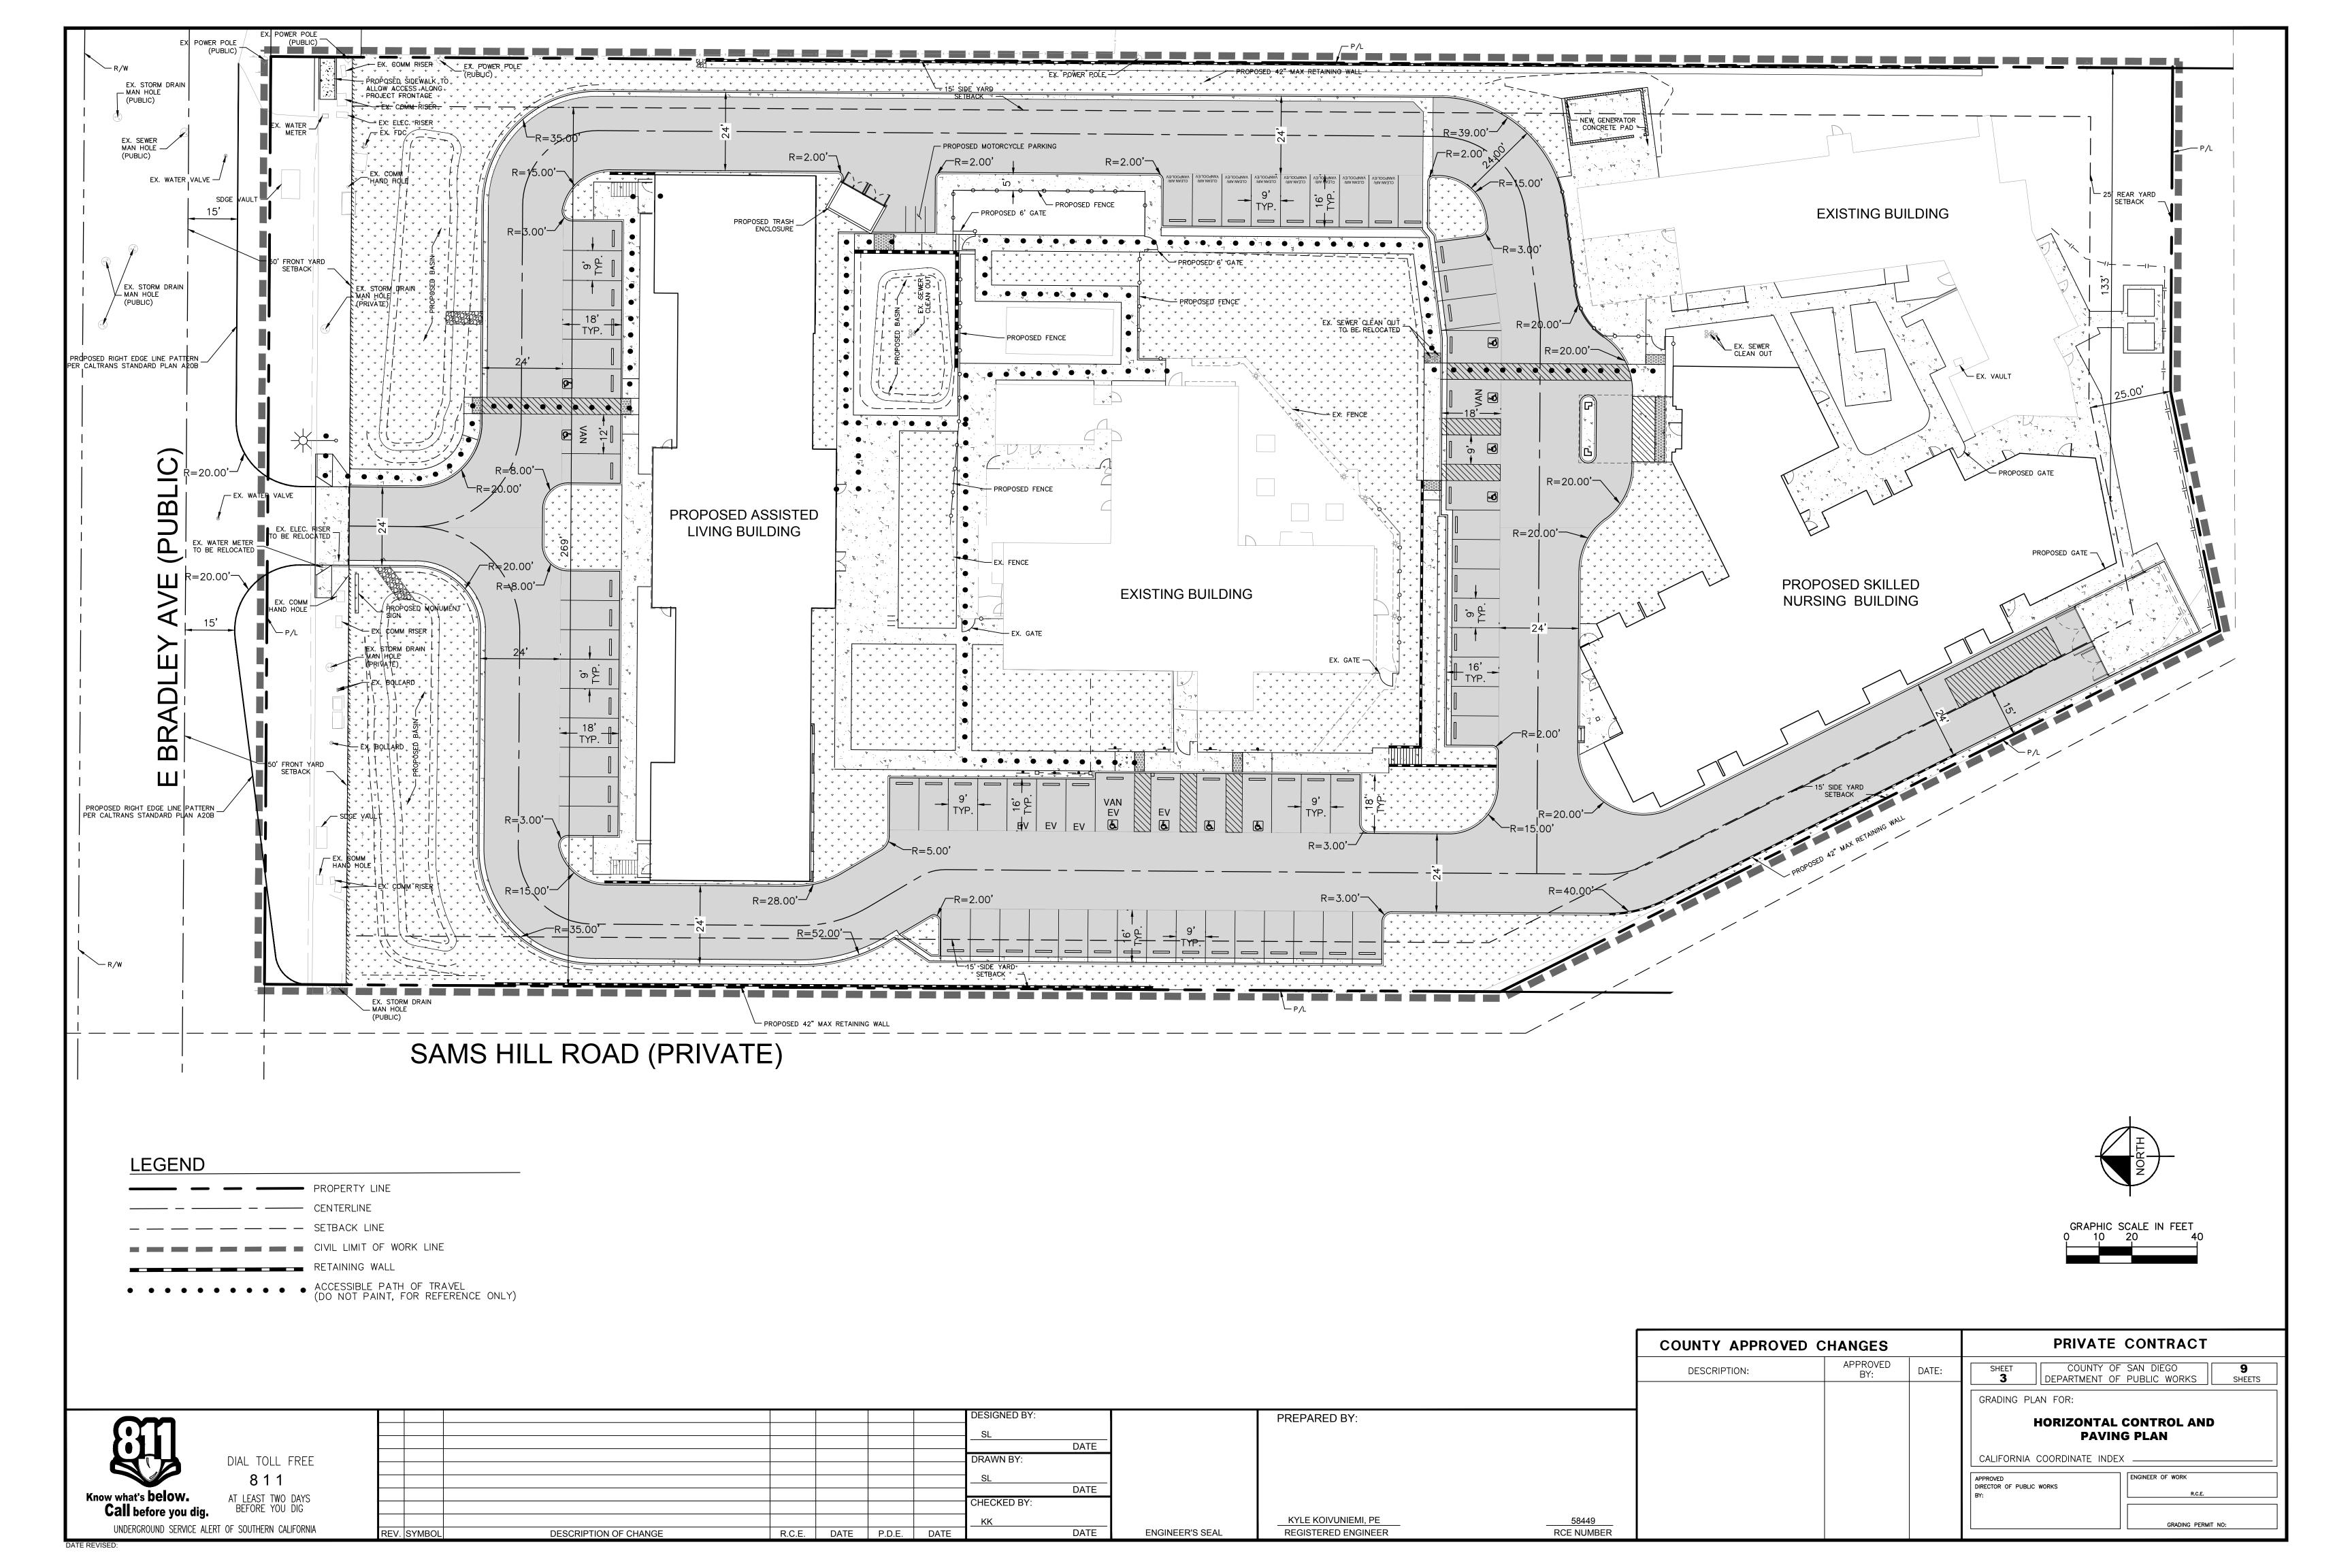

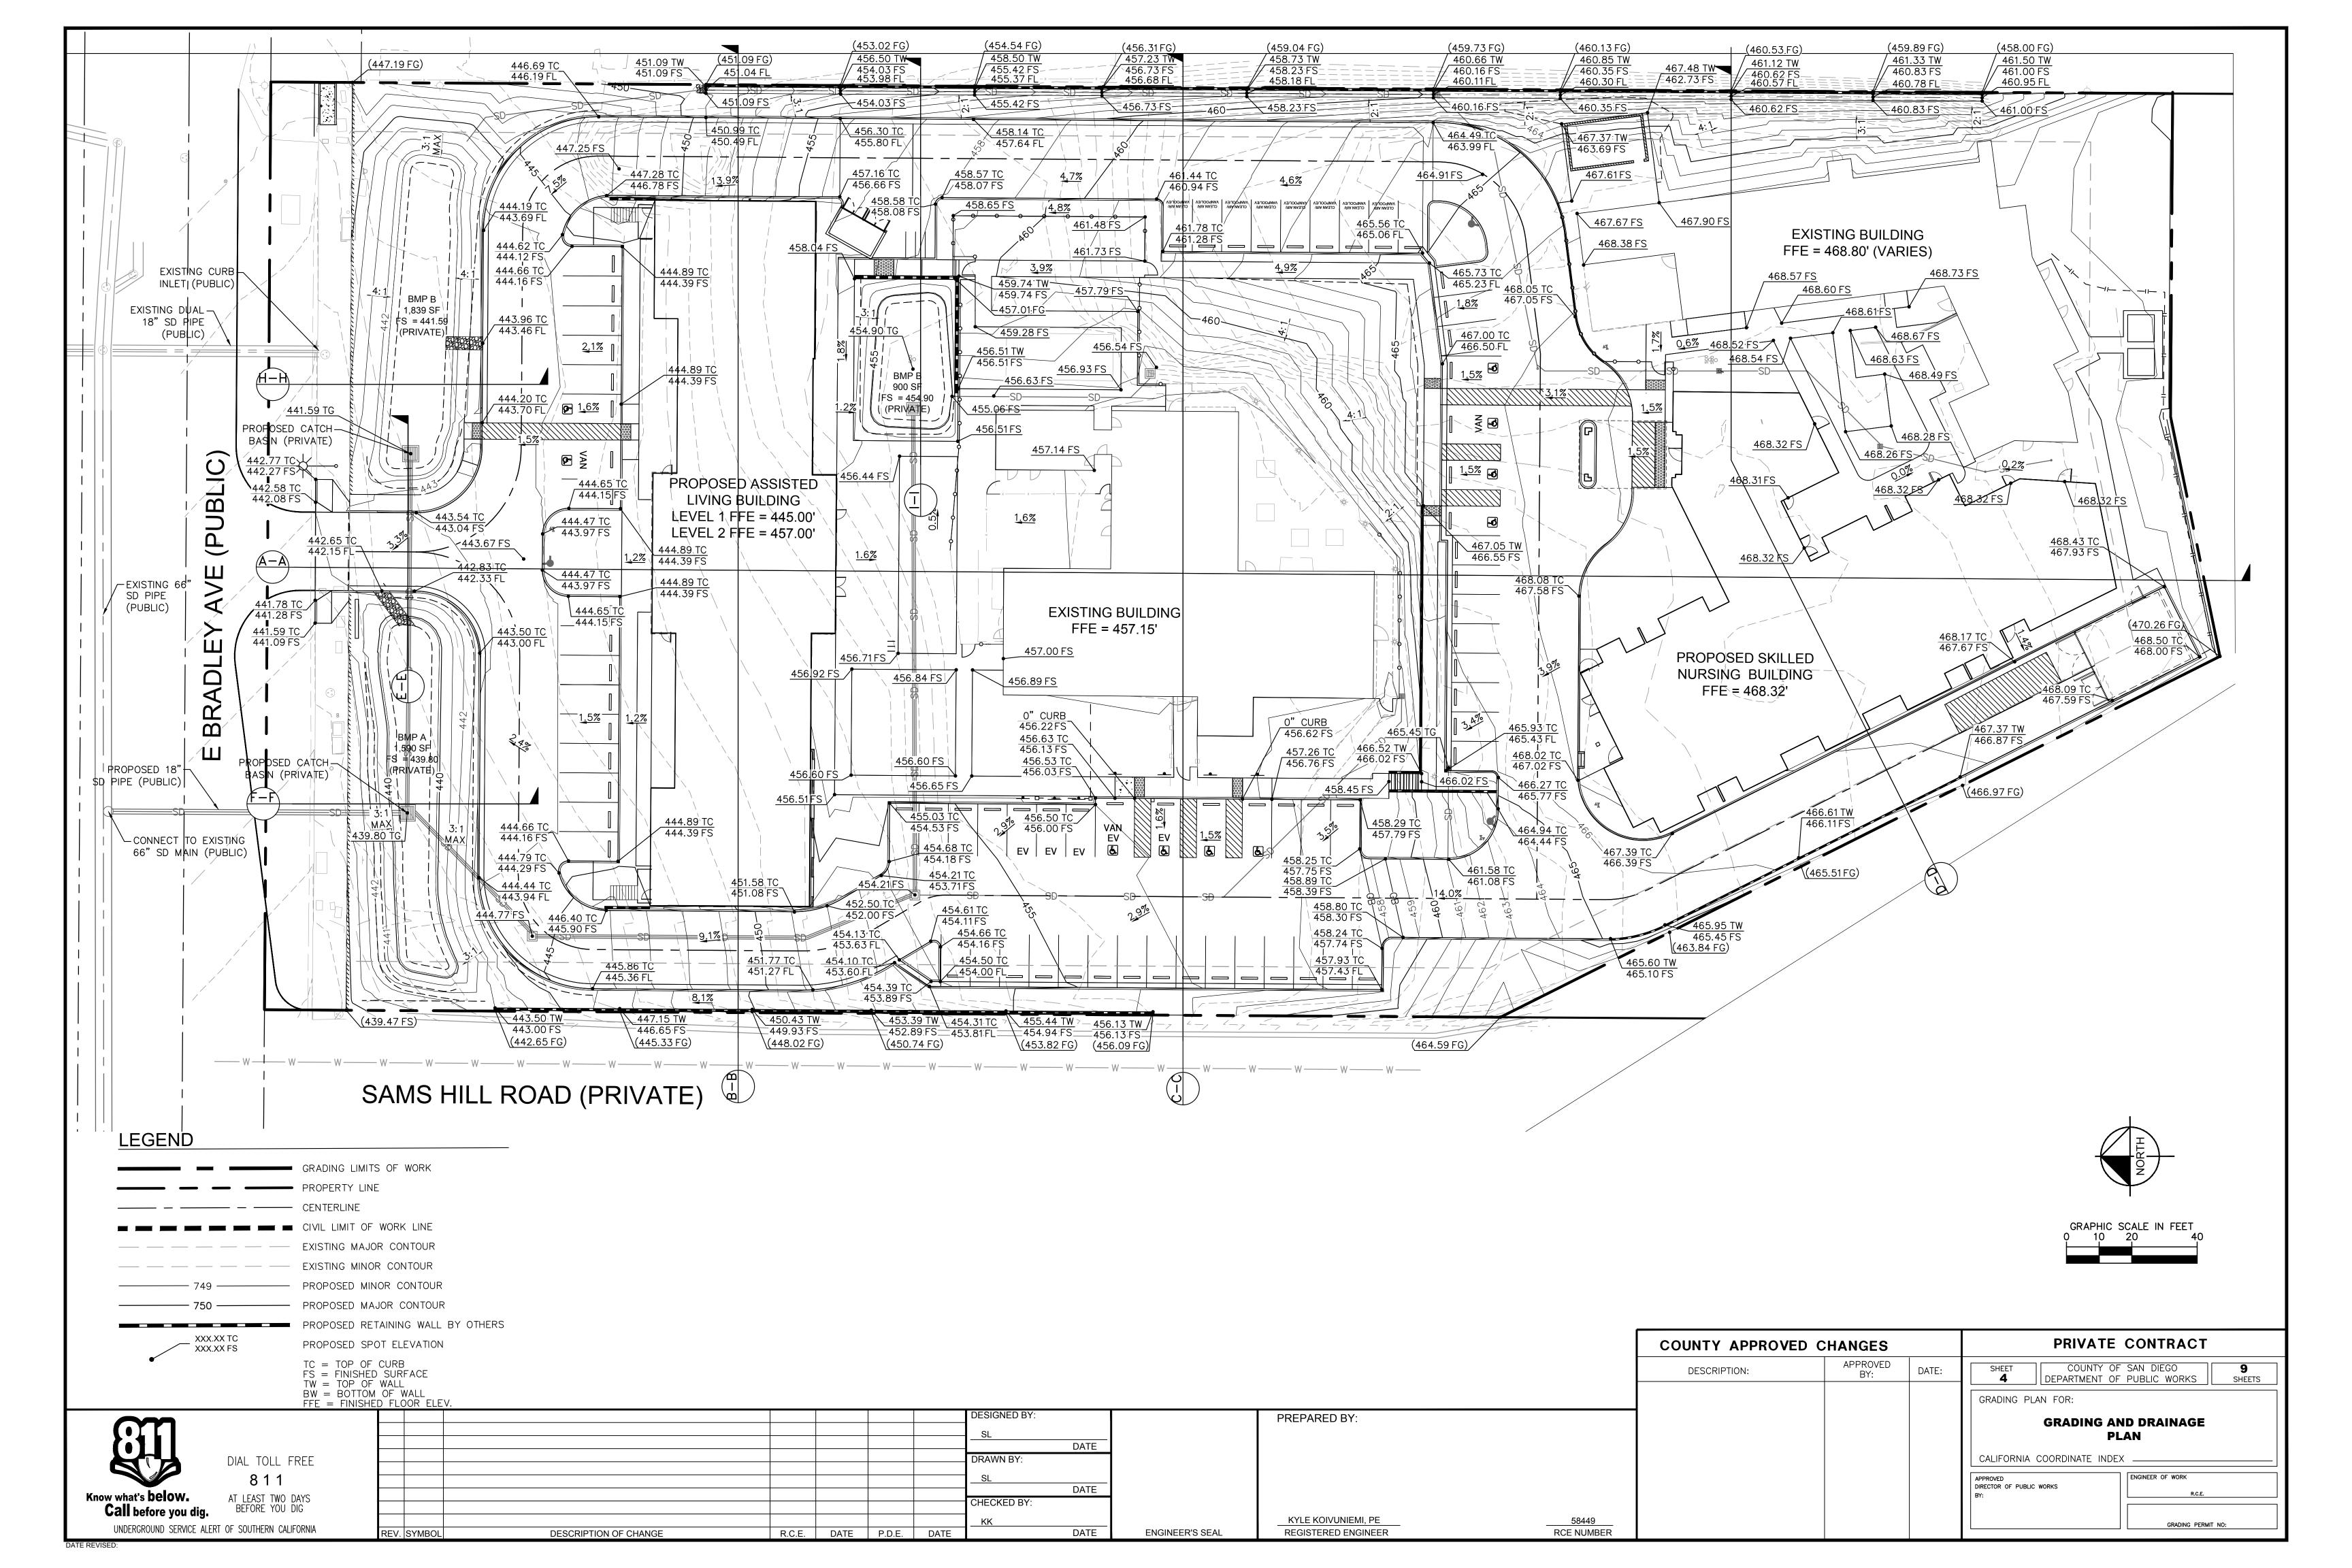

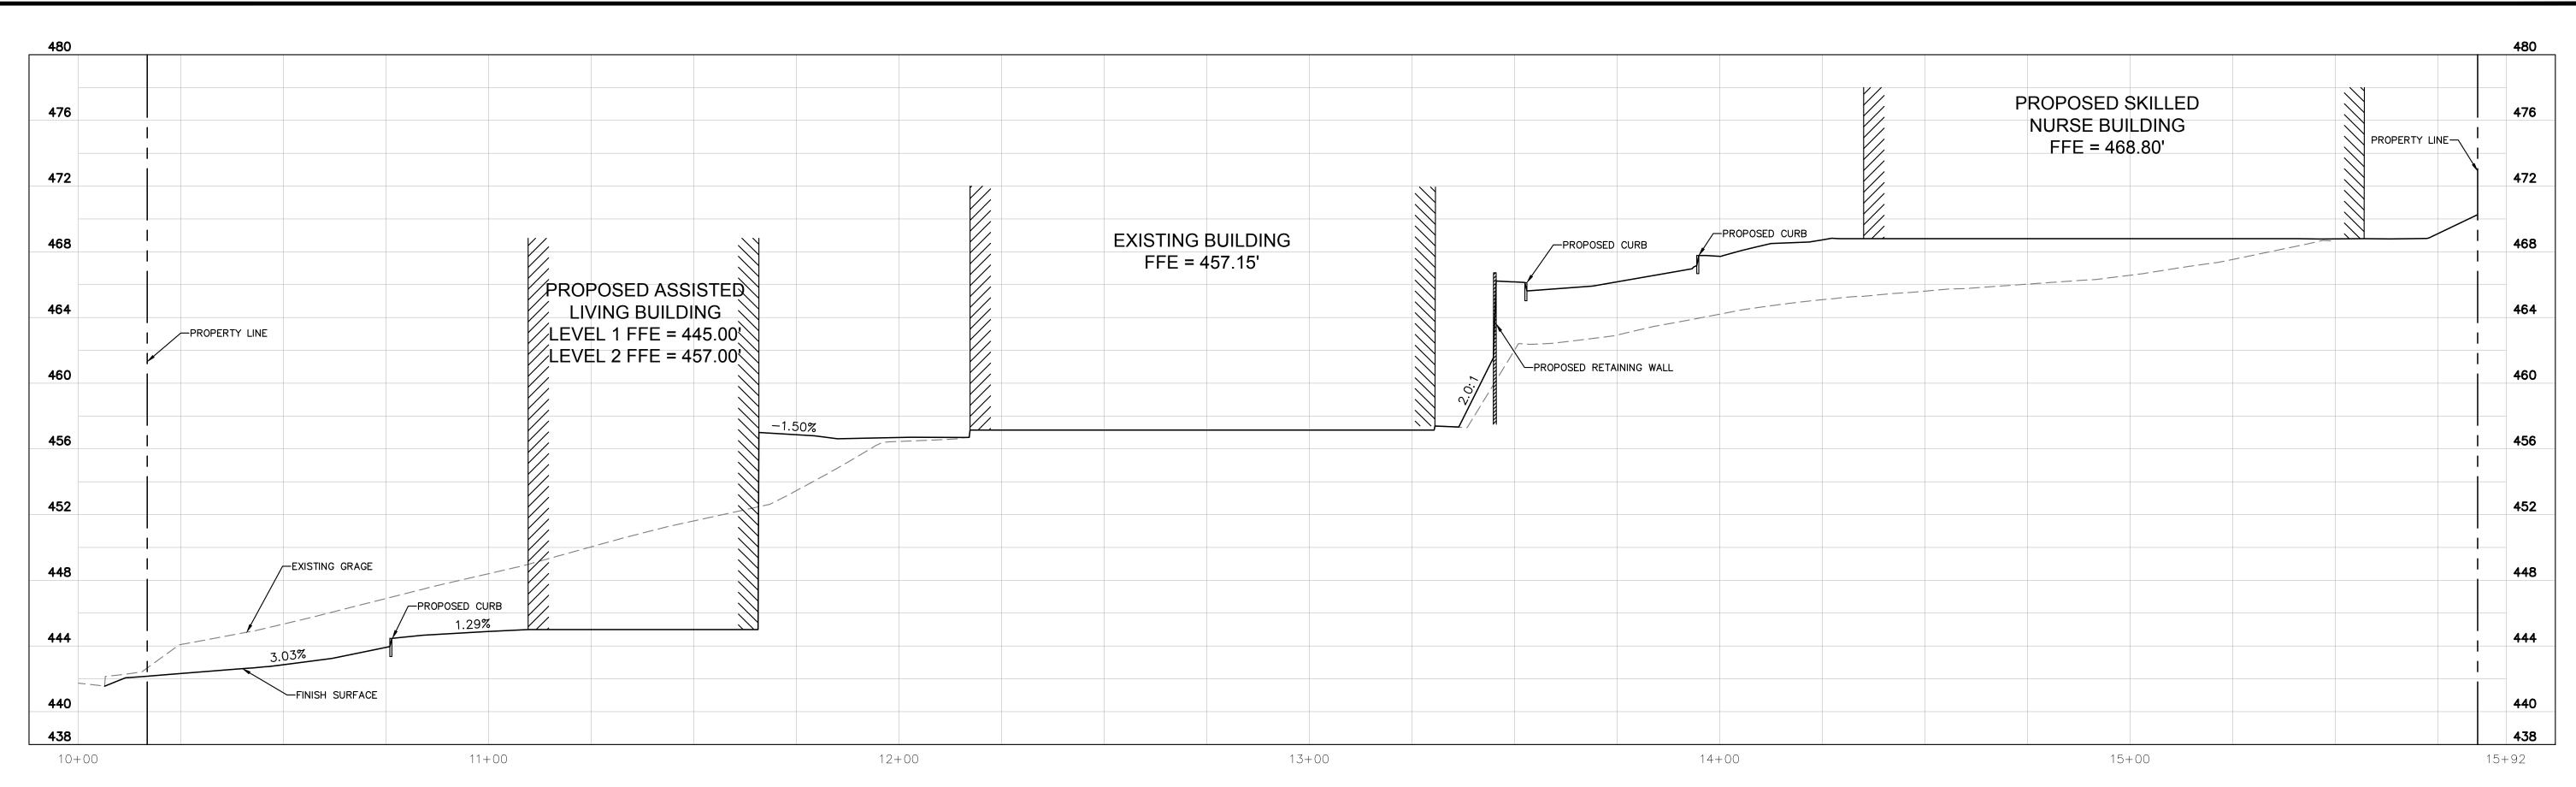SECTION A-A: SCALE: V: 1" = 5' H: 1" = 20'



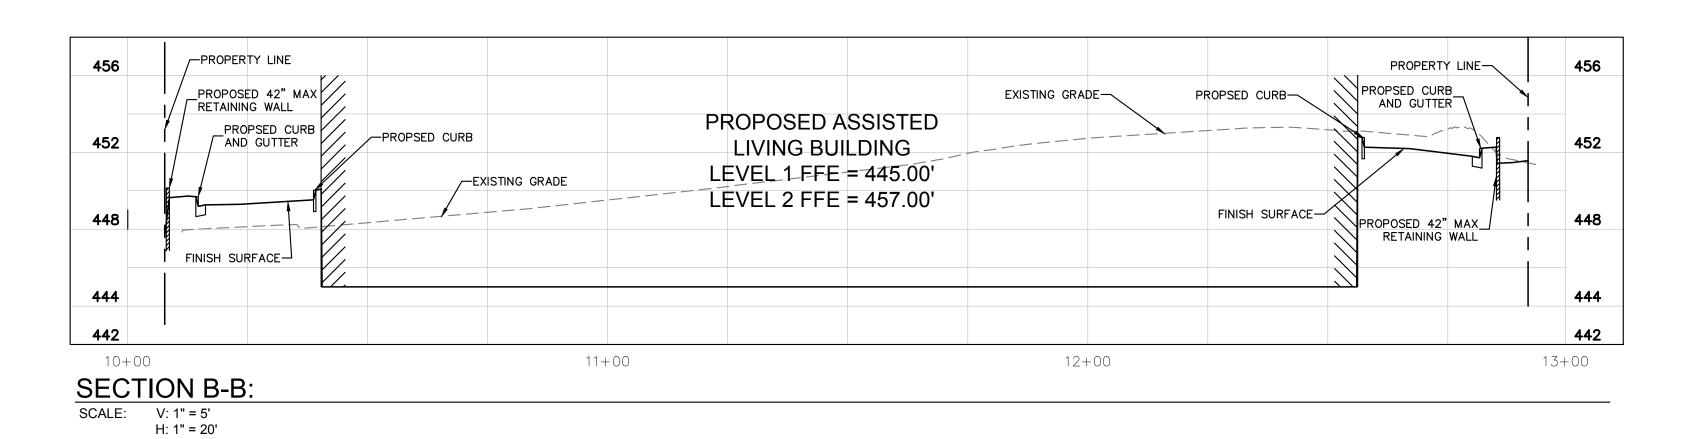

SECTION C-C: SCALE: V: 1" = 5' H: 1" = 20'

DATE

DATE

	COUNTY APPROVED C	HANGES	PRIVATE CONTRACT	
	DESCRIPTION:	APPROVED BY:	DATE:	SHEET COUNTY OF SAN DIEGO 5 DEPARTMENT OF PUBLIC WORKS SHEETS GRADING PLAN FOR:
) IBER				SECTIONS CALIFORNIA COORDINATE INDEX APPROVED DIRECTOR OF PUBLIC WORKS BY: GRADING PERMIT NO:

Know what's below.

Call before you dig.

AT LEAST TWO DAYS
BEFORE YOU DIG UNDERGROUND SERVICE ALERT OF SOUTHERN CALIFORNIA

DIAL TOLL FREE

DESCRIPTION OF CHANGE R.C.E. DATE P.D.E. DATE REV. SYMBOL

ENGINEER'S SEAL

KYLE KOIVUNIEMI, PE


REGISTERED ENGINEER

_____58449 RCE NUMBE

DATE


CHECKED BY:

PREPARED BY:

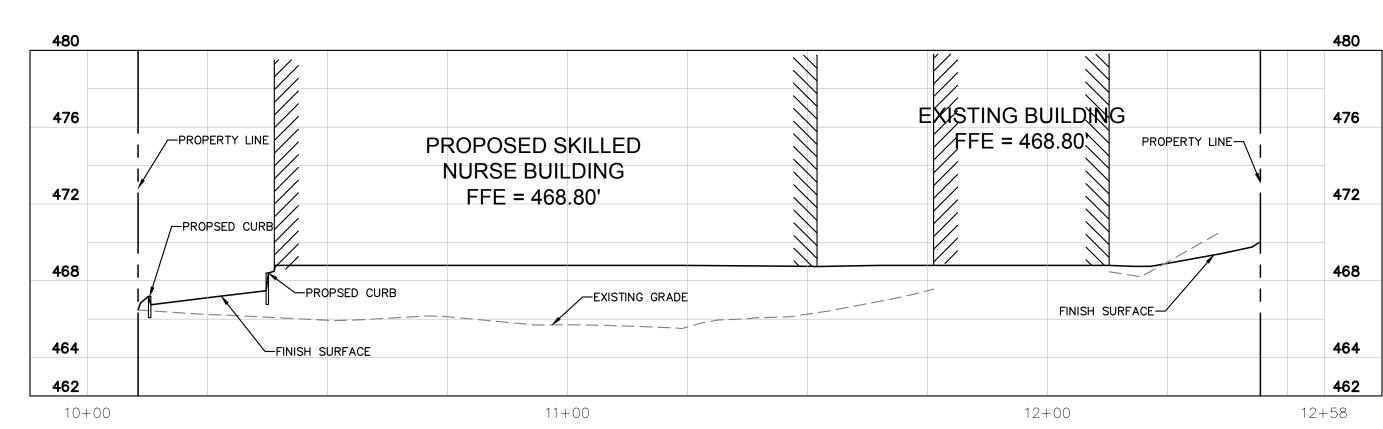


SECTION D-D:

SCALE: V: 1" = 5'
H: 1" = 20'

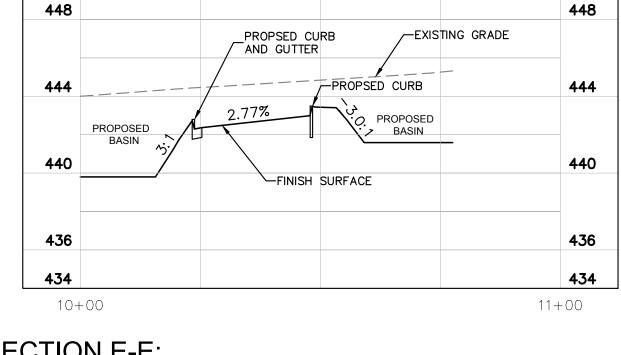


SECTION E-E:

SCALE: V: 1" = 5'
H: 1" = 20'

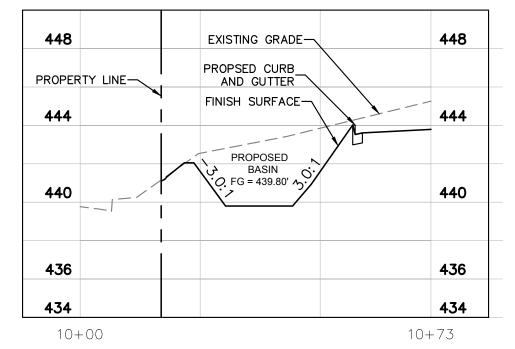


SECTION F-F:

SCALE: V: 1" = 5'
H: 1" = 20'

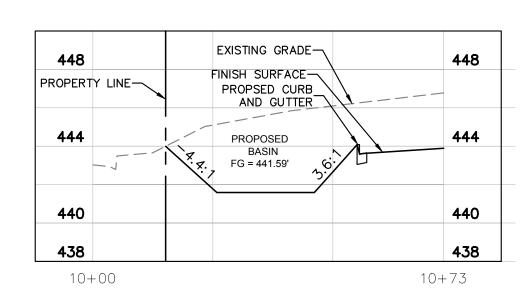


SECTION H-H:


SCALE: V: 1" = 5'
H: 1" = 20'

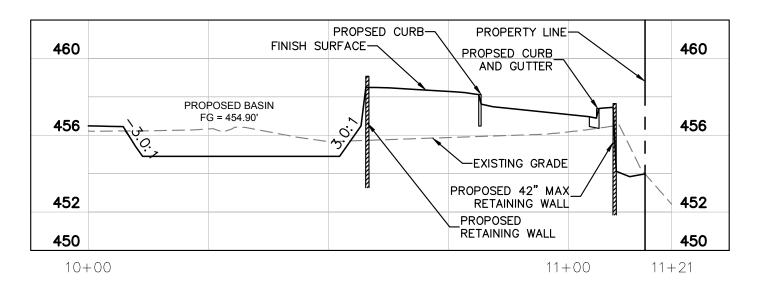


SECTION I-I:

SCALE: V: 1" = 5'
H: 1" = 20'

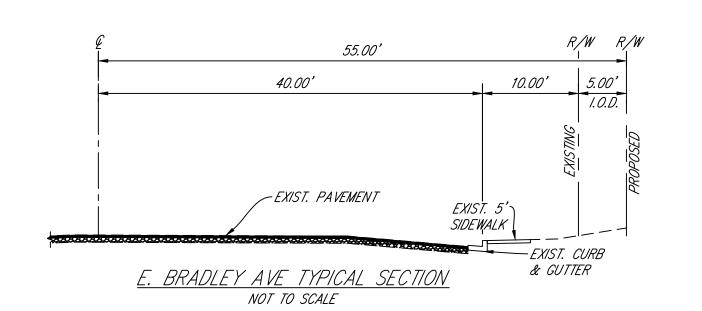

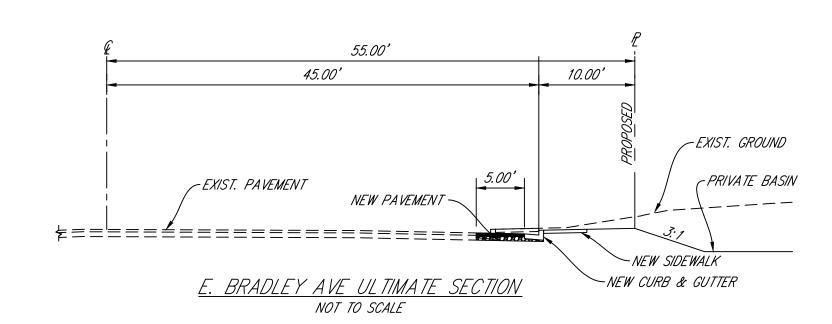

-		
	COUNTY APPROVED CHANGES	PRIVATE CONTRACT
	DESCRIPTION: APPROVED BY: DATE:	SHEET COUNTY OF SAN DIEGO 6 DEPARTMENT OF PUBLIC WORKS SHEETS
		GRADING PLAN FOR:
DESIGNED BY: PREPARED BY:		SECTIONS
SL DATE		SECTIONS
DIAL TOLL FREE DRAWN BY:		CALIFORNIA COORDINATE INDEX
8 1 1 <u>SL</u>		APPROVED DIRECTOR OF PUBLIC WORKS ENGINEER OF WORK
ow what's Delow. AT LEAST TWO DAYS CHECKED BY: CHECKED BY:		BY:
UNDERGROUND SERVICE ALERT OF SOUTHERN CALIFORNIA KYLE KOIVUNIEMI, PE		GRADING PERMIT NO:

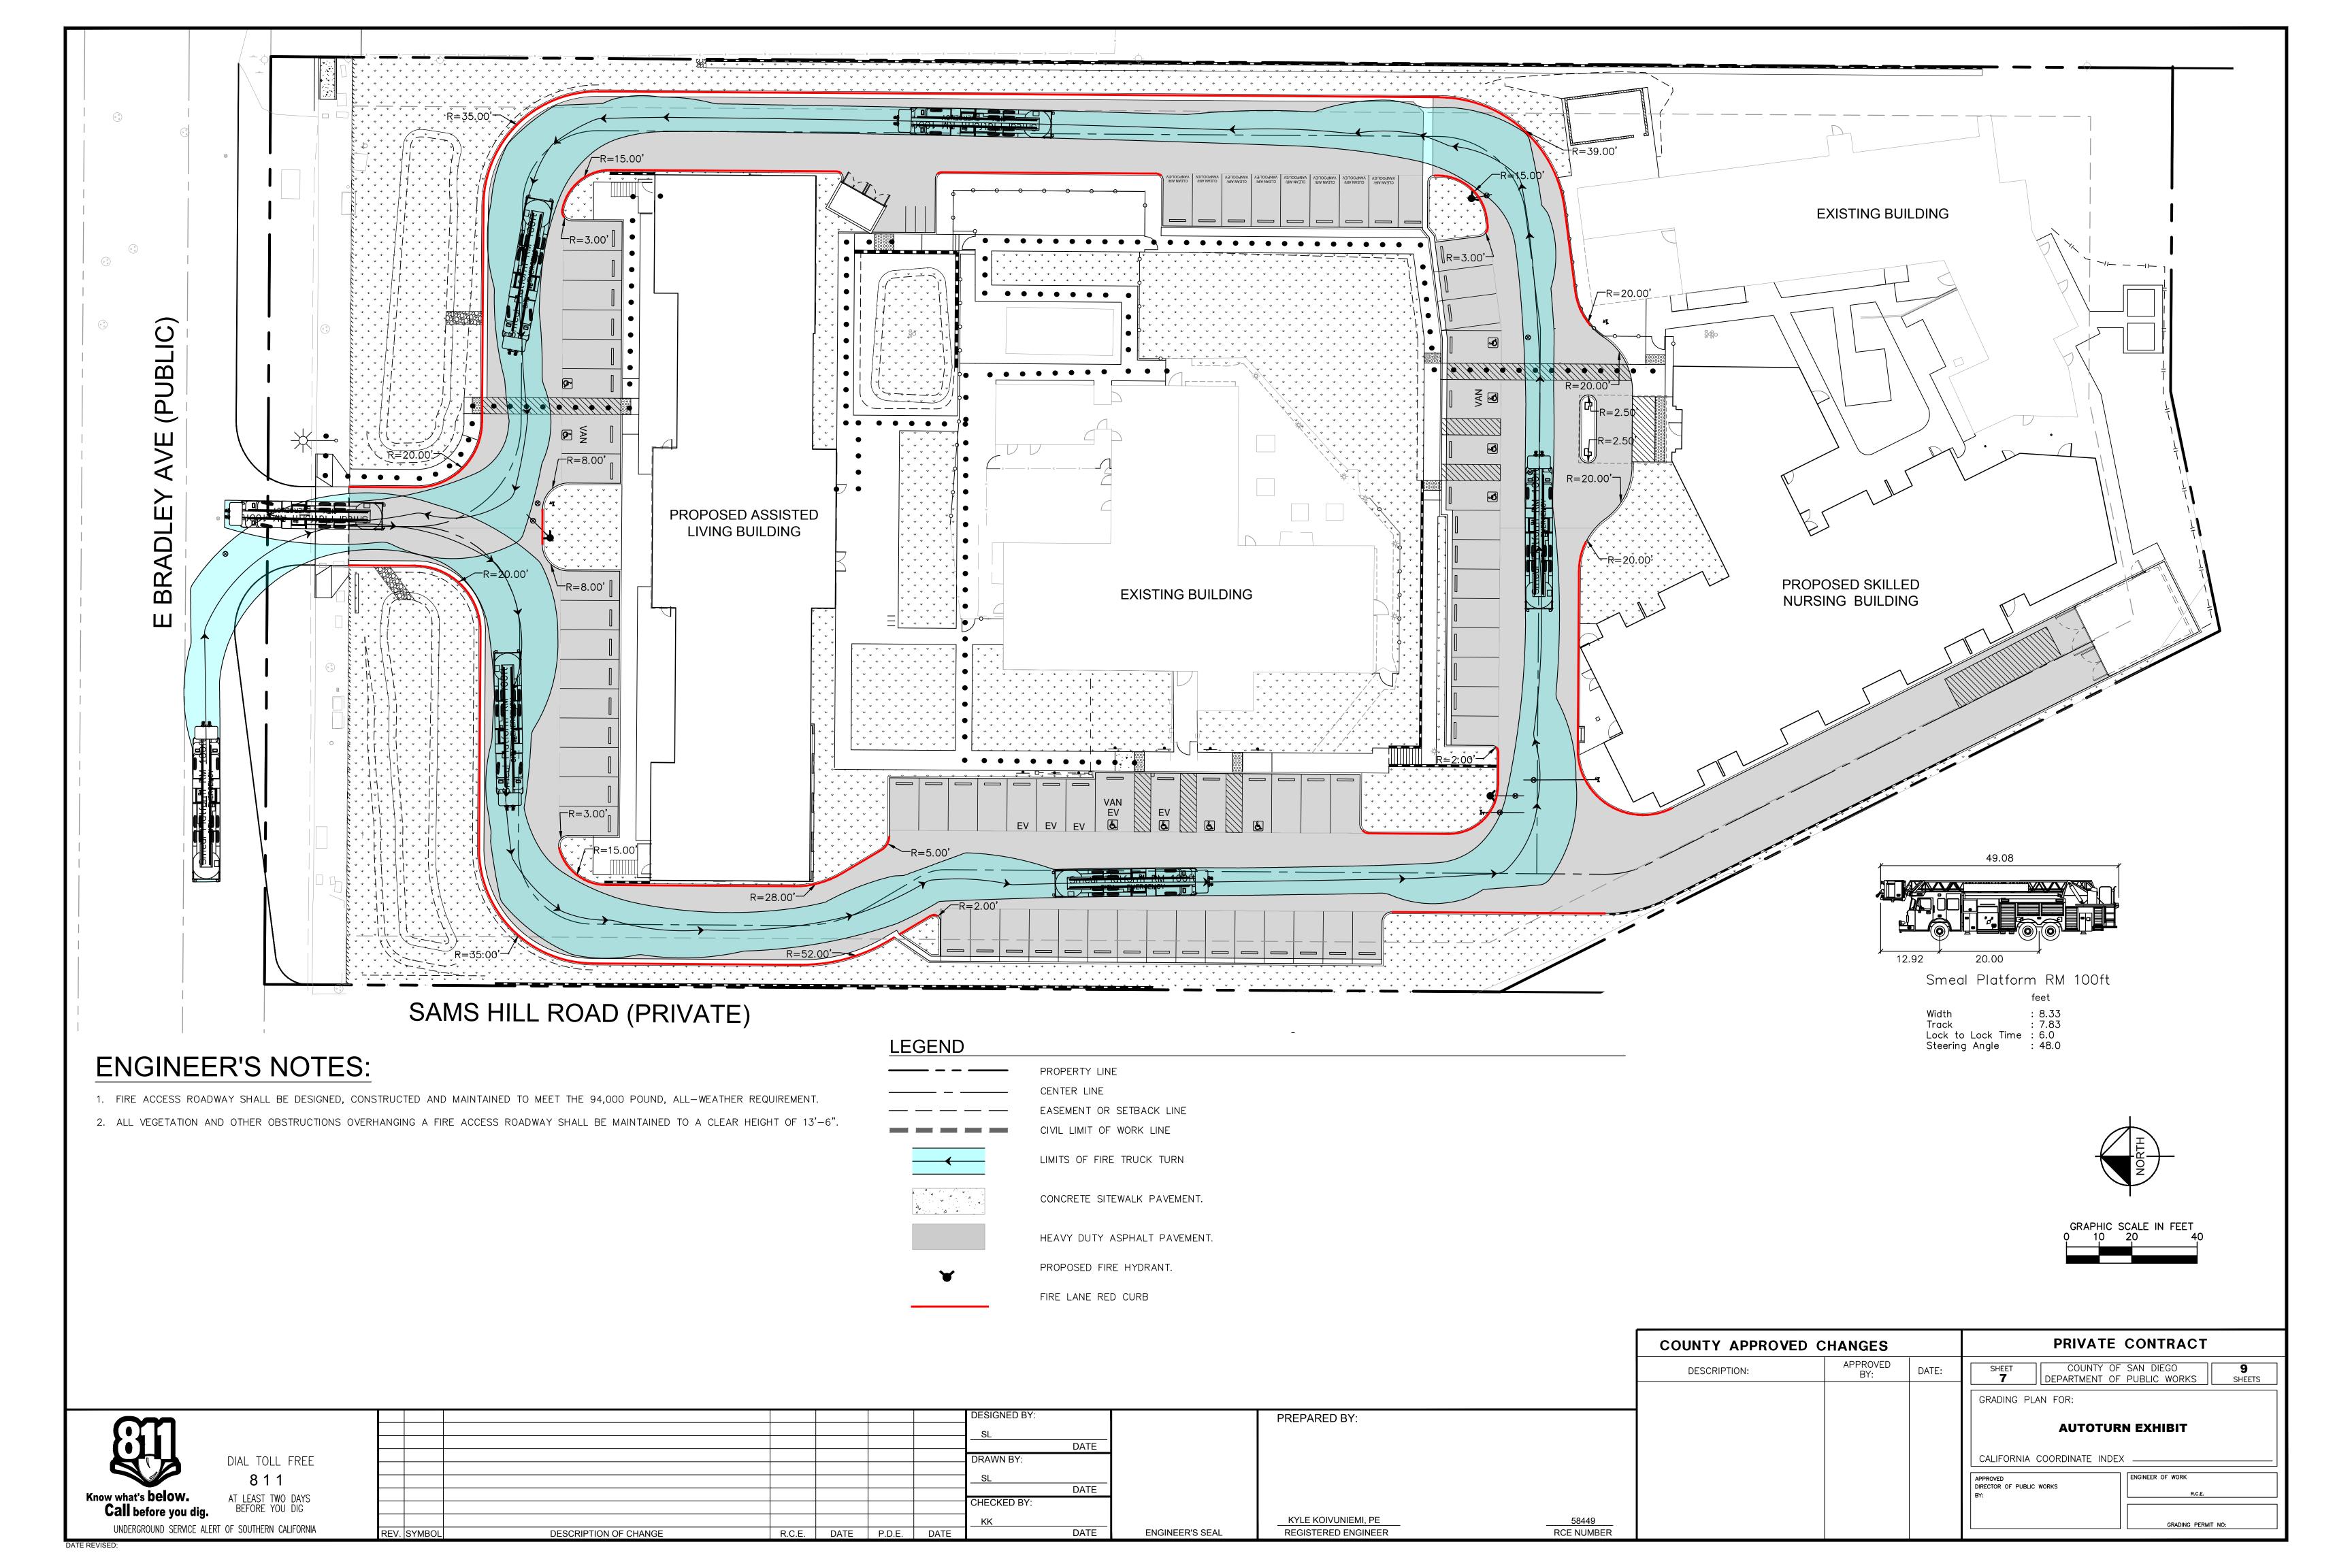

BRADLEY AVENUE

DMA AND BIOFILTRATION BASIN EXHIBIT

WATER QUALITY BASIN INSTALLATION NOTES: 1. 3 INCHES OF WELL-AGED, SHREDDED HARDWOOD MULCH.

- 2. AN UNDERDRAIN CLEANOUT WITH A MINIMUM 6-INCH DIAMETER AND LOCKABLE CAP IS PLACED EVERY 250 TO 300FEET AS REQUIRED BASED ON UNDERDRAIN LENGTH.
- 3. VEGETATION USED SHOULD BE SUITABLE FOR THE CLIMATE PER LANDSCAPE PLANS
- 4. FILTER COARSE IS A MINIMUM OF 6 INCHES PROVIDED IN TWO SEPARATE 3 INCH LAYERS. THE TOP LAYER SHALL BE MADE OF ASTM C33 CHOKER SAND AND THE BOTTOM LAYER BE OF ASTM NO. 8 AGGREGATE. MARKERS STAKES SHALL BE USED TO ENSURE UNIFORM LIFT THICKNESS.
- 5. AASHTO NO. 57 STONE OR CLASS 2 PERMEABLE PER CAL TRANS SPECIFICATION 68-1.025 IS RECOMMENDED FOR THE AGGREGATE STORAGE LAYER. WASHED, OPEN-GRADED CRUSHED ROCK MAY BE USED, HOWEVER, A 4 INCH MINIMUM WASHED PEA GRAVEL FILTER COURSE LAYER AT THE TOP OF THE CRUSHED ROCK IS REQUIRED.
- 6. IMPERMEABLE LINER SHALL BE INSTALLED WHEN THE BIOFILTRATION BASIN IS WITHIN 10 FEET OF RETAINING WALLS OR BUILDING FOUNDATIONS, OR AS RECOMMENDED BY THE SOILS ENGINEER, OR REQUIRED BY THESE PLANS. IMPERMEABLE LINER SHALL BE 30 MIL THICK (PER COUNTY OF SAN DIEGO GREEN STREETS DESIGN STANDARD DRAWING GS-3.00 AND COUNTY GREEN STREETS SUPPLEMENT TO CAL TRANS SPECIFICATIONS 20-11.08B) CONFIGURED TO ENTIRELY ENCOMPASS THE SIDES OF THE WATER QUALITY BASIN.
- 7. IMPERMEABLE LINER BE CONSTRUCTED IN COMPLIANCE WITH THE COUNTY OF SAN DIEGO GREEN STREETS SUPPLEMENT TO CAL TRANS SPECIFICATIONS 20-11.08B.
- 8. BIOFILTRATION SOIL MEDIA LAYER (BSM) SHALL CONSIST OF 60% TO 80% BY VOLUME SAND, UP TO 20% BY VOLUME TOPSOIL. AND UP 20% BY VOLUME COMPOST (PER COUNTY OF SAN DIEGO BMP DESIGN MANUAL SEPTEMBER 2020 APPENDIX F.2 SECTION 803-2 BLENDED BSM CRITERIA AND TESTING REQUIREMENTS) PLACED IN 6" LIFTS AND COMPACTED WITH WATER PRIOR TO THE NEXT LIFT. INITIAL PERMEABILITY SHALL BE 8" PER HOUR (WITH ASSUMED STABILIZED PERMEABILITY OF 5" PER HOUR).
- 9. THE AGGREGATE STORAGE LAYER SHALL BE COMPACTED IN ACCORDANCE WITH SOILS ENGINEER'S RECOMMENDA TIONS.
- 10. OVERFLOW STRUCTURE TO HAVE A MINIMUM OF 12 INCHES OF FREEBOARD.
- 11. ALL LINER INSTALLATIONS, FIELD WELDING OF SEAMS, AND OBSERVATION OF SOIL MIX PLACEMENT SHALL REQUIRE SPECIAL INSPECTION BY THE PROJECT GEOTECHNICAL ENGINEER OR OTHER QUALIFIED PERSON. A LETTER CERTIFYING PROPER INSTALLATION SHALL BE PROVIDED TO THE ENGINEER OF RECORD TO ACCEPTANCE OF THE FACILITIES.
- 12. SPECIAL INSPECTION SHALL BE REQUIRED FOR CONSTRUCTION OF ALL BIOFILTRATION BASINS. INSPECTION SHALL BE PERFORMED BY A QUALIFIED INDIVIDUAL (SUCH AS: ENGINEER OF RECORD, QSD). INSPECTION SHALL INCLUDE:
 - VERIFICATION OF OVERALL DIMENSIONS PRIOR TO PLACEMENT OF MATERIALS;
 - PLACEMENT OF THE LINER, IF REQUIRED; AND SEAMS OR PENETRATIONS • PLACEMENT OF THE GRAVEL, FILTER MATERIALS, AND FILTER MEDIA;
 - ALL INLET AND OUTLET STRUCTURES INCLUDING UNDERDRAINS. IF REQUIRED.
 - CONTRACTOR SHALL TAKE PICTURES AT EACH STAGE OF INSTALLATION AND SUBMITTED TO ENGINEER FOR VERIFICATION OF INSTALL.

INSPECTOR SHALL BE GIVEN A MINIMUM OF 48 HOURS PRIOR TO INSPECTION. UPON COMPLETION THE INSPECTOR SHALL PROVIDE A CERTIFICATION TO THE ENGINEER OF WORK.

13. PROPOSED MATERIALS, SUCH AS AGGREGATE, FILTER MATERIAL, AND FILTER MEDIA SHALL BE SUBMITTED TO THE ENGINEER OF WORK FOR APPROVAL.


SELF-MITIGATING DMAS:


• VEGETATION IN THE NATURAL OR LANDSCAPED AREA IS NATIVE AND/OR NON—NATIVE/NON—INVASIVE DROUGHT TOLERANT SPECIES THAT DO NOT REQUIRE REGULAR APPLICATION OF FERTILIZERS AND PESTICIDES.

- SOILS ARE UNDISTURBED NATIVE TOPSOIL, OR DISTURBED SOILS THAT HAVE BEEN AMENDED AND AERATED TO PROMOTE WATER RETENTION CHARACTERISTICS EQUIVALENT TO UNDISTURBED NATIVE TOPSOIL.
- THE INCIDENTAL IMPERVIOUS AREAS ARE LESS THAN 5 PERCENT OF THE SELF-MITIGATING AREA.
- IMPERVIOUS AREA WITHIN THE SELF-MITIGATED AREA SHOULD NOT BE HYDRAULICALLY CONNECTED TO OTHER IMPERVIOUS AREAS UNLESS IT IS A STORM WATER CONVEYANCE SYSTEM (SUCH AS A BROW DITCH).
- THE SELF-MITIGATING AREA IS HYDRAULICALLY SEPARATE FROM DMAS THAT CONTAIN PERMANENT STORM WATER POLLUTANT CONTROL BMPS.

HYDROLOGIC SOIL GROUP

THE HYDROLOGICAL SOIL GROUP FOR THIS SITE IS TYPE D.

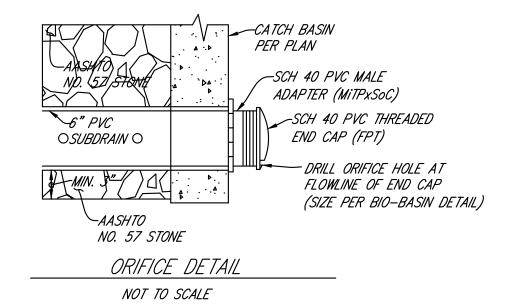

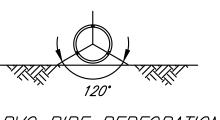

6" PVC PIPE PERFORATION LAYOUT DETAIL NOT TO SCALE

DETAIL "NO DUMPING" AT CATCH BASINS

Q: \12\12046\GPIP\GP\ndw.bm

NOTE: ALL CATCH BASINS WITH GRATES SHALL BE STENCILED WITH CITY REQUIRED ITEM PER ABOVE DETAIL:


(DAS MANUFACTURING #SDO OR EQUIVALENT)

PERMANENT WATER QUALITY TREATMENT FACILITY

WATER QUALITY SIGN- PLACED AT

MAINTAIN WITH CARE - NO MODIFICATIONS WITHOUT AGENCY APPROVAL

EACH BIOFILTRATION BASIN NOTE: ALL BIOFILTRATION AREAS WILL HAVE A SIGN POSTED TO BE VISIBLE AT ALL TIMES.

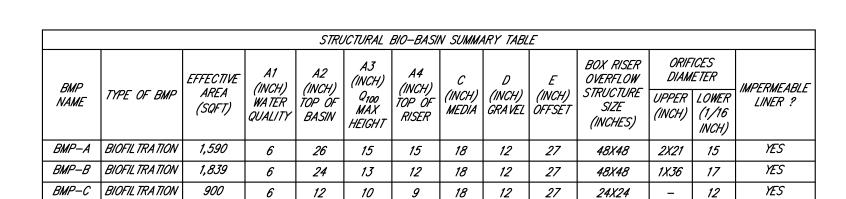

12

ENGINEER'S SEAL

54.392 SQFT

1.2487 ACRE

21,090 SQFT

PROPOSED 12" SD PIPE 0.4842 ACRES

68,949 SQFT

900 SQFT ~

.0207 ACRES

SAMS HILL ROAD (PRIVATE)


	DRAINAGE MANAGEMENT AREA									
DMA ID	DMA TYPE	MA TYPE OUTLET AREA (SQFT)		PERVIOUS AREA (SQFT)	TOTAL (SQFT)	TOTAL (ACRES)	% IMP			
DMA-1	DRAINS TO BMP	BMP-1	47,865	21,084	68,949	1.583	69			
DMA-2	DRAINS TO BMP	BMP-2	41,177	13,215	54,392	1.249	76			
DMA-3	DRAINS TO BMP	BMP-3	12,221	<i>8,869</i>	21,090	0.484	58			

54,392 SQFT

1.2487 ACRE

68,949 SQFT

1.5828 ACRES

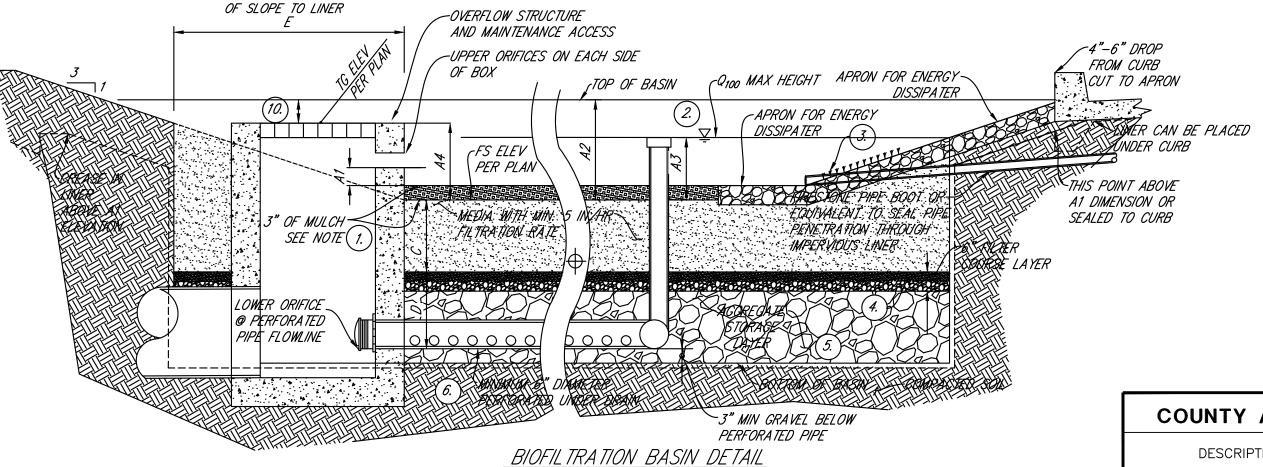

NOT TO SCALE


PREPARED BY:

KYLE KOIVUNIEMI, PE

REGISTERED ENGINEER

58449

RCE NUMBER

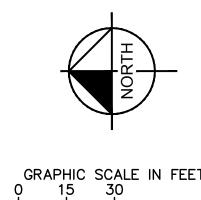

GRADING PERMIT NO:

PRIVATE CONTRACT **COUNTY APPROVED CHANGES** COUNTY OF SAN DIEGO DATE: **DESCRIPTION:** BY: DEPARTMENT OF PUBLIC WORKS GRADING PLAN FOR: DMA AND BIOFILTRATION BASIN EXHIBIT CALIFORNIA COORDINATE INDEX DIRECTOR OF PUBLIC WORKS

Call before you dig. BEFORE YOU DIG

DIAL TOLL FREE AT LEAST TWO DAYS

REV. SYMBOL

DATE DRAWN BY DATE CHECKED BY **DESCRIPTION OF CHANGE** R.C.E. DATE P.D.E. DATE

EXISTING CURB NULET

O (PVBLIC)

_EXISTING 66" SD PIPE

PROPOSED 18"

(PUBLIC)

(PUBLIC)

EXISTING DUAL 18" SD PIPES

TPUBLIC)

-1,839 SQFT

0.0422 ACRE

(PRIVATE)

-1,590 SQFT

0.0365 ACRES (PRIVATE)

DISTANCE FROM TOE

PROPÔSED, CURB C

-| PROPOSED CURB CUT

UNDERGROUND SERVICE ALERT OF SOUTHERN CALIFORNIA

SITE INFORMATION:

387-142-36-00 APN(S): LAND AREA:

GROSS AREA NET AREA ZONING:

3.4 ACRES/ 147,886.26 SF 3.36 ACRES/ 146,465.97 SF RU - RESIDENTAL URBAN

ADDRESS: 675 EAST BRADLEY AVENUE EL CAJON, CA 92021

OWNER: MR. THOMAS JURBALA EL CAJON REAL ESTATE, LLC 6 HUTTON CENTRE DRIVE, SUITE 400

SANTA ANA, CA 92707

EXISTING BUILDING 1 SKILLED NURSING DATA:

EXISITING USE: SKILLED NURSING FACILITY OCCUPANCY: I-2 (W/ DELAYED EGRESS) CONSTRUCTION TYPE: VA FIRE SPRINKLERED: YES STORIES:

±6,950 S.F.

28 BEDS

AREA:

EXISTING BEDS:

EXISTING BUILDING 2 SKILLED NURSING DATA:

PROPOSED USE: SKILLED NURSING FACILITY OCCUPANCY: I-2 (W/ DELAYED EGRESS) CONSTRUCTION TYPE: VA FIRE SPRINKLERED: YES STORIES: AREA: ±6,500 S.F.

28 BEDS

EXISTING BEDS:

NEW BUILDING 3 SKILLED NURSING DATA:

PROPOSED USE: SKILLED NURSING FACILITY OCCUPANCY: I-2 (W/ DELAYED EGRESS) CONSTRUCTION TYPE: VA FIRE SPRINKLERED: YES

STAFF: STORIES: ±11,048 S.F. AREA:

ROOM/BED COUNT: 1 BEDS (1) PRIVATE: 30 BEDS (15) SEMI PRIVATE **TOTAL BEDS:** 31 BEDS

NEW ASSISTED LIVING FACILITY DATA:

ASSISTED LIVING FACILITY PROPOSED USE: R-2.1 OCCUPANCY:

CONSTRUCTION TYPE: VA FIRE SPRINKLERED: YES STAFFS:

2 W/ BASEMENT STORIES: TOTAL AREA: ±25,675 S.F.

ROOM/BED COUNT:

42 BEDS (42) PRIVATE UNITS: 24 BEDS (12) PRIVATE UNITS: **TOTAL BEDS:** 66 BEDS


PARKING TABULATION:

REQUIRED PARKING: MEDICAL CARE FACILITIES 0.33 PER BED: 153X0.33= 50.49 TOTAL PARKING REQUIRED:

PARKING PROVIDED:

STANDARD SPACES CLEAN AIR / ELECTTRICAL VEHICLE SPACE ELECTRIC VEHICLE CHARGING SPACE ACCESSIBLE ELECTRIC VEHICLE CHARGING SPACE 2 ACCESSIBLE PARKING SPACES TOTAL PARKING PROVIDED:

TOTAL BICYCLE SPACES PROVIDED:

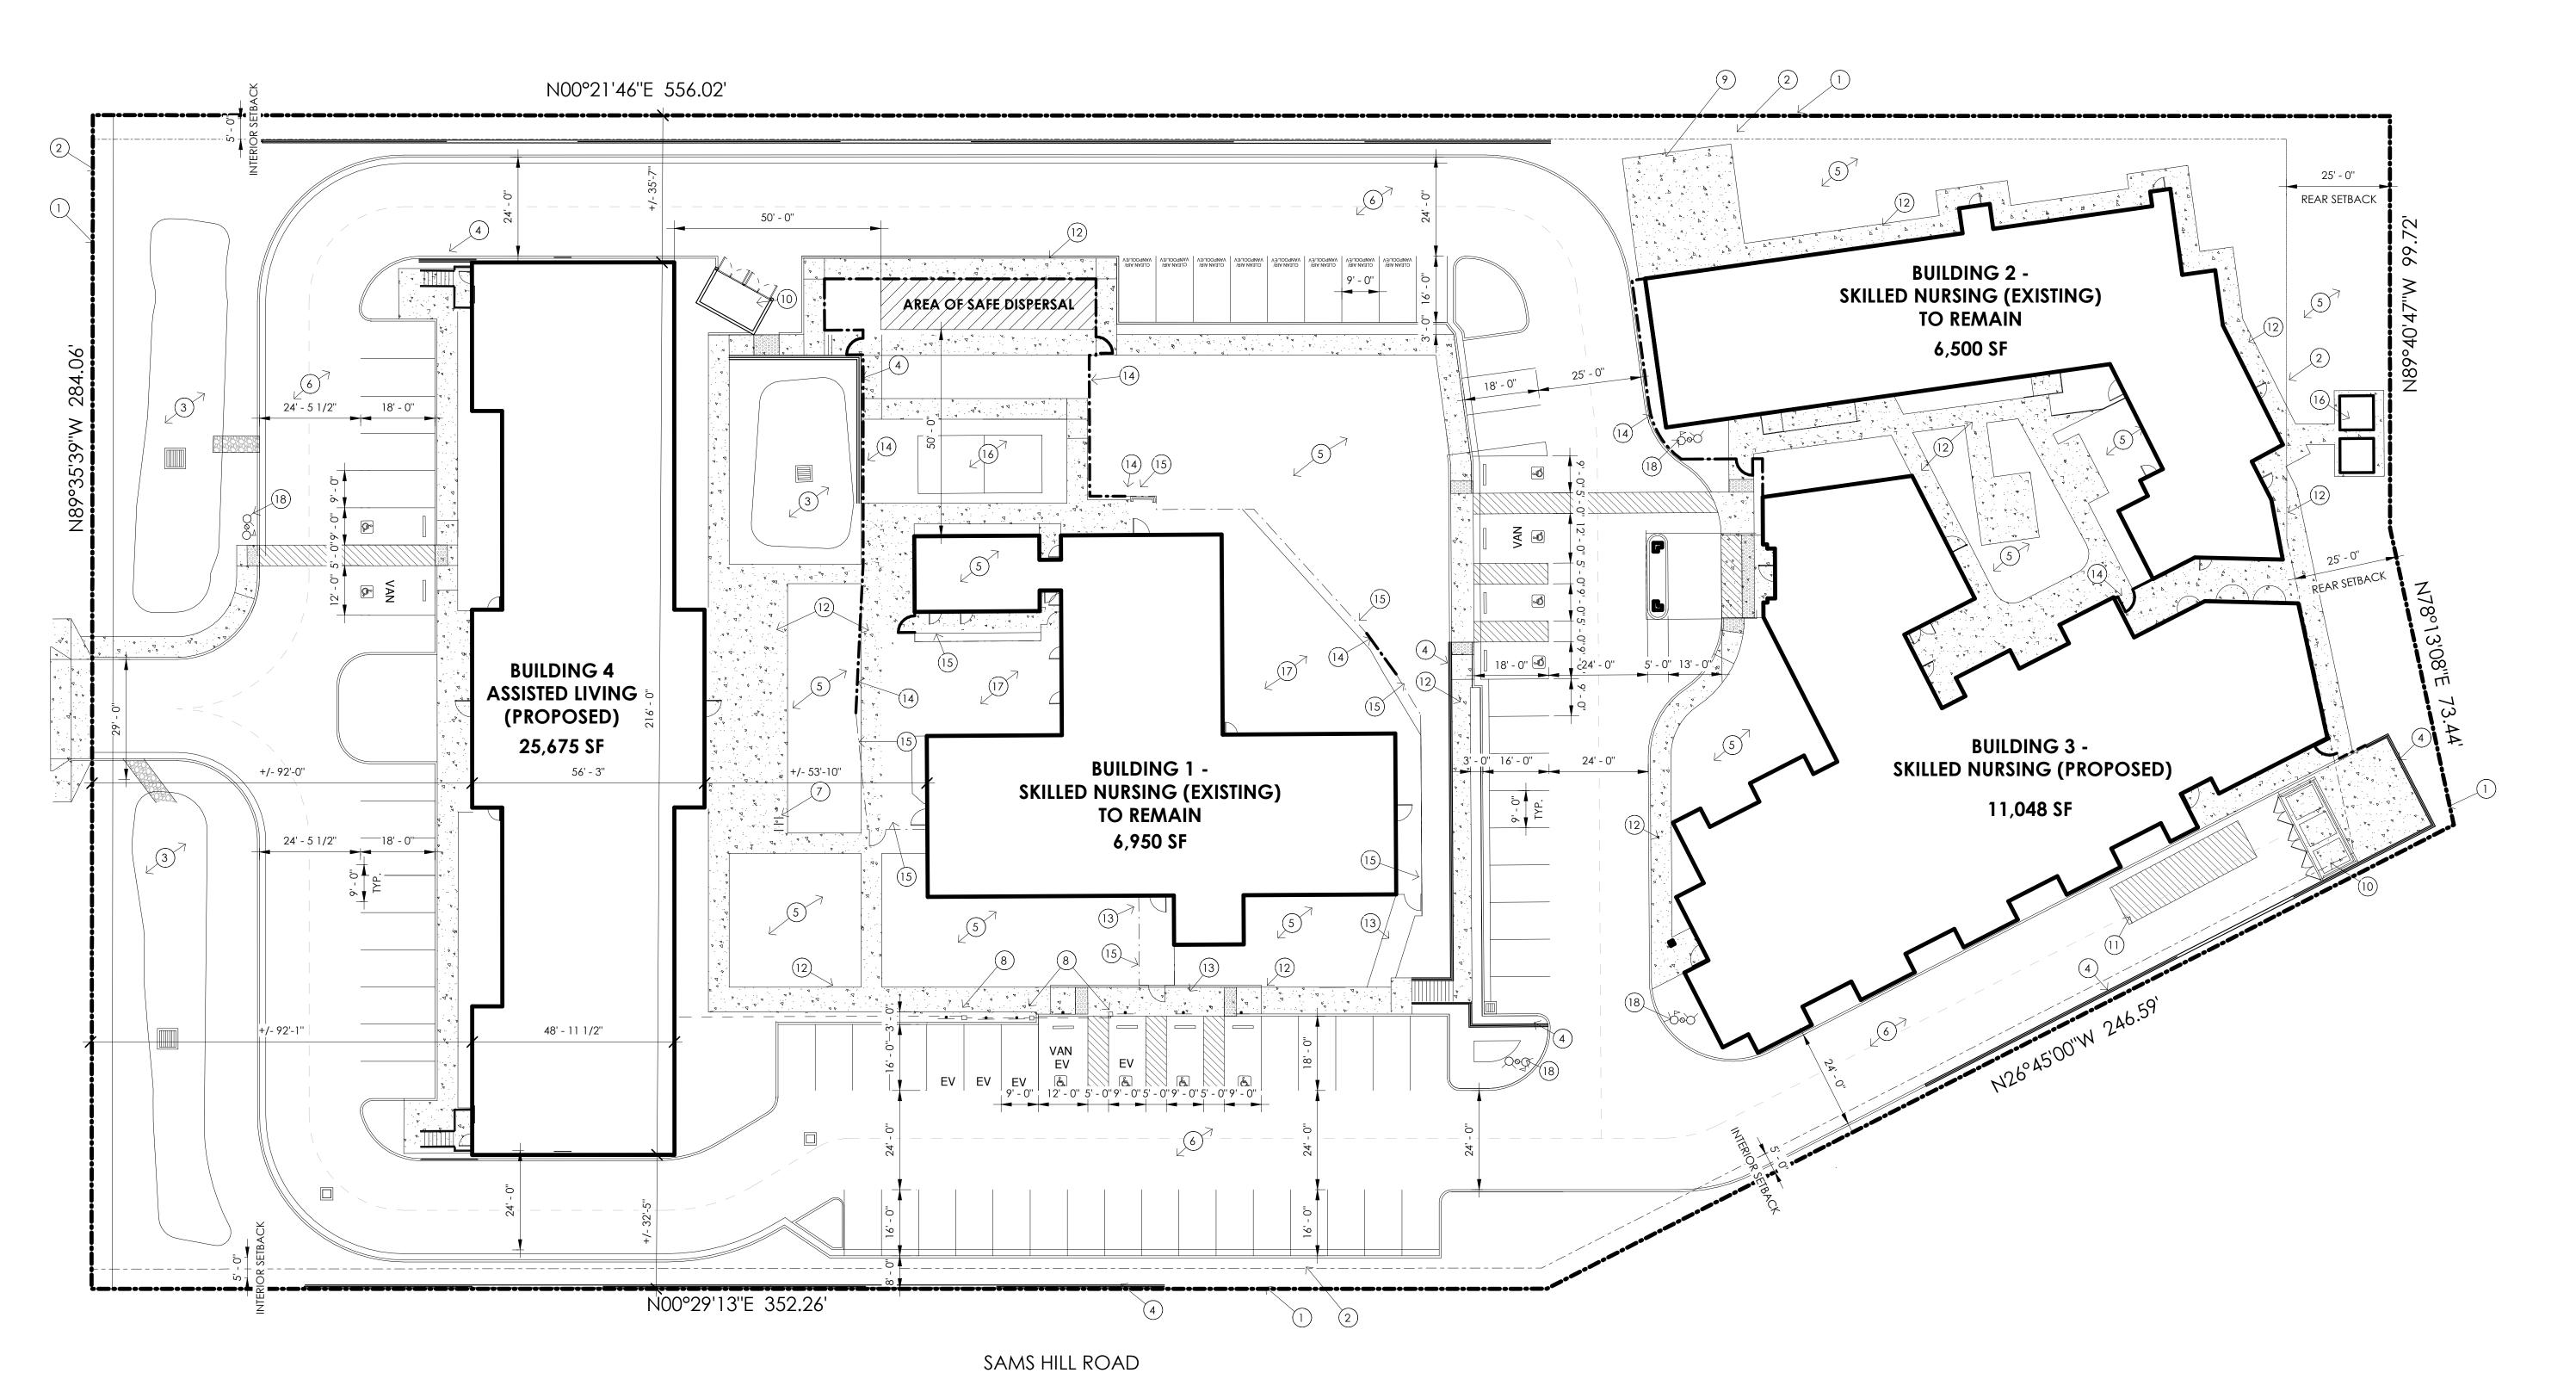

KEYNOTES

1 PROPERTY LINE

2 SETBACK

3 BIO-BASIN

4 CMU RETAINING WALL (SEE CIVIL FOR HEIGHT)

5 LANDSCAPE

6 ASPHALT PAVING

(7) BICYCLE PARKING

8 EV CHARGER AND UNDERGROUND CONDUIT

9 GENERATOR ENCLOSURE W/ 8'-0" H. SOLID GROUTED CMU W/ PLASTER FINISH TO MATCH BUILDING ADDITION

(10) COVERED TRASH ENCLOSURE PER COUNTY OF SAN DIEGO STANDARDS

10' X 35' LOADING SPACE

(12) CONCRETE SIDEWALK

(13) EXISTING CONCRETE SIDEWALK

(14) 7'-0" H. CHAIN LINK FENCE

(15) EXISTING 7'-0"H. CHAIN LINK FENCE

(16) EXISTING STORAGE SHEDS

(17) EXISTING CONCRETE PATIO

(18) FIRE APPURTENANCES

VICINITY MAP

