
### **VICINITY MAP**

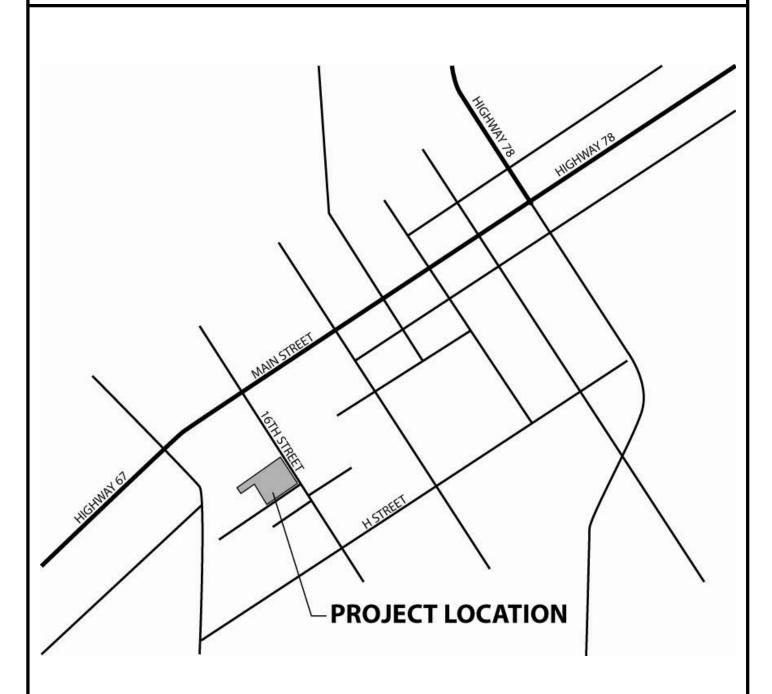

### SHEET INDEX

SHEET NAME

**BUILDING TYPE 1 - EXTERIOR ELEVATIONS** 

REFERENCIAL PLANS

TITLE SHEET **CIVIL NOTES** 

PRELIMINARY GRADING PLAN

PRELIMINARY UTILITY PLAN

CONCEPT LANDSCAPE PLAN CONCEPTUAL LIGHTING PLAN

CONCEPTUAL SITE PLAN

AS-2

GROUP USABLE OPEN SPACE PLAN & DETAILS

BUILDING TYPE A - FLOOR PLANS

**BUILDING TYPE A - EXTERIOR ELEVATIONS** A-3 **BUILDING TYPE B - FLOOR PLANS** 

BUILDING TYPE B - EXTERIOR ELEVATIONS

**BUILDING TYPE C - FLOOR PLANS** 

BUILDING TYPE C - EXTERIOR ELEVATIONS

**BUILDING TYPE D - FLOOR PLANS** 

BUILDING TYPE D - EXTERIOR ELEVATIONS **UNIT FLOOR PLANS** 

**UNIT FLOOR PLANS** 

**UNIT FLOOR PLANS** A-11

A-12 UNIT PLAN - 2A

UNIT PLAN - 2B

UNIT PLAN - 3A UNIT PLAN - 3B

A-16 UNIT PLAN - 3C

STRUCTURAL PLAN

# VILLAGE PLACE APARTMENTS

RECORD ID #: PDS2015-STP-15-026 ENVIRONMENTAL LOG #: PDS2015-ER-15-09-007 ASSESSOR'S PARCEL NUMBER: 282-261-60-00



### PROJECT TEAM

### **OWNERS**

**ROBERT A. BURCH** PO BOX 1413 RAMONA, CA 92065

760.788.0800 **WILLIAM M. VAUGHAN** 

PO BOX 1409 RAMONA, CA 92065 760.789.0825

### **ARCHITECT**

**WILDMAN & MORRIS** 405 MAPLE STREET, SUITE B-102 RAMONA, CA 92065 760.789.3305 **EDWARD GROS** 

ED.GROS@WILDMAN-MORRIS.COM

<u>CIVIL</u>

**BDS ENGINEERING, INC.** 5575 LAKE PARK WAY, SUITE 114

LA MESA, CA 91942 619.582.4992 TOM JONES

TJONES@BDSENGINEERING.COM

### **LANDSCAPE**

CHISHOLM LAND PLANNING 4424 44th STREET, SUITE 209

SAN DIEGO, CA 92115 760.745.3501

JOE CHISHOLM CHIZLAND@HOTMAIL.COM

LIGHTING

VISUAL CONCEPTS LIGHTING INC. 4655 RUFFNER ST., SUITE 220 SAN DIEGO, CA 92111 858.278.4503 KENNY PEREZ JR. KPEREZJR@VISUALCONCEPTS-INC.COM

### PROPERTY DATA

SITE ADDRESS:

521 16TH STREET, RAMONA, CA 92065

PROJECT SUMMARY

ASSESSOR'S PARCEL NUMBER:

**3.41 ACRES** 

282-261-60-00

CURRENT USE: VACANT WITH NO EXISTING STRUCTURES OR PAVING ON IT

### ZONING DESIGNATIONS

**GENERAL PLAN:** VR-24 VILLAGE RESIDENTIAL

ZONING - USE: RU-24 DU/AC URBAN RESIDENTIAL ZONING - BUILDING TYPE: K (INCLUDE MULTI-DWELLING) ZONING - OPEN SPACE: G (100SF PRIVATE/500SF GROUP) ZONING - SPECIAL AREA: B(COMMUNITY REVIEW) ZONING - SPECIAL AREA: C(AIRPORT) ZONING - SPECIAL AREA: D3(ORDINANCE 7634)

### **BICYCLE PARKING**

REQUIRED:

25 UNITS X 0.5 SPACES/UNIT = 13 SPACES

PROVIDED: BICYCLE RACK PARKING = 14 SPACES

### PROJECT DESCRIPTION

THE PROJECT CONSISTS OF APARTMENT HOUSING ON A 3.41 ACRE VACANT PROPERTY. THE PROPERTY FRONTS 16th STREET AND THE DEVELOPMENT WILL BE ACCESSED FROM 16TH STREET. SIX TWO-STORY APARTMENT BUILDINGS WILL OCCUR ON THE PROPERTY. TWO TYPE "A" BUILDINGS WILL EACH CONSIST OF 4 TWO-BEDROOM UNITS, 2 THREE-BEDROOM UNITS AND GARAGES FOR 6 PARKING SPACES. ONE TYPE "B" BUILDING WILL CONSIST OF 4 TWO-BEDROOM UNITS AND GARAGES FOR 4 PARKING SPACES. TWO TYPE "C" BUILDINGS WILL EACH CONSIST OF 2 TWO-BEDROOM UNITS, 2 THREE-BEDROOM UNITS AND GARAGES FOR 4 PARKING SPACES. ONE TYPE "D" BUILDING WILL CONSIST OF 1 THREE-BEDROOM UNIT, A GARAGE FOR 1 PARKING SPACE, A STORAGE SPACE AND A RENTAL OFFICE. THIS WILL RESULT IN 16 TWO-BEDROOM UNITS AND 9 THREE-BEDROOM UNITS FOR A TOTAL OF 25 UNITS WITH A DENSITY OF 7.3 UNITS PER ACRE.

THE COMMON GROUNDS WILL FEATURE AN OUTDOOR PICNIC AREA WITH A SHADE STRUCTURE, A CHILDREN'S PLAY AREA AND A WALKING TRAIL THAT LOOPS AROUND THE APARTMENT BUILDINGS. THERE WILL BE 25 ASSIGNED GARAGE SPACES AND 24 UNASSIGNED SURFACE SPACES FOR A TOTAL OF 49 ON-SITE PARKING SPACES.

TWO BEDROOM APARTMENT UNITS: 16 THREE BEDROOM APARTMENT UNITS: 9

TOTAL APARTMENT UNITS: 25

**HOUSING** 

DENSITY: 7.3 DWELLING UNITS PER ACRE

BUILDING TYPE A: 8,053 SQ. FT. X 2 = 16,106 SQ. FT. BUILDING TYPE A GARAGES: 1,848 SQ. FT. X 2 = 3,696 SQ. FT. BUILDING TYPE B: 5,066 SQ. FT. BUILDING TYPE B GARAGES: 1,248 SQ. FT. BUILDING C: 5,525 SQ. FT. X 2 = 11,050 SQ. FT. BUILDING C GARAGES: 1,248 SQ. FT. X 2 = 2,496 SQ. FT BUILDING D: 1,467 SQ. FT.

BUILDING D GARAGE, STORAGE & OFFICE: 1,510 SQ. FT.

TOTAL BUILDING AREA: 42,639 SQ. FT.

### **GROUP USABLE OPEN SPACE**

REQUIRED:

25 UNITS X 500 SQ. FT./UNIT = 12,500 SQ. FT.

PROVIDED:

18,084 SQ. FT. (SEE GROUP USABLE OPEN SPACE PLAN ON SHEET AS-2 FOR LOCATIONS AND TABULATION)

### PRIVATE USABLE OPEN SPACE

**REQUIRED**:

100 SQ. FT. PER UNIT

AT LEAST 100 SQ. FT. PER UNIT (SEE FLOOR PLANS ON SHEETS A-1, A-3, A-5 & A-7 FOR LOCATIONS AT UNITS OF EACH BUILDING TYPE)

### **PARKING**

### REQUIRED:

TWO BEDROOM UNITS: 16 UNITS X 1.5 SPACES/UNIT = 24 SPACES THREE BEDROOM UNITS: 9 UNITS X 2 SPACES/UNIT = 18 SPACES GUESTS: 25 UNITS X 0.2 SPACES/UNIT = 5 SPACES

TOTAL REQUIRED: 47 SPACES

### PROVIDED:

ON-SITE ASSIGNED PARKING (GARAGES) = 25 SPACES ON-SITE UNASSIGNED PARKING = 24 SPACES ON STREET = 0 SPACES

TOATAL PROVIDED: 49 SPACES

**APARTMENTS** の円

6th  $\overline{\phantom{a}}$ 52

S

Sheet No.:

**G**-

PALEONTOLOGICALLY SENSITIVE AREAS ARE THOSE IDENTIFIED AS HAVING HIGH, MODERATE, LOW OR MARGINAL POTENTIAL TO CONTAIN PALEONTOLOGICAL RESOURCES. MITIGATION INCLUDES MONITORING DURING GRADING AND/OR EXCAVATION, HOWEVER, THE MONITORING REQUIREMENT IS DIFFERENT FOR HIGH/MODERATE AND LOW/MARGINAL. ONLY THE AREAS OF NO POTENTIAL DO NOT REQUIRE MONITORING GUIDELINES FOR DETERMINING SIGNIFICANCE FOR PALEONTOLOGICAL RESOURCES ARE AT: HTTP://WWW.SDCOUNTY.CA.GOV/PDS/DOCS/PALEO-GUIDELINES.PDF.

PROJECT SPECIFIC INFORMATION: A REVIEW OF THE COUNTY'S PALEONTOLOGICAL RESOURCES POTENTIAL AND SENSITIVITY MAP AND DATA ON SAN DIEGO COUNTY'S GEOLOGIC FORMATIONS INDICATES THAT THE PROJECT IS LOCATED ON GEOLOGICAL FORMATIONS THAT POTENTIALLY CONTAIN UNIQUE PALEONTOLOGICAL RESOURCES. EXCAVATING INTO UNDISTURBED GROUND BENEATH THE SOIL HORIZONS MAY CAUSE A SIGNIFICANT IMPACT IF UNIQUE PALEONTOLOGICAL RESOURCES ARE ENCOUNTERED. THE PROJECT IS IN AN AREA RATED AS HAVING LOW POTENTIAL FOR CONTAINING UNIQUE PALEONTOLOGICAL RESOURCES.

GENERAL INFORMATION: SINCE AN IMPACT TO PALEONTOLOGICAL RESOURCES DOES NOT TYPICALLY OCCUR UNTIL THE RESOURCE IS DISTURBED, MONITORING DURING EXCAVATION IS THE ESSENTIAL MEASURE TO MITIGATE POTENTIALLY SIGNIFICANT IMPACTS TO UNIQUE PALEONTOLOGICAL RESOURCES TO A LEVEL BELOW SIGNIFICANCE. MONITORING AND COLLECTION OF PALEONTOLOGICAL RESOURCES DURING SITE EXCAVATION ENSURES THAT POTENTIALLY ADVERSE IMPACTS TO PALEONTOLOGICAL RESOURCES ARE REDUCED TO A LEVEL BELOW SIGNIFICANCE. THE TYPE OF MONITORING REQUIRED IS BASED ON THE AMOUNT OF EXCAVATION PROPOSED AND THE SITE'S POTENTIAL FOR CONTAINING UNIQUE PALEONTOLOGICAL RESOURCES. TO MITIGATE FOR THE PROJECT'S POTENTIAL IMPACT TO PALEONTOLOGICAL RESOURCES, THE PROJECT WILL BE REQUIRED TO COMPLY WITH THE FOLLOWING PROJECT CONDITION:

DRAFT GRADING PLAN NOTES:

PRIOR TO APPROVAL OF GRADING OR IMPROVEMENT PLANS. THE APPLICANT SHALL:

- A. PROVIDE EVIDENCE THAT GRADING AND/OR OTHER EXCAVATION WILL BE MONITORED FOR FOSSILS. THE PERSON RESPONSIBLE FOR FOSSIL MONITORING NEED NOT BE A QUALIFIED PALEONTOLOGIST OR A QUALIFIED PALEONTOLOGICAL RESOURCES MONITOR, AND MAY BE AN EMPLOYEE(S) OF THE GRADING CONTRACTOR, AND IN SOME CASES, MAY BE THE EQUIPMENT OPERATOR(S). EVIDENCE SHALL BE A LETTER FROM THE GRADING CONTRACTOR TO THE DIRECTOR OF PLANNING & DEVELOPMENT SERVICES STATING THE NAMES OF THOSE INDIVIDUALS THAT WILL BE RESPONSIBLE FOR MONITORING FOR FOSSILS.
- B. PROVIDE EVIDENCE TO THE DIRECTOR OF PUBLIC WORKS (DPW) THAT THE FOLLOWING NOTES HAVE BEEN PLACED ON THE GRADING PLAN:
  - 1. IF A FOSSIL OR GROUP OF FOSSILS (E.G. A SHELL BED) OF GREATER THAN TWELVE INCHES IN ANY DIMENSION (INCLUDING CIRCUMFERENCE) IS ENCOUNTERED BENEATH THE SOIL LÀYERS (MEANING THAT IT IS' NOT ARCHAEOLOGICAL) DURING GRADING OR OTHER EXCAVATION:
  - a. ALL EARTHMOVING OPERATIONS IN THE AREA WHERE THE FOSSIL WAS FOUND SHALL BE SUSPENDED IMMEDIATELY;
  - b. THE COUNTY'S PERMIT COMPLIANCE COORDINATOR SHALL BE NOTIFIED:
  - c. THE APPLICANT SHALL CONTRACT WITH A QUALIFIED PALEONTOLOGIST TO EVALUATE THE SIGNIFICANCE OF THE FOSSIL. A QUALIFIED PALEONTOLOGIST IS A PERSON WITH A PH.D. OR MASTER'S DEGREE IN PALEONTOLOGY OR A RELATED FIELD, AND WHO HAS KNOWLEDGE OF SAN DIEGO COUNTY PALEONTOLOGY AND DOCUMENTED EXPERIENCE IN PROFESSIONAL PALEONTOLOGICAL PROCEDURES AND TECHNIQUES.
  - d. VERIFICATION OF THE CONTRACT SHALL BE PRESENTED IN A LETTER FROM THE QUALIFIED PALEONTOLOGIST TO THE DIRECTOR OF PLANNING & DEVELOPMENT SERVICES STATING THAT HE/SHE HAS BEEN CONTRACTED TO DETERMINE IF THE FOUND FOSSIL IS SIGNIFICANT. IF THE FOSSIL IS SIGNIFICANT, THE QUALIFIED PALEONTOLOGIST SHALL:
  - o SALVAGE UNEARTHED FOSSIL REMAINS, INCLUDING SIMPLE EXCAVATION OF EXPOSED SPECIMENS OR, IF NECESSARY, PLASTER-JACKETING OF LARGE AND/OR FRAGILE SPECIMENS OR MORE ELABORATE QUARRY EXCAVATIONS OF RICHLY FOSSILIFEROUS DEPOSITS:
  - o IN THE FIELD, RECORD STRATIGRAPHIC AND GEOLOGIC DATA TO PROVIDE A CONTEXT FOR THE RECOVERED FOSSIL REMAINS, TYPICALLY INCLUDING A DETAILED DESCRIPTION OF ALL PALEONTOLOGICAL LOCALITIES WITHIN THE PROJECT SITE, AS WELL AS THE LITHOLOGY OF FOSSIL-BEARING STRATA WITHIN THE MEASURED STRATIGRAPHIC SECTION, IF FEASIBLE, AND PHOTOGRAPHIC DOCUMENTATION OF THE GEOLOGIC SETTING:
  - e. GRADING AND EXCAVATION CAN RESUME EITHER WHEN THE QUALIFIED PALEONTOLOGIST DETERMINES THAT THE FIND IS NOT SIGNIFICANT OR AFTER THE FOSSIL HAS BEEN REMOVED AND THE ASSOCIATED DATA COLLECTED.
- C. PRIOR TO ROUGH GRADING INSPECTION SIGN-OFF PROVIDE EVIDENCE THAT MONITORING FOR FOSSILS HAS BEEN COMPLETED. EVIDENCE SHALL BE IN THE FORM OF A LETTER FROM THE GRADING CONTRACTOR TO TE DIRECTOR OF PLANNING & DEVELOPMENT SERVICES. [PDS, FEE].

### PRELIMINARY PROJECT CONDITIONS RELATED TO PALEONTOLOGICAL RESOURCES CONTINUED

PRIOR TO FINAL GRADING RELEASE:

- 1. IF NO PALEONTOLOGICAL RESOURCES WERE DISCOVERED, SUBMIT A "NO FOSSILS FOUND" LETTER FROM THE GRADING CONTRACTOR TO THE DIRECTOR OF PLANNING & DEVELOPMENT SERVICES STATING THAT THE MONITORING HAS BEEN COMPLETED AND THAT NO FOSSILS WERE DISCOVERED. AND INCLUDING THE NAMES AND SIGNATURES FROM THE FOSSIL MONITORS. THE LETTER SHALL BE IN THE FORMAT OF ATTACHMENT E OF THE COUNTY OF SAN DIEGO GUIDELINES FOR DETERMINING SIGNIFICANCE FOR PALEONTOLOGICAL RESOURCES. [PDS FEE]
- 2. IF PALEONTOLOGICAL RESOURCES WERE DISCOVERED AND SALVAGED, THE FOLLOWING TASKS SHALL BE COMPLETED BY OR UNDER THE SUPERVISION OF A QUALIFIED PALEONTOLOGIST:
- a. PREPARE COLLECTED FOSSIL REMAINS FOR CURATION, TO INCLUDE CLEANING THE FOSSILS BY REMOVING THE ENCLOSING ROCK MATERIAL. STABILIZING FRAGILE SPECIMENS USING GLUES AND OTHER HARDENERS, IF NECESSARY, AND REPAIRING BROKEN SPECIMENS;
- b. CURATE, CATALOG AND IDENTIFY ALL FOSSIL REMAINS TO THE LOWEST TAXON POSSIBLE, INVENTORY SPECIMENS, ASSIGNING CATALOG NUMBERS, AND ENTER THE APPROPRIATE SPECIMEN AND LOCALITY DATA INTO AN COLLECTION DATABASE:
- c. TRANSFER THE CATALOGED FOSSIL REMAINS AND COPIES OF RELEVANT FIELD NOTES, MAPS, STRATIGRAPHIC SECTIONS, AND PHOTOGRAPHS TO AN ACCREDITED INSTITUTION FOR ARCHIVAL STORAGE AND/OR DISPLAY, PREFERABLY:
- O SAN DIEGO NATURAL HISTORY MUSEUM, PHYSICAL ADDRESS: 1788 EL PRADO, SAN DIEGO, CA 92101; MAILING ADDRESS: P.O. BOX 121390, SAN DIEGO, CA 92112-1390, (619) 232-3821
- O NATURAL HISTORY MUSEUM OF LOS ANGELES COUNTY, 900 EXPOSITION BOULEVARD, LOS ANGELES, CA 90007, (213) 763-DINO
- O SAN BERNARDINO MUSEUM OF NATURAL HISTORY, 2024 ORANGE TREE LANE, REDLANDS, CALIFORNIA 92374, (909) 307-2669
- O UNIVERSITY OF CALIFORNIA MUSEUM OF PALEONTOLOGY, BERKELEY, 1101 VALLEY LIFE SCIENCES BUILDING, BERKELEY, CA 94720-4780, (510)
- O ANZA-BORREGO DESERT STATE PARK, 200 PALM CANYON DRIVE, BORREGO SPRINGS, CA 92004, (760) 767-5311

### PRELIMINARY PROJECT CONDITIONS RELATED TO PALEONTOLOGICAL RESOURCES CONTINUED

- d. PREPARE A FINAL PALEONTOLOGICAL RESOURCES MITIGATION PROGRAM REPORT SUMMARIZING THE FIELD AND TABORATORY METHODS USED, THE STRATIGRAPHIC UNITS INSPECTED, THE TYPES OF FOSSILS RECOVERED, AND THE SIGNIFICANCE OF THE CURATED COLLECTION.
- e. SUBMIT A DETAILED REPORT PREPARED BY THE QUALIFIED PALEONTOLOGIST IN THE FORMAT PROVIDED IN APPENDIX \* OF THE GUIDELINES FOR DETERMINING SIGNIFICANCE FOR PALEONTOLOGICAL RESOURCES AND DOCUMENTING CURATION OF THE COLLECTED FOSSILS AND IDENTIFYING WHICH ACCREDITED INSTITUTION HAS AGREED TO ACCEPT THE CURATED FOSSILS:
- f. SUBMITTING TWO HARD COPIES OF THE FINAL PALEONTOLOGICAL RESOURCES MITIGATION REPORT TO THE DIRECTOR OF PDS FOR FINAL APPROVAL OF THE MITIGATION, AND SUBMIT AN ELECTRONIC COPY OF THE COMPLETE REPORT IN MICROSOFT WORD ON A CD. SUBMIT ONE COPY OF THE REPORT TO THE SAN DIEGO NATURAL HISTORY MUSEUM AND ONE COPY TO THE INSTITUTION THAT RECEIVED THE FOSSILS. [PDS FEE]
- a. SUBMIT PROOF OF TRANSFER OF PALEONTOLOGICAL RESOURCES. IN THE FORM OF A LETTER, FROM THE DIRECTOR OF THE PALEONTOLOGY DEPARTMENT OF THE ACCREDITED INSTITUTION TO THE DIRECTOR OF PDS VERIFYING THAT THE CURATED FOSSILS FROM THE PROJECT SITE HAVE BEEN <u>RECEIVED</u> BY THE INSTITUTION. [PDS FEE]

- UNDERGROUND UTILITIES AS SHOWN ARE FROM AVAILABLE UNDERGROUND UTILITIES AS SHOWN ARE FROM AVAILABLE DRAWINGS SUPPLEMENTED BY OBSERVED ALIGNMENTS WITH SURFACE MANHOLES, VALVES, ETC. CONTRACTOR TO VERIFY EXACT LOCATION, DEPTH AND SIZE OF UNDERGROUND UTILITIES PRIOR TO CONSTRUCTION. SURFACE ITEMS SHOWN ARE FROM AERIAL TOPOGRAPHY, COMPLETED BY SAN-LO AERIAL SURVEYS JULY 25, 2013. ANY OBSERVED VARIATIONS FROM PLANS OR UTILITIES THAT ARE FOUND WHICH ARE NOT SHOWN ON PLANS SHOULD BE BROUGHT TO THE IMMEDIATE ATTENTION OF THE PROJECT MANAGER AND ENGINEER OF WORK.
- CONTRACTOR SHALL BE RESPONSIBLE FOR ANY MONUMENTATION AND/ OR BENCHMARKS WHICH WILL BE DISTURBED OR DESTROYED BY CONSTRUCTION. SUCH POINTS SHALL BE REFERENCED AND REPLACED WITH APPROPRIATE MONUMENTATION BY A LICENSED LAND SURVEYOR OR A REGISTERED CIVIL ENGINEER AUTHORIZED TO PRACTICE LAND SURVEYING. A CORNER RECORD OR RECORD OF SURVEY, AS APPROPRIATE, SHALL BE FILED BY A LICENSED LAND SURVEYOR OR REGISTERED CIVIL ENGINEER AS REQUIRED BY THE LAND SURVEYOR'S ACT.
- 3. A BOUNDARY SURVEY WAS NOT PERFORMED.

### **ABBREVIATIONS**

ASPHALT CONCRETE CB CATCH BASIN CENTERLINE CONC CONCRETE DIAMETER FINISH FLOOR FIRE HYDRANT FLOW LINE FINISH SURFACE GATE VALVE WATER INVERT ELEVATION PROPERTY LINE RCP

REINFORCE CONCRETE PIPE **RPBP** REDUCED PRESSURE BACKFLOW PREVENTOR

SCO SEWER CLEANOUT SD STORM DRAIN STORM DRAIN MANHOLE SFWFR SEWER MANHOLE

TOP OF CURB TOP OF FOOTING TOP OF GRATE TW TOP OF WALL **TYPICAL** WITH WATER

WIDTH PER PLAN WIDTH PER PLAN WIDTH PER PLAN TOP OF POND ELEVATION, AS BOTTOM OF POND INDICATED ON PLANS -ELEVATION, AS — ORIFICE AND TOP OF GRATE INDICATED ON PLANS -ELEVATIONS, AS INDICATED ON PLANS — PLANTING PER LANDSCAPING PLANS —— 4" MIN. \*\*\* 3" MULCH (SEE LANDSCAPING) 18" PLANTING MIX (SEE LANDSCAPING) 4" WASHED PEA GRAVEL 15" MIN. 3" OPEN GRADED WASHED ROCK 20" SELECT GRANULAR BACKFILL 6" PERFORATED STORM DRAIN LINE WITH 1-1/2"ø ORIFICE

A BIO-FILTRATION WITH PARTIAL RETENTION - SECTION A-A

2

6th

2


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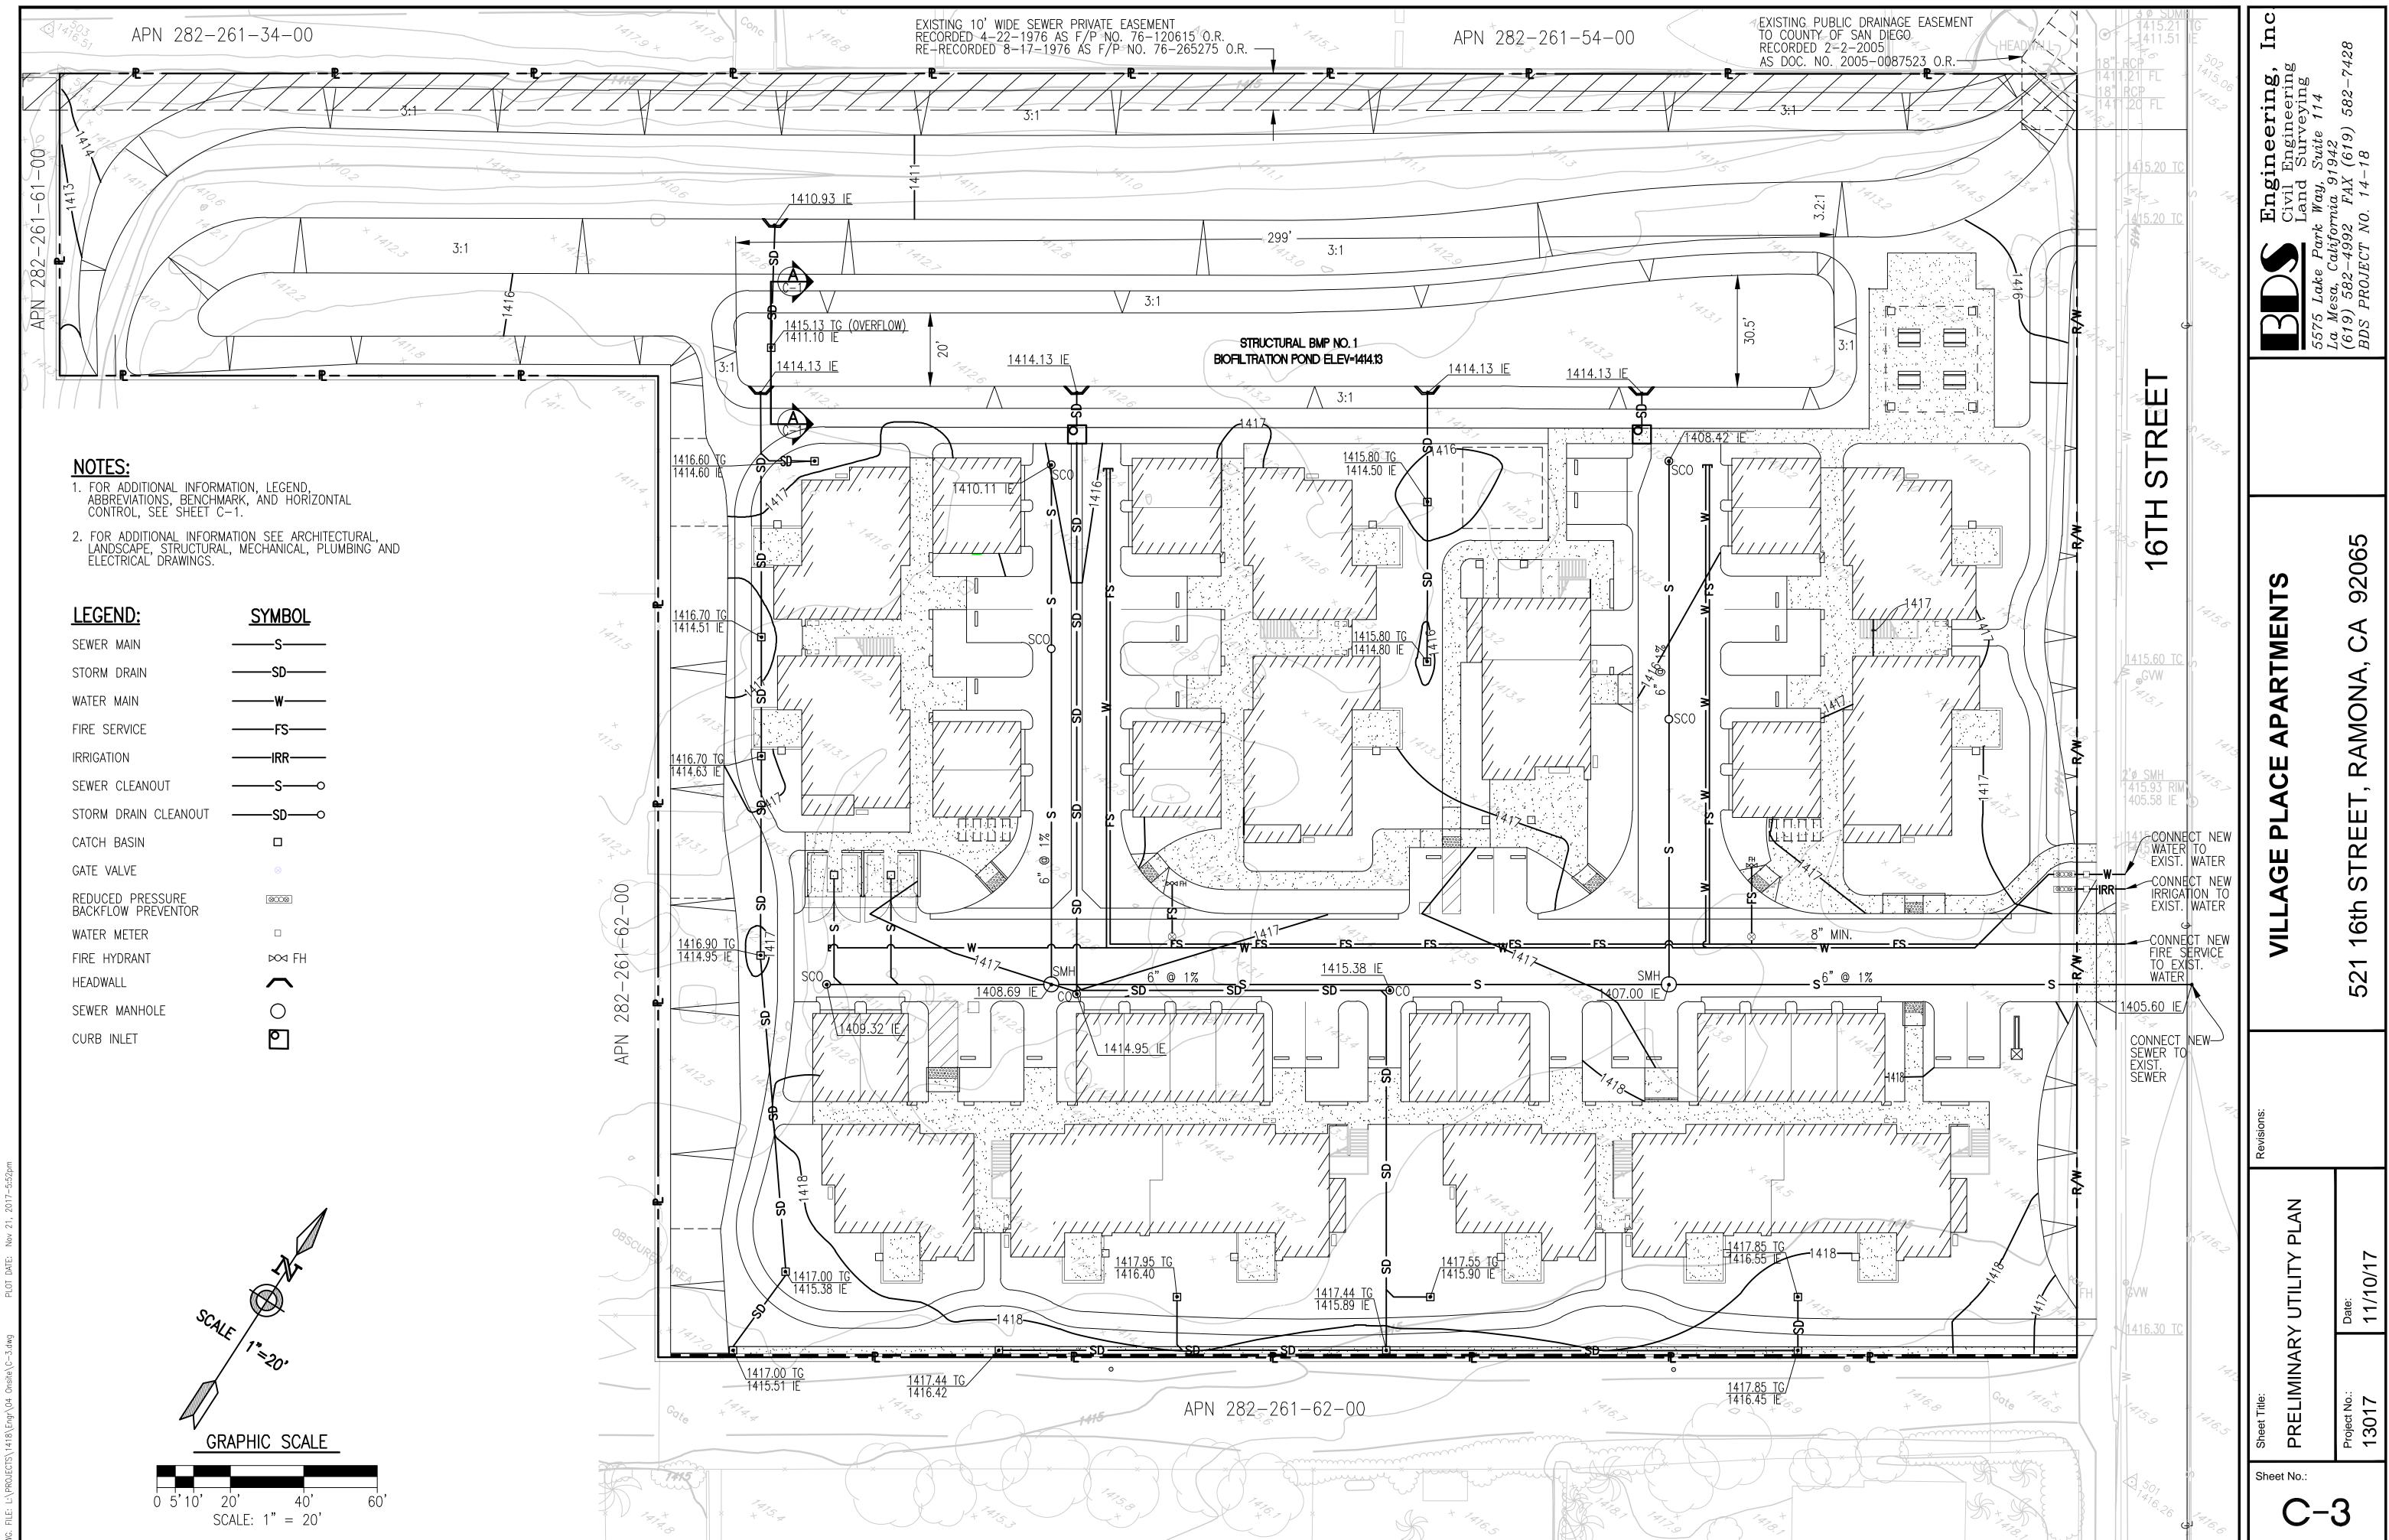
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HARDSCAPE, PAVEMENT, OR CURB SHALL BE PLANTED WITH ROOT

7. STREET TREES LOCATED WITHIN THE PUBLIC RIGHT OF WAY WILL OBTAIN AN ENCROACHMENT FROM THE DEPT. OF PUBLIC WORKS. 8. ALL PLANTINGS AND IRRIGATION EQUIPMENT SHOWN INC. WITHIN

THE DEDICATED RIGHT OF WAY SHALL BE MAINTAINED BY THE PROPERTY OWNER. 9. THE PROJECT COMMON AREA SHALL RECIEVE 3" OF DECOMPOSED

GRANITE (D.G.) MULCH. 10.ALL SOILS WILL BE FERTILIZED, AMENDED, AND TILLED TO

CONFORM WITH RECOMMENDATIONS MADE BY A SOILS TESTING LABORATORY. 11.ALL PLANTED AND MULCHED AREAS WILL BE MAINTAINED IN A

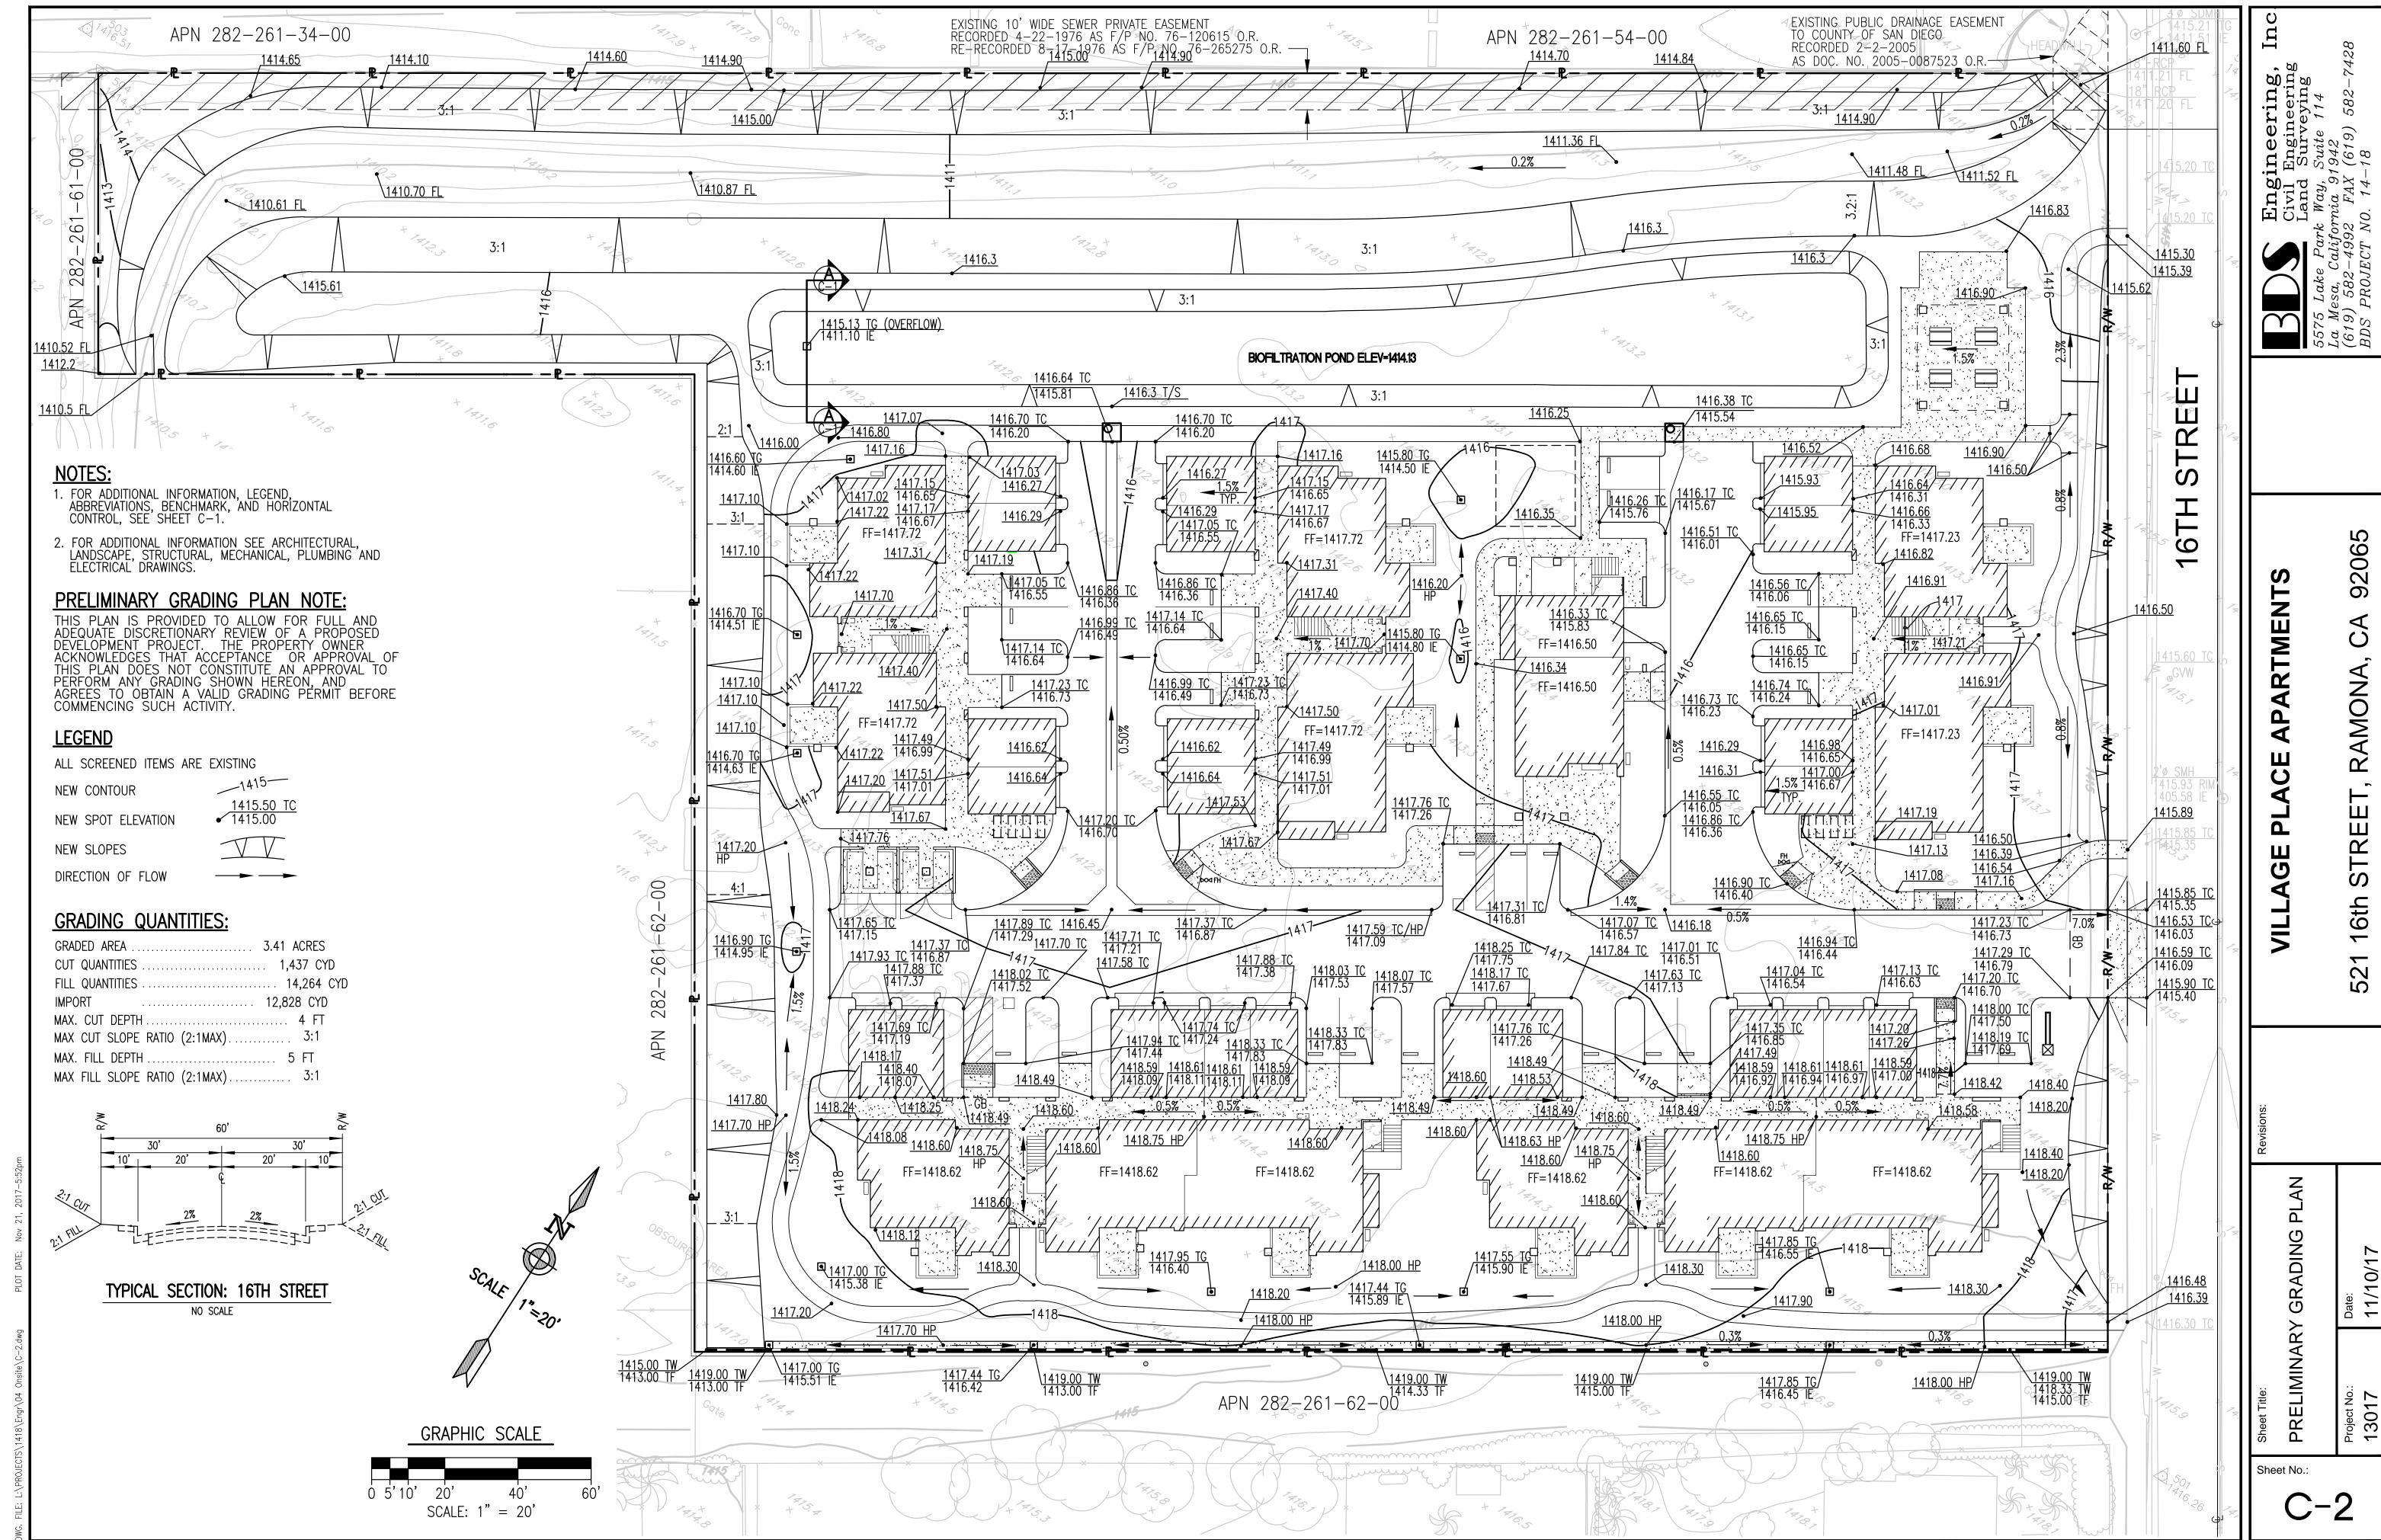WEED AND DEBRIS FREE CONDITION BY THE PROPERTY OWNER. 12.ALL LANDSCAPE AREAS SHALL PROVIDE FOR POSITIVE DRAINAGE. 13. SEE CIVIL GRADING PLAN FOR ALL FINISHED ELEVATIONS AND STORMWATER DESIGN DETAILS.

14.SEE ARCHITECTURAL SITE PLAN FOR SIGNAGE DETAILS. 15.EXISTING TREES TO BE RETAINED/REMOVED - SEE LEGEND

# Plant Materials List

**BOTANICAL NAME** COMMON NAME SIZE 24" BOX STREET TREE **MUSEUM PALO VERDE** PARKSONIA x 'DESERT MUSEUM' **AUSTRALIAN WILLOW** GEIJERA PARVIFLORA PARKING LOT TREE 24" BOX AUSTRALIAN WILLOW BUFFER/ SCREENING PLANTS 15 GAL/5 GAL CATALINA CHERRY PRUNUS ILICIFOLIA 'LYONNI' PODOCARPUS MACROPHYLUS 'MAKI' YEW PINE HETERONOMELES ARBUTIFOLIA TOYON DRY RIVERBED/THEME ELEMENT 15 GAL/5 GAL DESERT SPOON, SOTOL DASYLIRION WHEELERI **NOLINA PARRYI** BEARGRASS SOFT LEAF YUCCA YUCCA RECURVIFOLIA CHONDROPETALUM TECTORUM **SMALL CAPE RUSH** ORNAMENTALS/ SHRUBS 5 GAL SANTOLINA CHAMAECYPARRISUS LAVENDER COTTON **CLEVELAND SAGE** SALVIA CLEVELANDI ARTICHOKE AGAVE AGAVE PARRYI 'TRUNCATA' EUPHORBIA CHARACIAS 'WULFENII' CORAL ALOE ALOE STRIATA

**GRIVILLEA 'NOELLII'** CEANOTHUS 'JOYCE COULTER' CALLISTEMON 'LITTLE JOHN' SCREENS/HEDGES/ ESPALLIERS 5 GAL/15 GAL

1 GAL/5 GAL

**BRITTLEBRUSH** 

SCREENING SHRUBS 3'+ HIGH @ PROJECT EDGE


PLANTED 3' TO 5' ON CENTER (TYP.)

**ENCELIA FARINOSA** 

PODOCARPUS MACROPHYLUS 'MAKI' CALLIANDRA HAEMATOCEPHALA PINK POWDER PUFF PLUMBAGO AURICULATA CAPE PLUMBAGO

CREEKSIDE/ BIO-RETENTION AREAS LINER/1 GAL **MUHLENBERGIA RIGENS DEERGRASS** 

PINK MUHLY MUHLENBERGIA CAPILARIS LEYNUS CONDENSATUS 'CANYON PRINCE' GIANT WILD RYE HYDROSEED CUSTOM NATIVE GRASS/ MEADOW SEED MIX @ CHANNEL/ DETENTION AREA

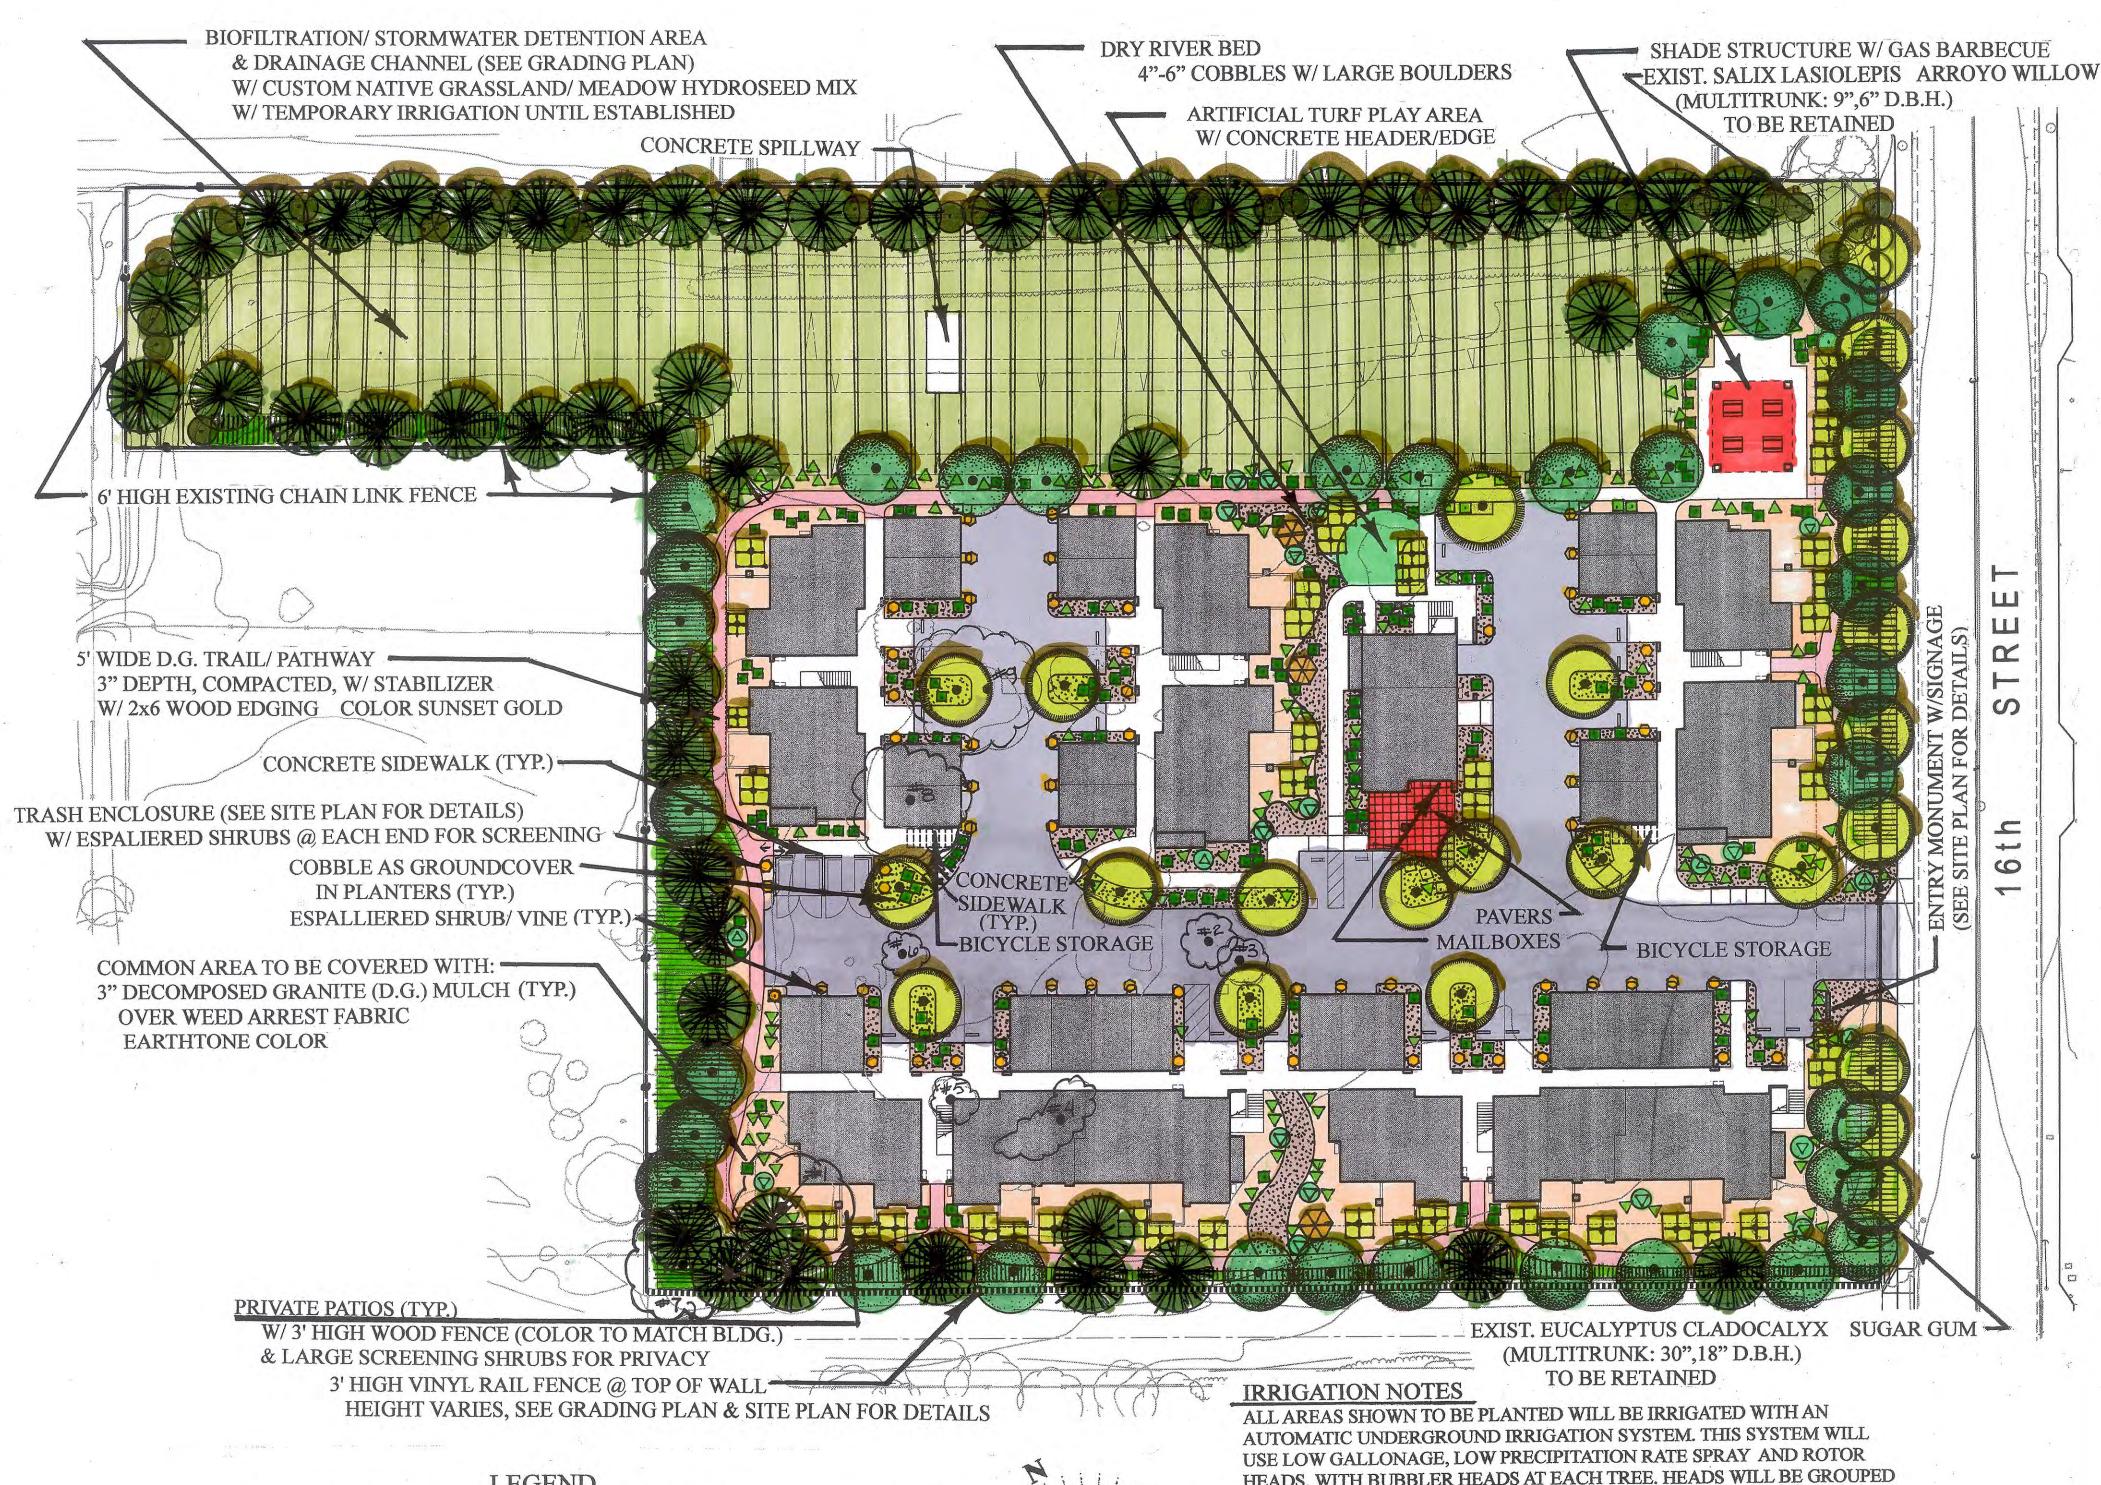

LEGEND

3' HIGH VINYL RAIL FENCE @ TOP OF WALL 3' TO 6' RETAINING WALL SEE GRADING PLAN EXISTING TREE TO BE REMOVED (SEE BELOW)

EXISTING TREES TO BE REMOVED

DESCRIPTION #1 MULTITRUNK: 10",8",6",6" D.B.H\*. OLEA EUROPA OLIVE #2 MULTITRUNK: 12",10",8" D.B.H. PINUS PINEA STONE PINE

#3 MULTITRUNK: 18",8",10",8" D.B.H. SCHINUS MOLLE CA. PEPPER

#4 MULTITRUNK: 6",11",9" D.B.H. PINUS PINEA STONE PINE #5 MULTITRUNK: 9",6" D.B.H. JUNIPERUS CALIFORNICA JUNIPER

7" D.B.H. EUCALYPYUS CLADOCALYX SUGAR GUM #7 MULTITRUNK: 9",8",6" D.B.H. SCHINUS MOLLE CA. PEPPER

#8 MULTITRUNK: 25",18" D.B.H. EUCALYPTUS CLADOCALYX #9 MULTITRUNK: 15",11",7" D.B.H. EUCALYPTUS CLADOCALYX

\*D.B.H. - TREE DIAMETER MEASURED @ BREAST HEIGHT(TYP.)

EXIST. EUCALYPTUS CLADOCALYX SUGAR GUM (MULTITRUNK: 30",18" D.B.H.)

TO BE RETAINED

ALL AREAS SHOWN TO BE PLANTED WILL BE IRRIGATED WITH AN AUTOMATIC UNDERGROUND IRRIGATION SYSTEM. THIS SYSTEM WILL USE LOW GALLONAGE, LOW PRECIPITATION RATE SPRAY AND ROTOR HEADS, WITH BUBBLER HEADS AT EACH TREE. HEADS WILL BE GROUPED INTO ZONES BASED ON EXPOSURE AND PLANT TYPES. AUTOMATIC VALVES WILL CONTROL THE FLOW OF WATER TO EACH ZONE. INDIVIDUAL HEADS WILL BE ADJUSTED TO MINIMIZE OVERSPRAY ONTO BUILDINGS, WALKS, BROW DITCHES AND DRIVEWAYS. A SMART CONTROLLER, WITH A RAIN SENSING DEVICE WILL BE PROVIDED. THE SYSTEM WILL BE DESIGNED TO MEET THE REQUIREMENTS OF THE COUNTY WATER EFFICIENT LANDSCAPE DESIGN MANUAL. A LANDSCAPE DOCUMENTATION PACKAGE WILL BE SUBMITTED ALONG WITH FINAL LANDSCAPE CONSTRUCTION DRAWINGS FOR THE PROJECT.

STATEMENT OF COMPLIANCE PER SECTION 86.709(b.9) OF THE COUNTY LANDSCAPE ORDINANCE: I AM FAMILIAR WITH THE REQUIREMENTS FOR LANDSCAPE AND IRRIGATION PLANS CONTAINED IN THE COUNTY LANDSCAPE WATER CONSERVATION REGULATIONS, IN TITLE 8, DIVISION 6, CHAPTER 7. I HAVE PREPARED THIS PLAN IN COMPLIANCE WITH THOSE REGULATIONS TO PROVIDE THE EFFICIENT USE OF WATER.


JOE CHISHOLM, DATE APRIL 22ND, 2017 RLA 1774 (EXPIRES 4-30-2019) CHISHOLM LAND PLANNING



Joe Chisholm, A.S.L.A. CA License No. 1774


TO BE RETAINED

SCALE: 1" = 30'

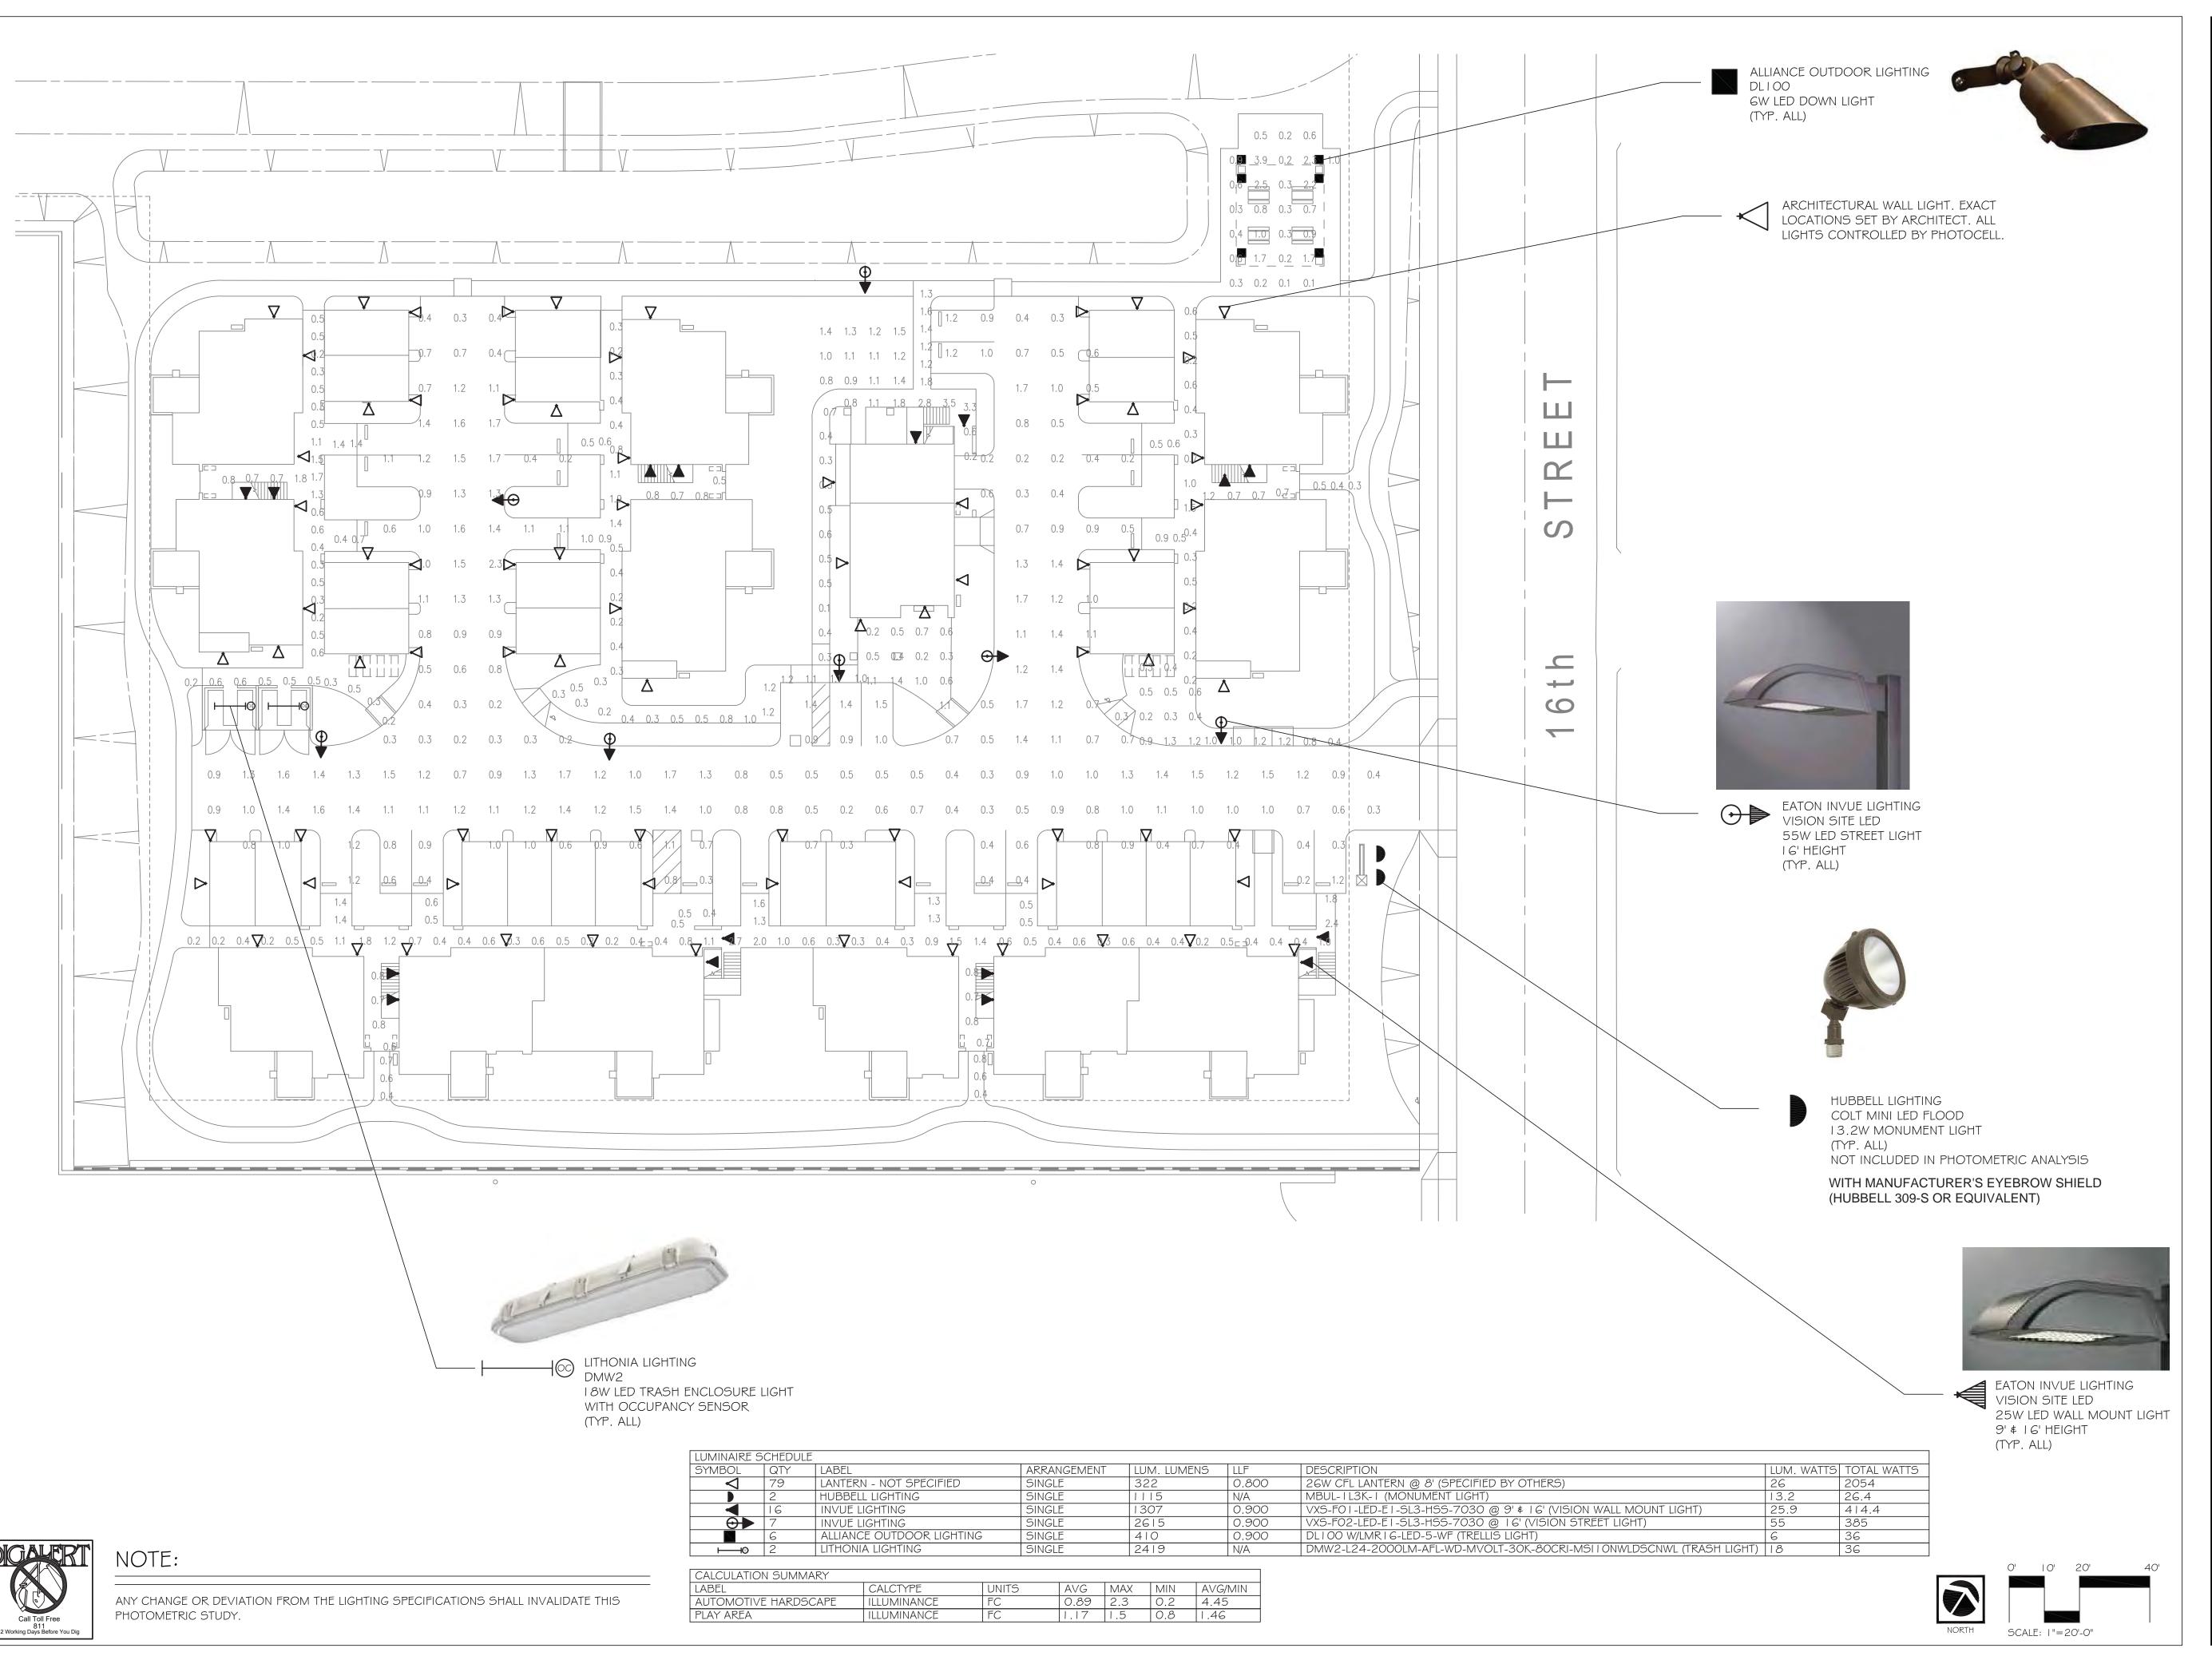

VILLAGE PLACE APARTMENTS

R.A. BURCH CONSTRUCTIC 405 MAPLE ST.

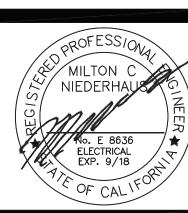

Revisions:

Sheet Info:

Date: 11/10/17 05/15/17

Job No.: RAB | 7/0502 |

Sheet Title:
CONCEPTUAL
LIGHTING PLAN

Sheet Reference:


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BUILDING TYPE SCHEDULE		
TYPE	QUANTITY	FLOOR PLAN REFERENCE
A	2	SHEET A-1
В	1	SHEET A-3
С	2	SHEET A-5
D	1	SHEET A-7

### CONDENSER LEGEND

- (A) GROUND MOUNTED CONDENSER (MITSUIBISHI T119D-H236)
- (B) GROUND MOUNTED CONDENSER (MITSUIBISHI T121Q-H263)
- © BALCONY DECK MOUNTED CONDENSER (MITSUIBISHI T119D-H236)
- (D) BALCONY DECK MOUNTED CONDENSER (MITSUIBISHI T121Q-H263)



### CONCEPTUAL SITE PLAN

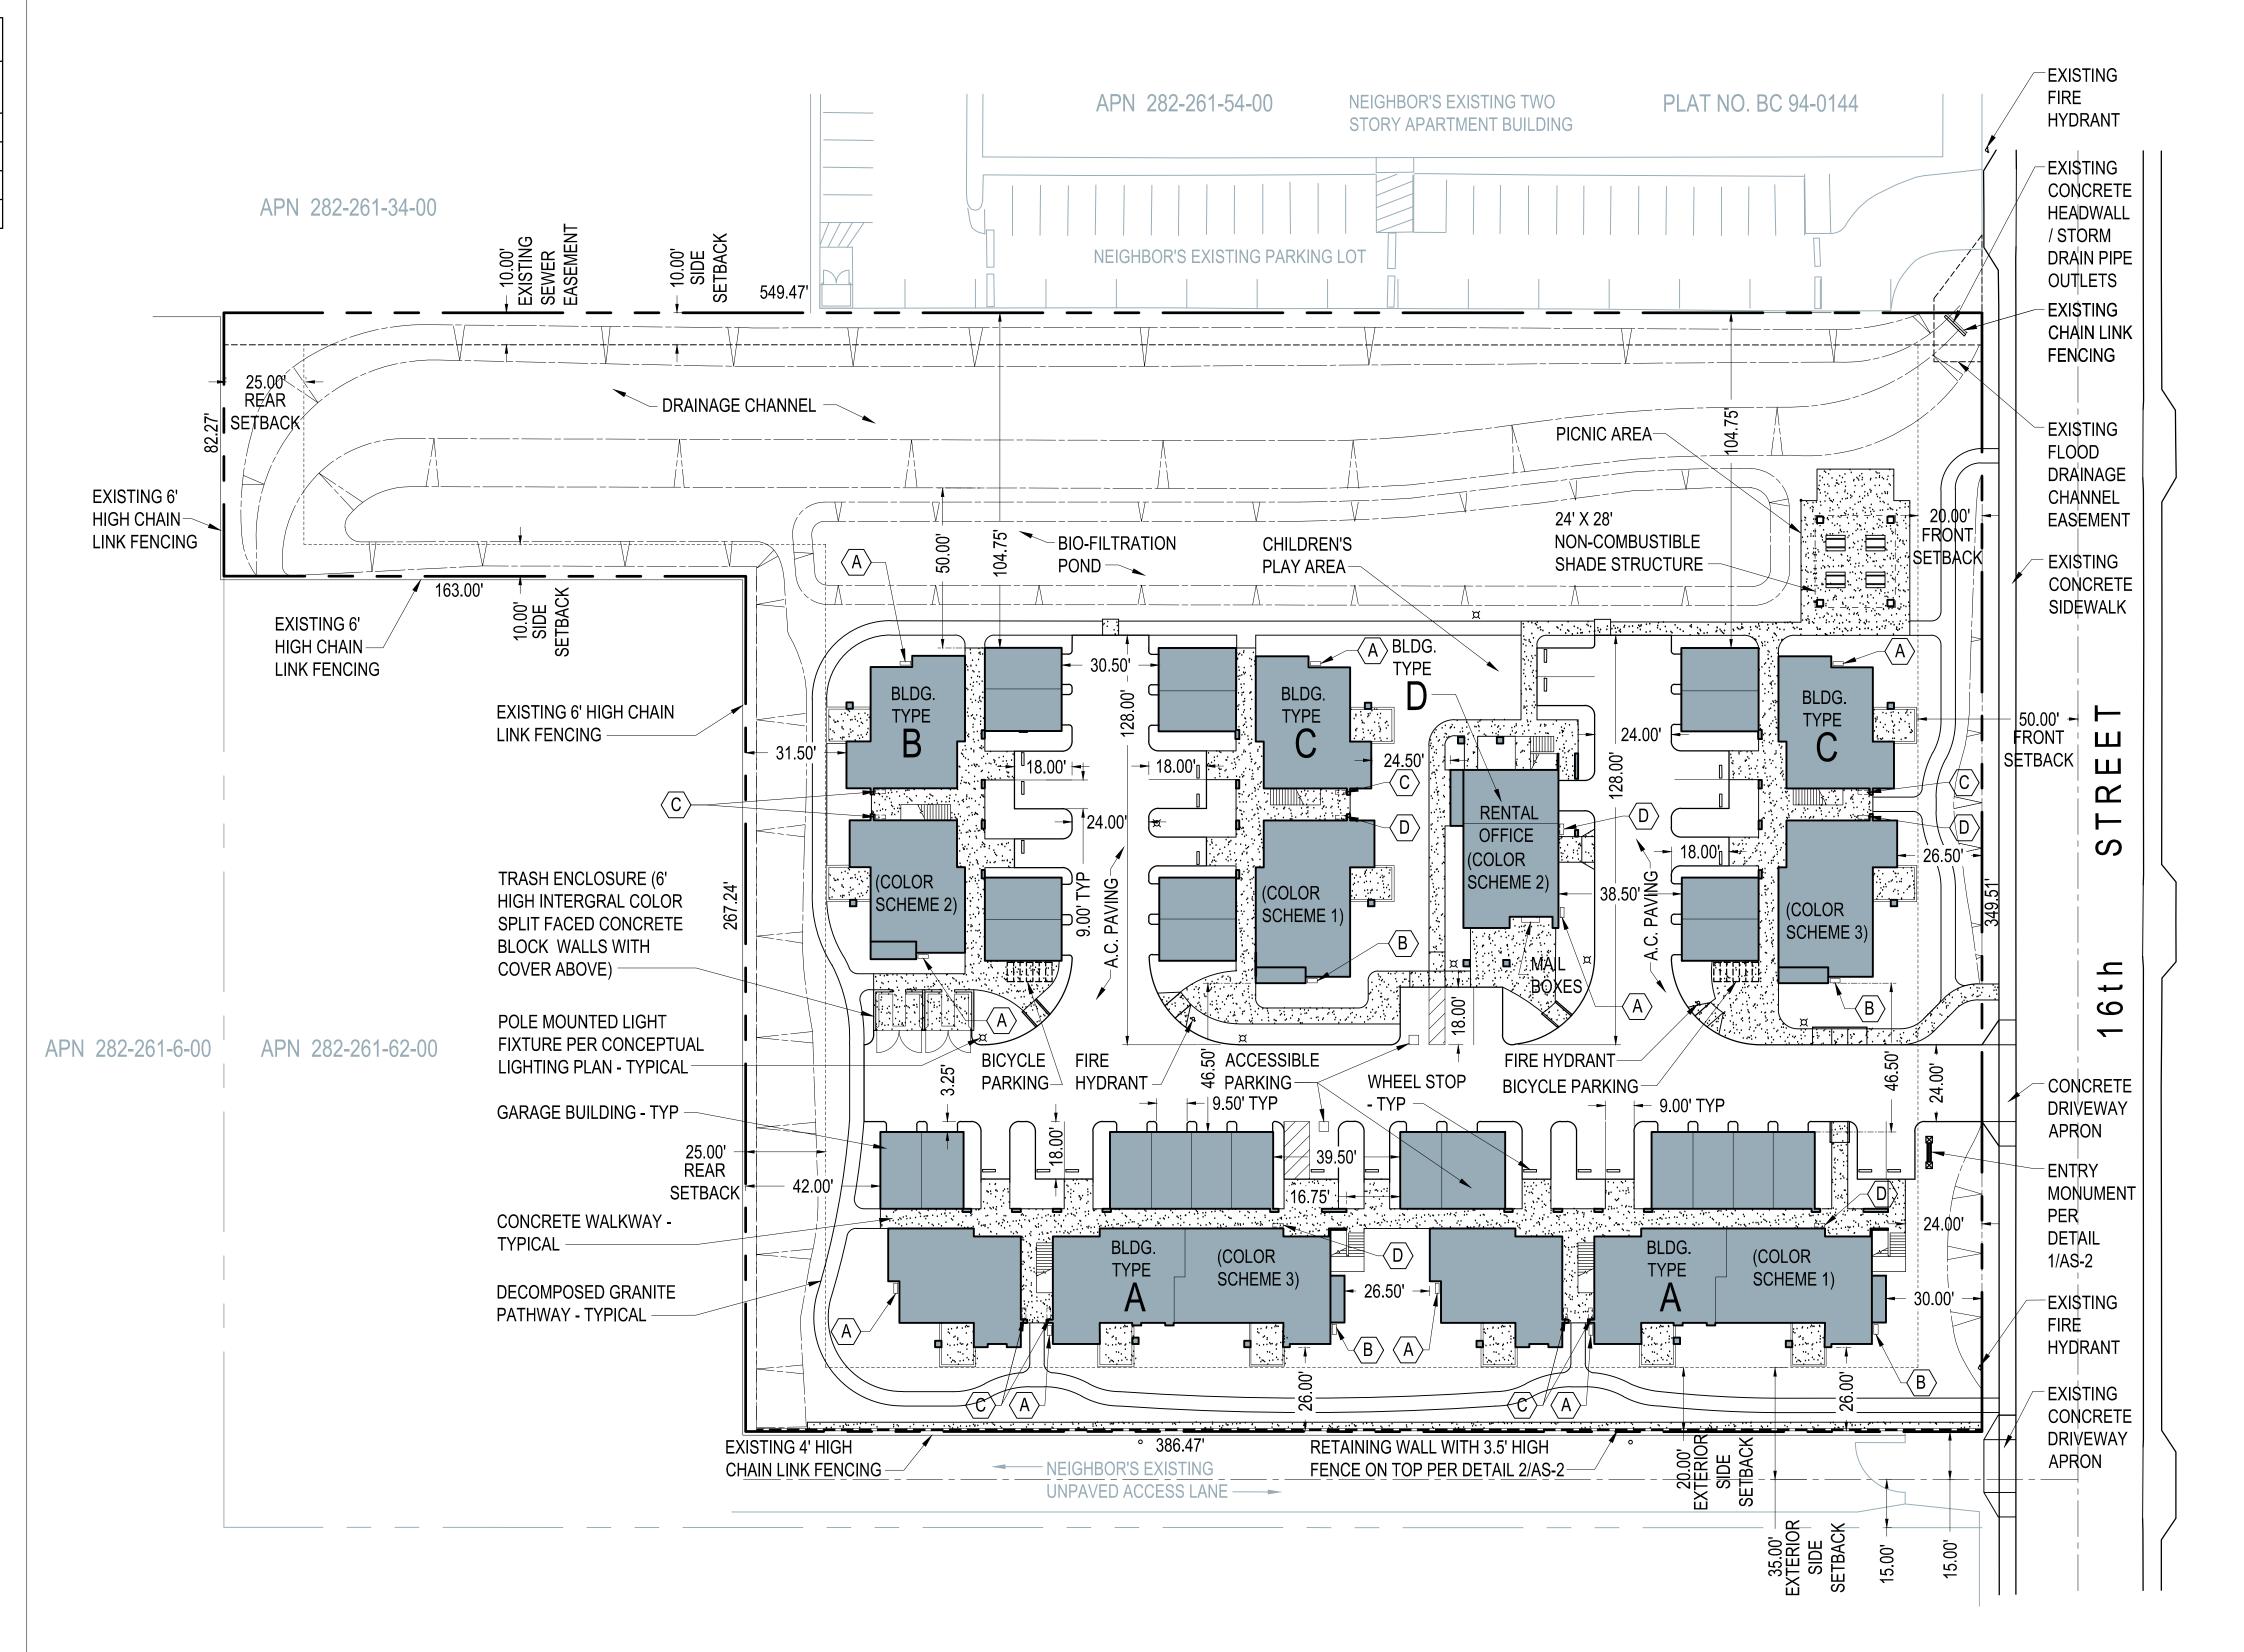1" = 30'



NORTH



NORTH

Sheet Title:
CONCEPTUAL

Morris

Wildman

**APARTMENTS** 

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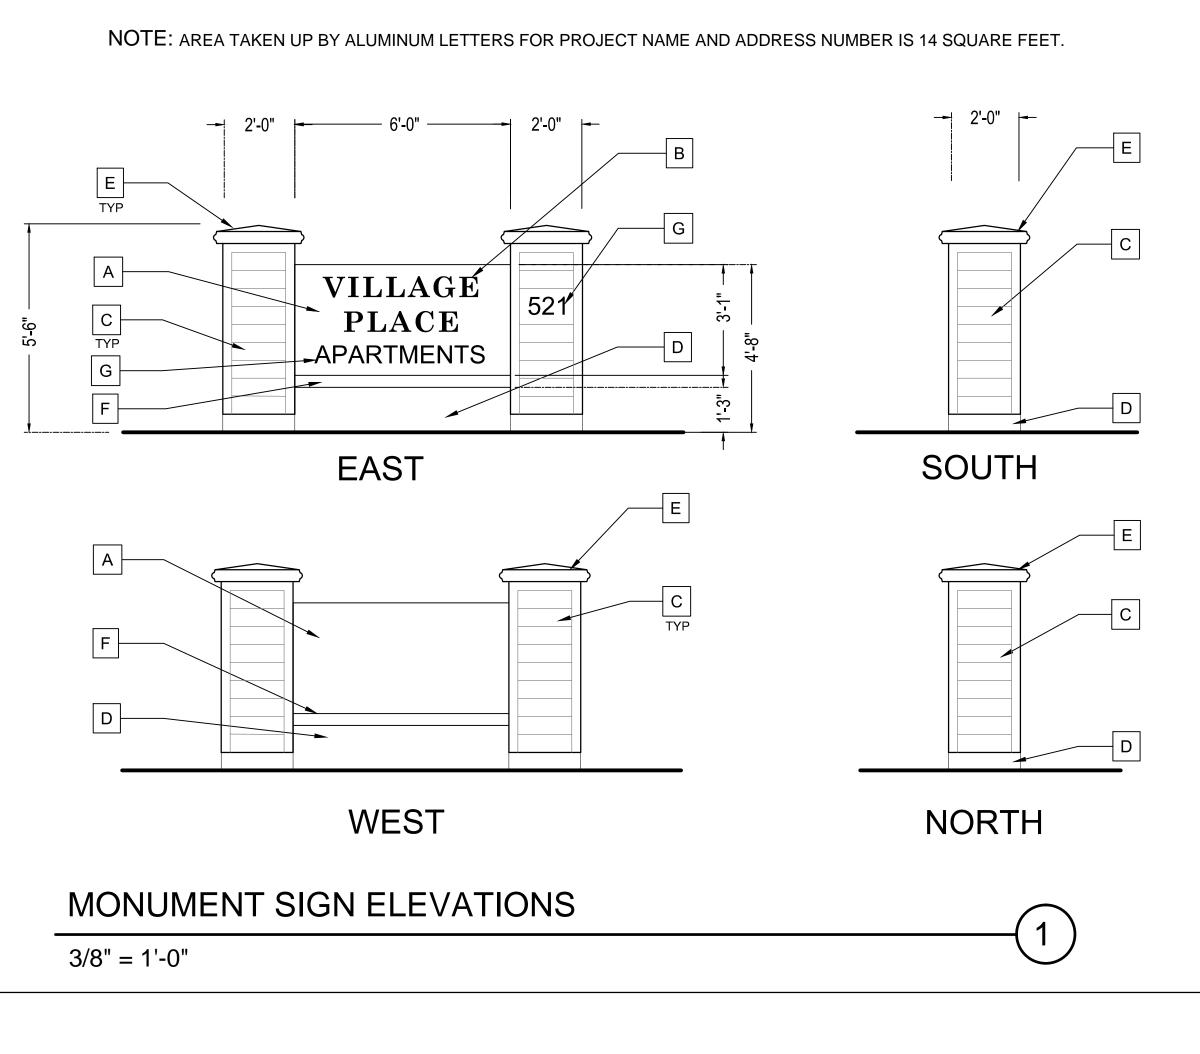
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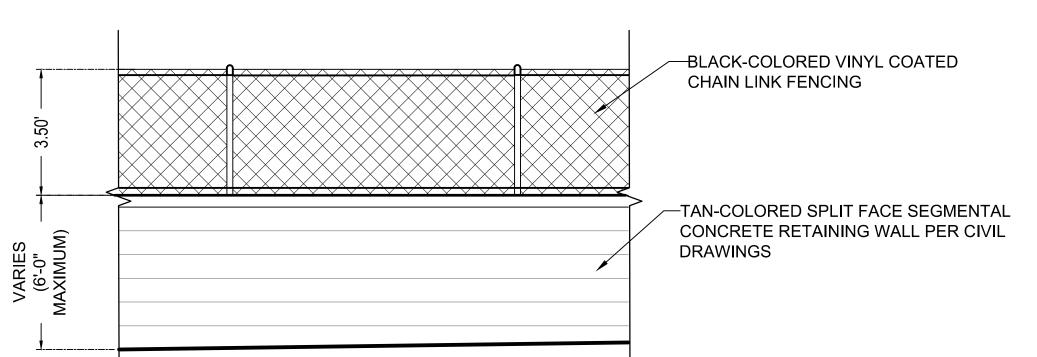
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RAMONA,

STREET,

16th






## SOUTH PROPERTY LINE FENCE ELEVATION

3/8" = 1'-0"

### KEYNOTES

- CEMENT PLASTER (PAINTED SIMILAR TO ALLURA FIBER CEMENT PRODUCTS, MARIGOLD)
- 7" FORMED ALUMINUM LETTERS (PAINTED SIMILAR TO SHERWIN WILLIAMS, 7710 BRANDYWINE)
- FIBER CEMENT HORIZONTAL SIDING (SIMILAR TO ALLURA FIBER CEMENT PRODUCTS, SUEDE)
- CONCRETE BASE (NATURAL GRAY)
- PRECAST CONCRETE COLUMN CAP (CREME-COLORED)
- CONCRETE FIN (PAINTED SIMILAR TO SHERWIN WILLIAMS, 7514 FOOTHILLS)
- 6" FORMED ALUMINUM LETTERS (PAINTED SIMILAR TO SHERWIN WILLIAMS, 7710 BRANDYWINE)

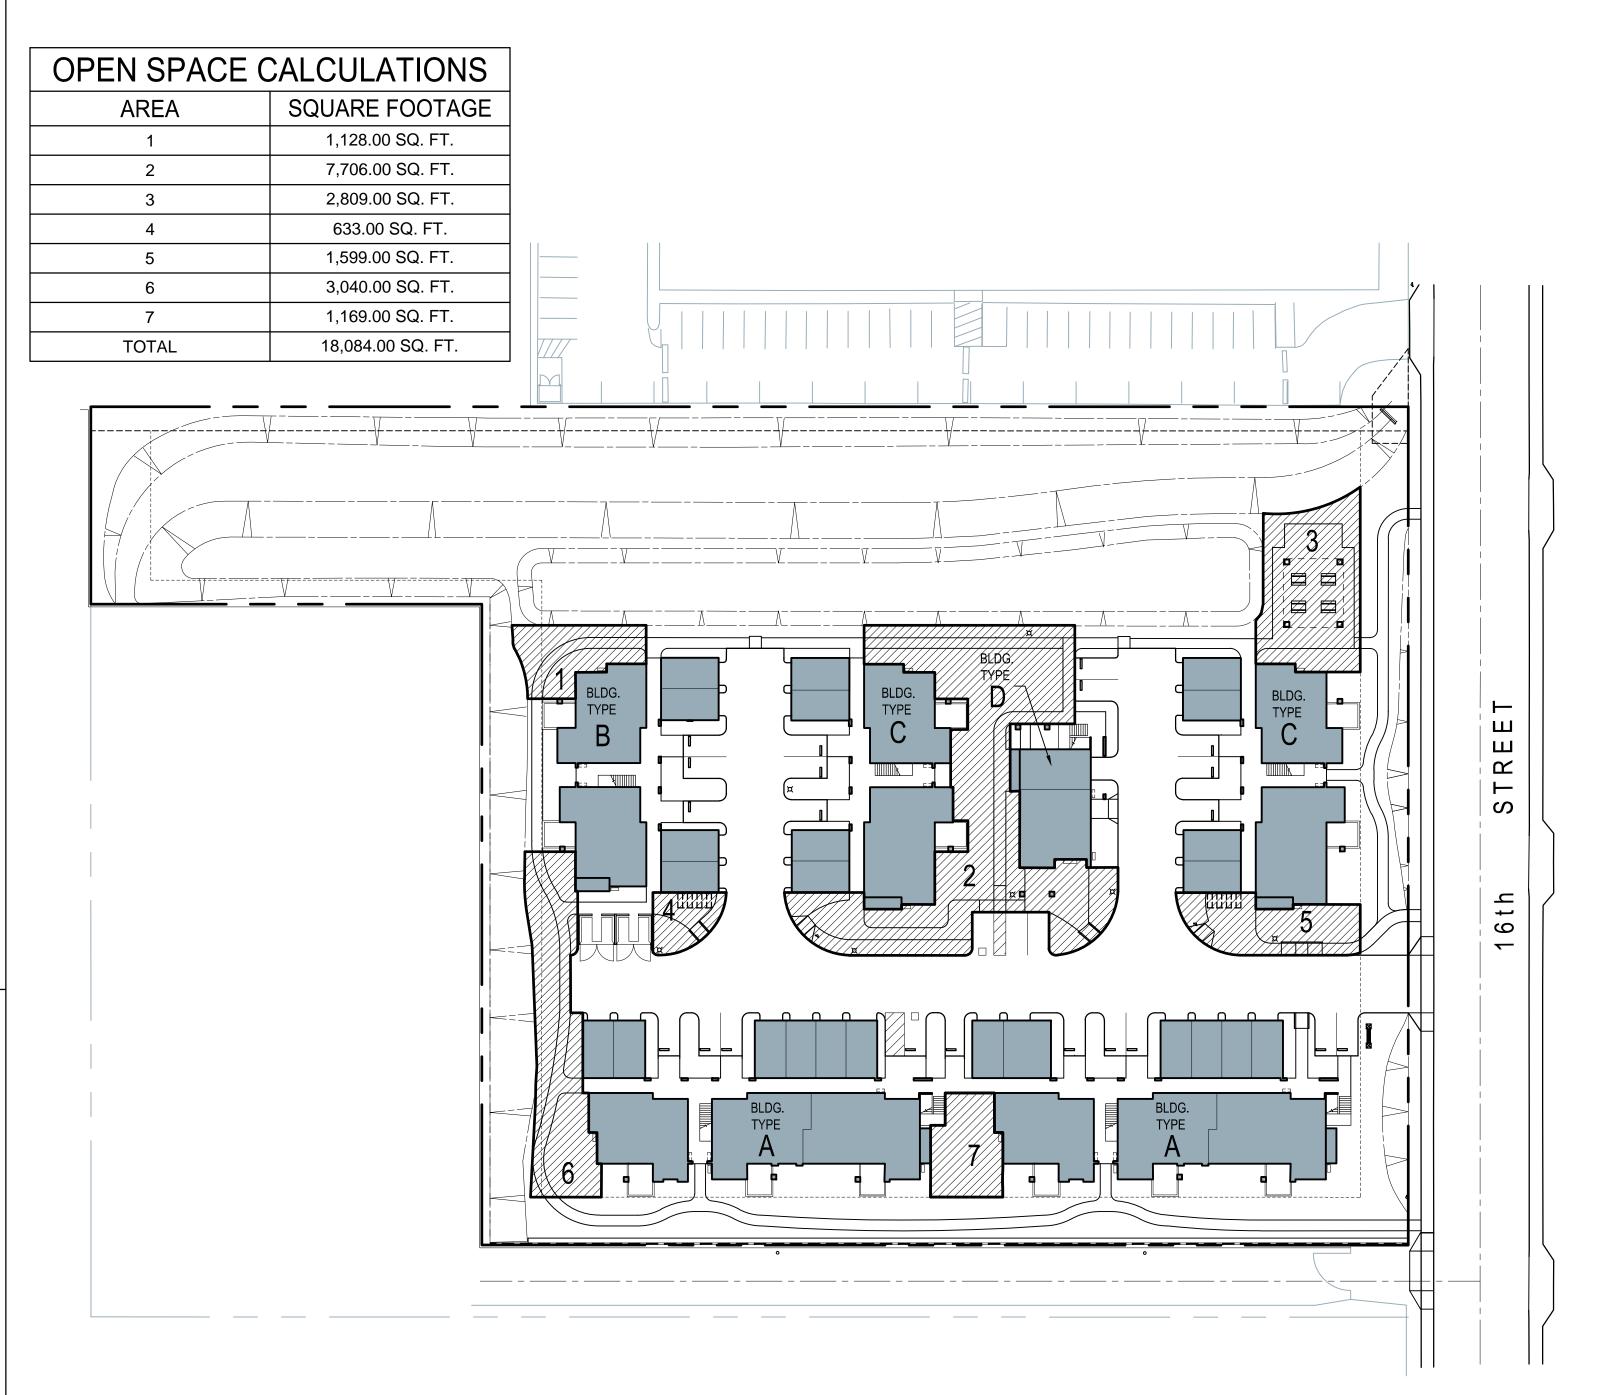

### GROUP USABLE OPEN SPACE PLAN

1' = 40'

2





PROJECT NORTH

Wildman &

**APARTMENTS** 

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RAMONA,

# PRIVATE OPEN SPACE LEGEND 130 SQ. FT. PATIO (WITH 50% OF THE MINIMUM REQUIRED 100 SQ. FT. NOT COVERED BY A PRIVATE BALCONY ABOVE) 75 SQ. FT. PRIVATE BALCONY 25 SQ. FT. PRIVATE BALCONY SPACE D 38 SQ. FT. PRIVATE BALCONY CONDENSER LEGEND GROUND MOUNTED CONDENSER (MITSUBISHI T119D-H236) GROUND MOUNTED CONDENSER (MITSUBISHI T121Q-H263) BALCONY DECK MOUNTED CONDENSER (MITUBISHI T119D-H236) 10'-0" BALCONY DECK MOUNTED CONDENSER (MITUBISHI T121Q-H263) 41'-5"



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RAMONA

16th



### BUILDING TYPE A: SOUTH ELEVATION (COLOR SCHEME 1)

1/8" = 1'-0"




1/8" = 1'-0"

### BUILDING TYPE A: NORTH ELEVATION (COLOR SCHEME 1)

1/8" = 1'-0"



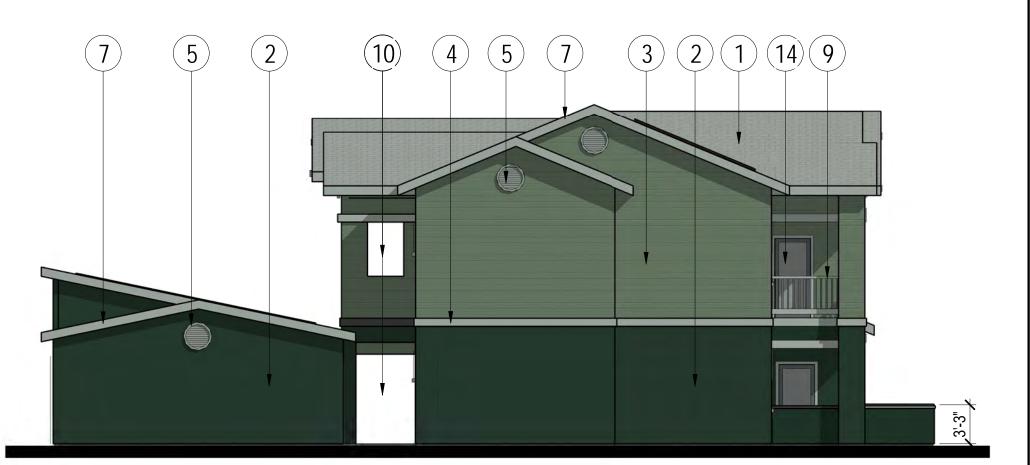

### BUILDING TYPE A: EAST ELEVATION (COLOR SCHEME 1)

1/8" = 1'-0"

BUILDING TYPE A: WEST ELEVATION (COLOR SCHEME 1)


### **KEYNOTES**

- SHADDOW-LINE TYPE COMPOSITION SHINGLES
- 2 FIBER CEMENT VERTICAL SIDING
- 3 FIBER CEMENT HORIZONTAL SIDING
- FIBER CEMENT TRIM BOARD
- METAL GABLE VENT
- WOOD GABLE BRACE
- FIBER CEMENT FASCIA BOARD
- FIXED WINDOW
- 9 METAL RAILING
- 10 OPEN
- 11 DOUBLE HUNG WINDOW
- 12 PHOTOVOLTAIC PANEL
- 3 METAL UPWARD ACTING SECTIONAL DOOR
- 14 WOOD FRAMED GLASS DOOR
- 15 WOOD DOOR

EXTERIOR COLOR SCHEDULE			
DESCRIPTION	EXTERIOR SCHEME ONE	EXTERIOR SCHEME TWO	EXTERIOR SCHEME THREE
ROOFING	COASTAL TAN	SIERRA BUFF	SANTE FE
PRIMARY SIDING	CYPRESS	MARIGOLD	SAVANNAH WICKER
SECONDARY SIDING	FOREST	SUEDE	HEARTHSTONE
TRIM	STERLING GRAY	SAVANNAH WICKER	DESERT TAN
DOORS	WALL STREET	FOOTHILLS	BRANDYWINE
GARAGE DOORS	TAUPE	ALMOND	DESERT TAN

### **GENERAL NOTES**

- 1. ACTUAL COLORS AND MATERIALS SHALL BE SIMILAR TO THOSE LISTED IN THE SCHEDULE.
- 2. ROOFING COLORS ARE BASED ON THE CERTAINTEED LANDMARK SOLARIS SERIES.
- 3. SIDING AND TRIM COLORS ARE BASED ON ALLURA FIBER CEMENT PRODUCTS.
- 4. DOOR PAINT COLORS ARE BASED ON SHERWIN WILLIAMS PRODUCTS.
- 5. GARAGE DOOR COLORS ARE BASED ON OVERHEAD DOOR CORPORATION PRODUCTS.
- 6. THE PROJECT SHALL CONFORM TO THE ARCHITECTURAL REQUIREMENTS WITHIN THE RAMONA DESIGN GUIDELINES.
- 7. THE ACCESSORY STRUCTURES INCLUDING THE GARAGE BUILDINGS SHALL HAVE THE SAME ARCHITECTURAL STYLE AND BE OF THE SAME MATERIALS AS THE RESIDENTIAL UNITS.

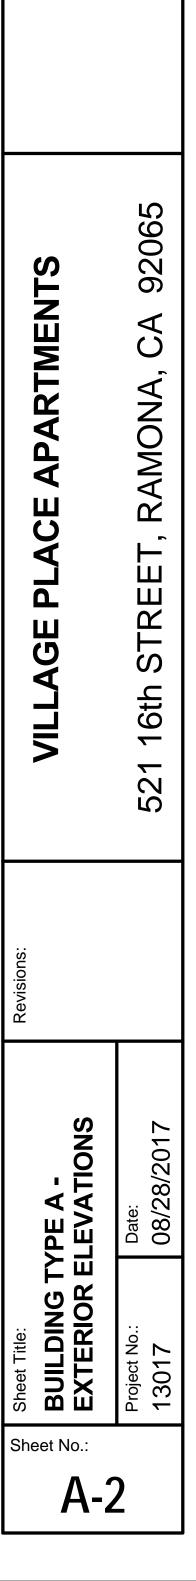

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### PRIVATE OPEN SPACE LEGEND

- A 130 SQ. FT. PATIO (WITH 50% OF THE MINIMUM REQUIRED 100 SQ. FT. NOT COVERED BY A PRIVATE BALCONY ABOVE)
- B 75 SQ. FT. PRIVATE BALCONY
- C 25 SQ. FT. PRIVATE BALCONY SPACE

### CONDENSER LEGEND

- A GROUND MOUNTED CONDENSER (MITSUBISHI T119D-H236)
- B GROUND MOUNTED CONDENSER (MITSUBISHI T121Q-H263)
- C BALCONY DECK MOUNTED CONDENSER (MITUBISHI T119D-H236)
- D BALCONY DECK MOUNTED CONDENSER (MITUBISHI T121Q-H263)






### BUILDING TYPE B: WEST ELEVATION (COLOR SCHEME 2)


1/8" = 1'-0"



### BUILDING TYPE B: EAST ELEVATION (COLOR SCHEME 2)

1/8" = 1'-0"

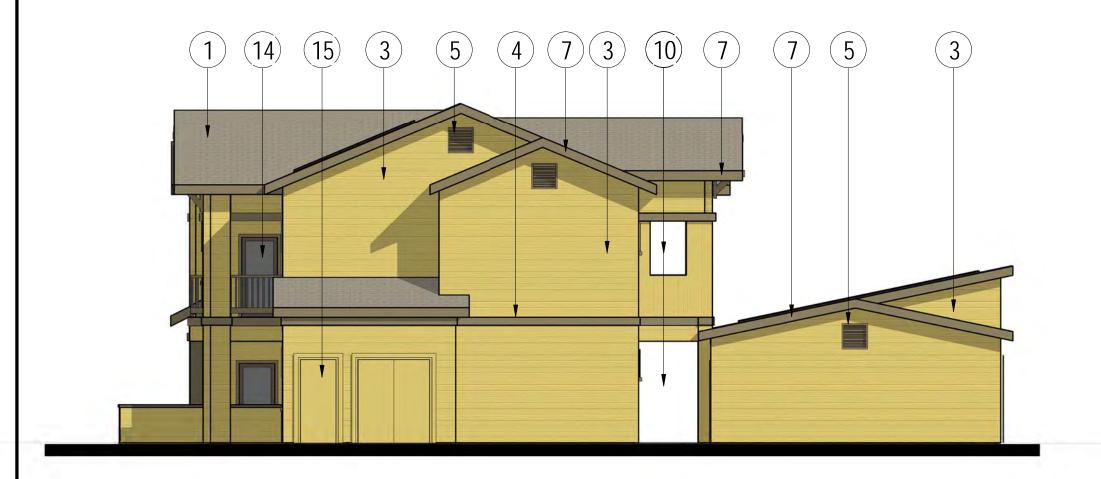

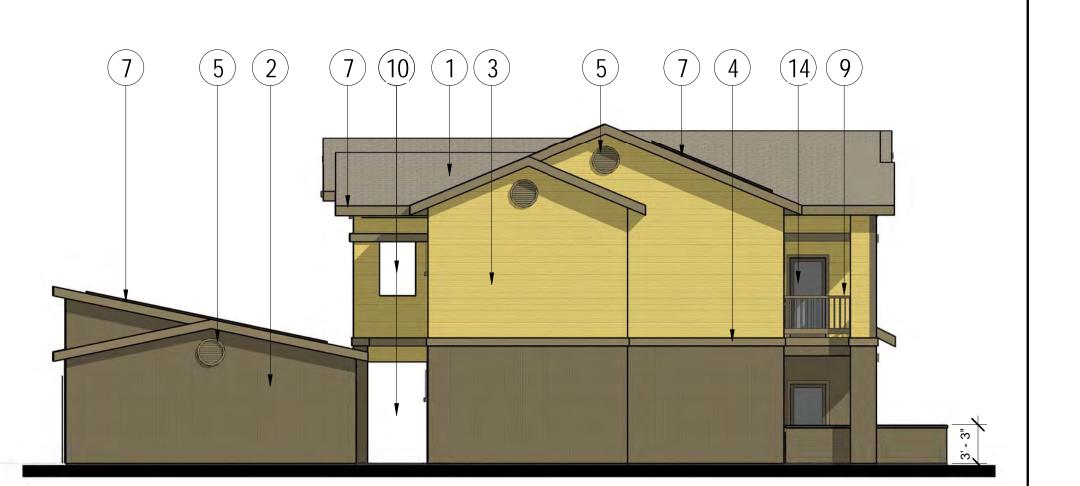

BUILDING TYPE B: SOUTH ELEVATION (COLOR SCHEME 2)

1/8" = 1'-0"

BUILDING TYPE B: NORTH ELEVATION (COLOR SCHEME 2)

### KEYNOTES

- SHADDOW-LINE TYPE COMPOSITION SHINGLES
- FIBER CEMENT VERTICAL SIDING
- FIBER CEMENT HORIZONTAL SIDING
- FIBER CEMENT TRIM BOARD
- 5 METAL GABLE VENT
- WOOD GABLE BRACE
- METAL RAILING
- 11 DOUBLE HUNG WINDOW
- 14 WOOD FRAMED GLASS DOOR
- 15 WOOD DOOR

EXTERIOR COLOR SCHEDULE		
DESCRIPTION EXTERIOR SCHEME TWO		
ROOFING	SIERRA BUFF	
PRIMARY SIDING MARIGOLD		
SECONDARY SIDING SUEDE		
TRIM	SAVANNAH WICKER	
DOORS	FOOTHILLS	
GARAGE DOORS	ALMOND	

- ROOFING COLORS ARE BASED ON THE CERTAINTEED LANDMARK SOLARIS PLATINUM SERIES.
- 3. SIDING AND TRIM COLORS ARE BASED ON ALLURA FIBER CEMENT PRODUCTS.
- 4. DOOR PAINT COLORS ARE BASED ON SHERWIN WILLIAMS PRODUCTS
- 5. GARAGE DOOR COLORS ARE BASED ON OVERHEAD DOOR CORPORATION PRODUCTS.
- 6. THE PROJECT SHALL CONFORM TO THE ARCHITECTURAL REQUIREMENTS WITHIN THE RAMONA
- 7. THE ACCESSORY STRUCTURES INCLUDING THE GARAGE BUILDINGS SHALL HAVE THE SAME ARCHITECTURAL STYLE AND BE OF THE SAME MATERIALS AS THE RESIDENTIAL UNITS.

FIBER CEMENT FASCIA BOARD

FIXED WINDOW

10 OPEN

12 PHOTOVOLTAIC PANEL

13 METAL UPWARD ACTING SECTIONAL DOOR

GENERAL NOTES

1. ACTUAL COLORS AND MATERIALS SHALL BE SIMILAR TO THOSE LISTED IN THE SCHEDULE.

TYPE B -

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**APARTMENTS** 


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### PRIVATE OPEN SPACE LEGEND

- 130 SQ. FT. PATIO (WITH 50% OF THE MINIMUM REQUIRED 100 SQ. FT. NOT COVERED BY A PRIVATE BALCONY ABOVE)
- B 75 SQ. FT. PRIVATE BALCONY
- C 25 SQ. FT. PRIVATE BALCONY SPACE

### CONDENSER LEGEND

- A GROUND MOUNTED CONDENSER (MITSUBISHI T119D-H236)
- B GROUND MOUNTED CONDENSER (MITSUBISHI T121Q-H263)
- C BALCONY DECK MOUNTED CONDENSER (MITUBISHI T119D-H236)
- D BALCONY DECK MOUNTED CONDENSER (MITUBISHI T121Q-H263)



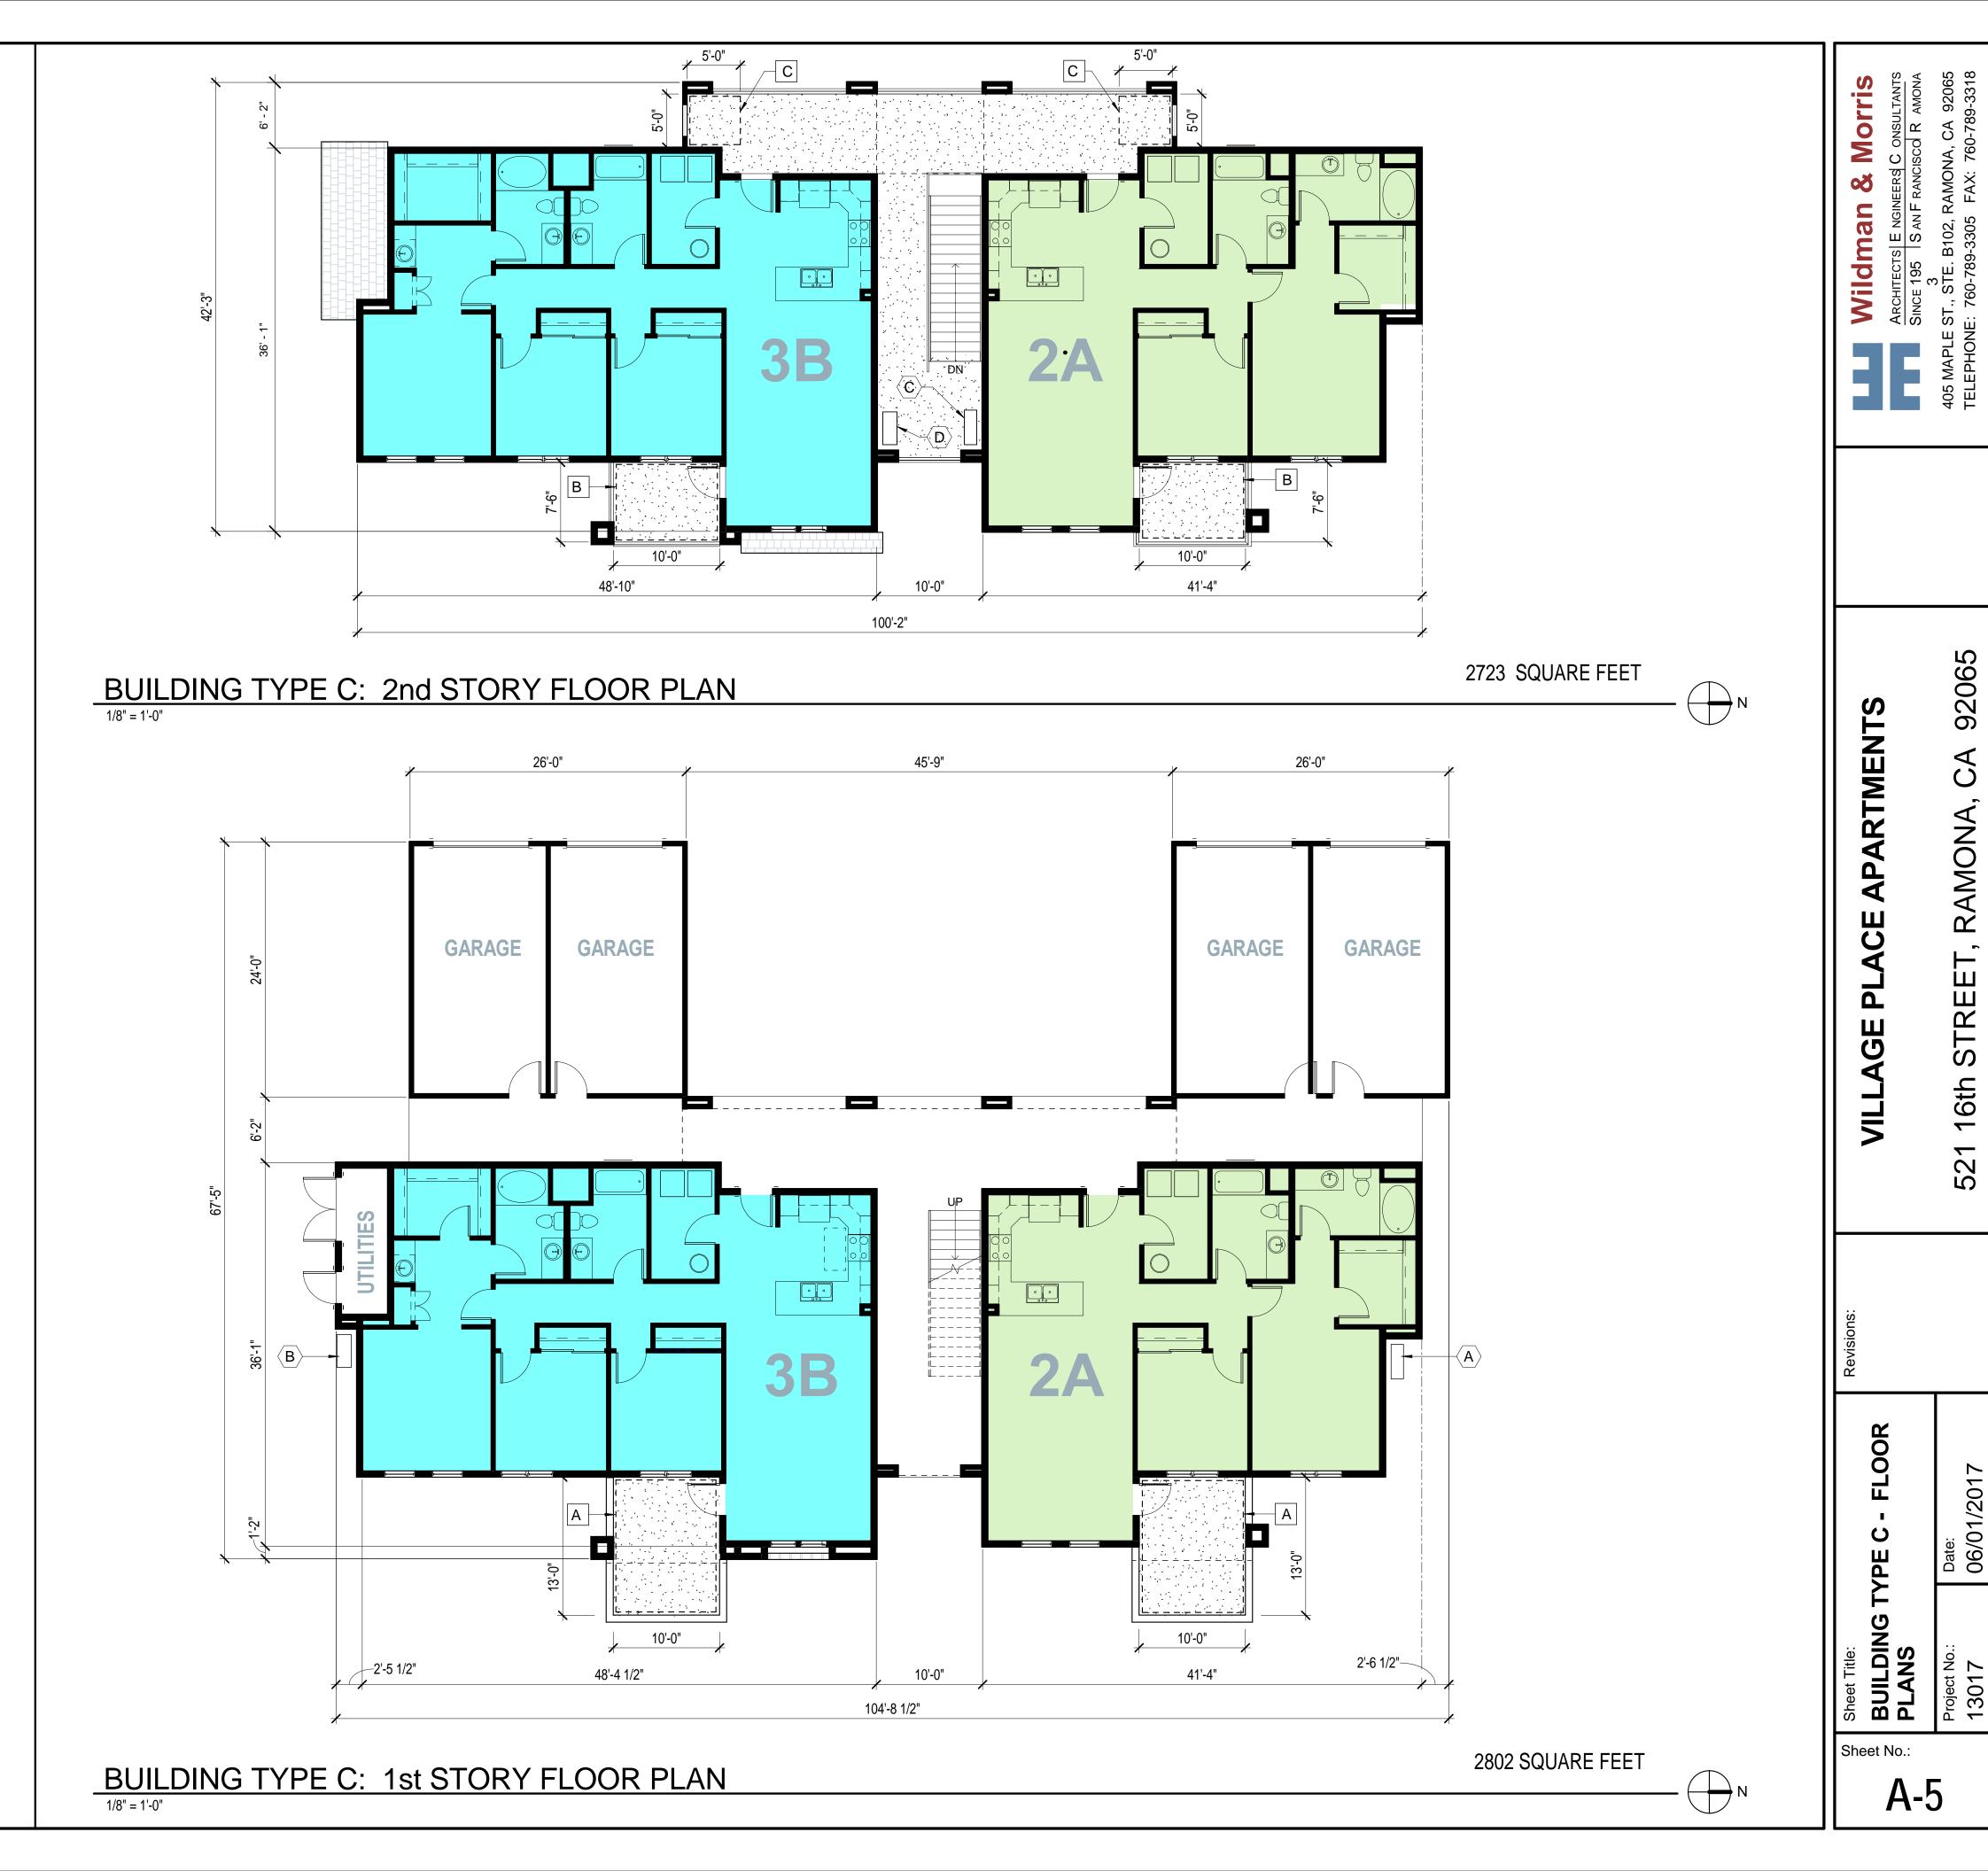

### BUILDING TYPE C: EAST ELEVATION (COLOR SCHEME 3)


1/8" = 1'-0"




1/8" = 1'-0"

### BUILDING TYPE C: WEST ELEVATION (COLOR SCHEME 3)

1/8" = 1'-0"

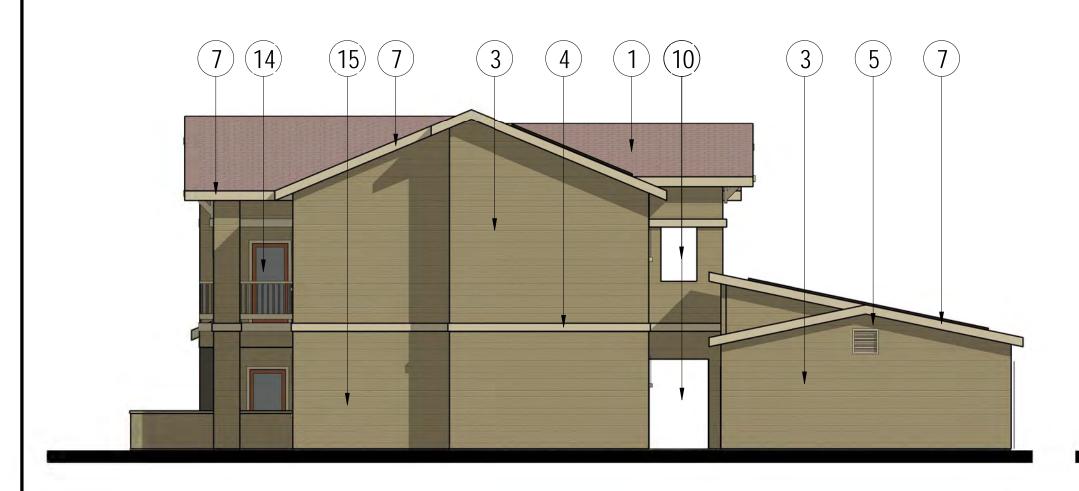

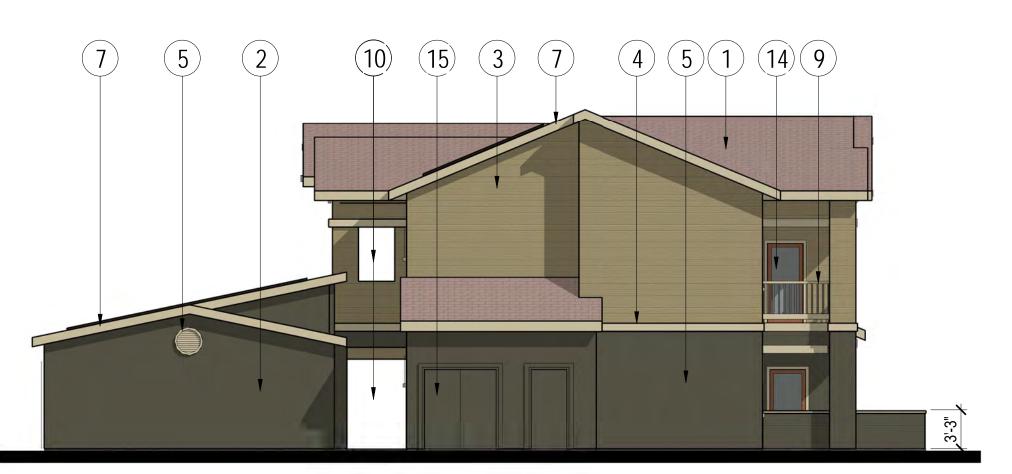

BUILDING TYPE C: NORTH ELEVATION (COLOR SCHEME 3)

1/8" = 1'-0"

BUILDING TYPE C: SOUTH ELEVATION (COLOR SCHEME 3)

### **KEYNOTES**

- SHADDOW-LINE TYPE COMPOSITION SHINGLES
- FIBER CEMENT VERTICAL SIDING
- FIBER CEMENT HORIZONTAL SIDING
- FIBER CEMENT TRIM BOARD
- 5 METAL GABLE VENT
- 6 WOOD GABLE BRACE
- FIBER CEMENT FASCIA BOARD
- 8 FIXED WINDOW
- METAL RAILING
- 10 OPEN
- 11 DOUBLE HUNG WINDOW
- 12 PHOTOVOLTAIC PANEL
- METAL UPWARD ACTING SECTIONAL DOOR
- 14 WOOD FRAMED GLASS DOOR
- 15 WOOD DOOR

EXTERIOR COLOR SCHEDULE			
DESCRIPTION	EXTERIOR SCHEME ONE	EXTERIOR SCHEME TWO	EXTERIOR SCHEME THREE
ROOFING	COASTAL TAN	SIERRA BUFF	SANTE FE
PRIMARY SIDING	CYPRESS	MARIGOLD	SAVANNAH WICKER
SECONDARY SIDING	FOREST	SUEDE	HEARTHSTONE
TRIM	STERLING GRAY	SAVANNAH WICKER	DESERT TAN
DOORS	WALL STREET	FOOTHILLS	BRANDYWINE
GARAGE DOORS	TAUPE	ALMOND	DESERT TAN

### GENERAL NOTES

- 1. ACTUAL COLORS AND MATERIALS SHALL BE SIMILAR TO THOSE LISTED IN THE SCHEDULE.
- 2. ROOFING COLORS ARE BASED ON THE CERTAINTEED LANDMARK SOLARIS SERIES.
- 3. SIDING AND TRIM COLORS ARE BASED ON ALLURA FIBER CEMENT PRODUCTS.
- 4. DOOR PAINT COLORS ARE BASED ON SHERWIN WILLIAMS PRODUCTS.
- 5. GARAGE DOOR COLORS ARE BASED ON OVERHEAD DOOR CORPORATION PRODUCTS.
- 6. THE PROJECT SHALL CONFORM TO THE ARCHITECTURAL REQUIREMENTS WITHIN THE RAMONA DESIGN GUIDELINES.
- 7. THE ACCESSORY STRUCTURES INCLUDING THE GARAGE BUILDINGS SHALL HAVE THE SAME ARCHITECTURAL STYLE AND BE OF THE SAME MATERIALS AS THE RESIDENTIAL UNITS.


A-6	BUILDING TYPE C - EXTERIOR ELEVATIONS	'PE C - LEVATIONS	VILLAGE PLACE	Ш
)	Project No.:	Date:	40.1	_
	13017	08/28/2017	321 10m 31 KEE1, R	?


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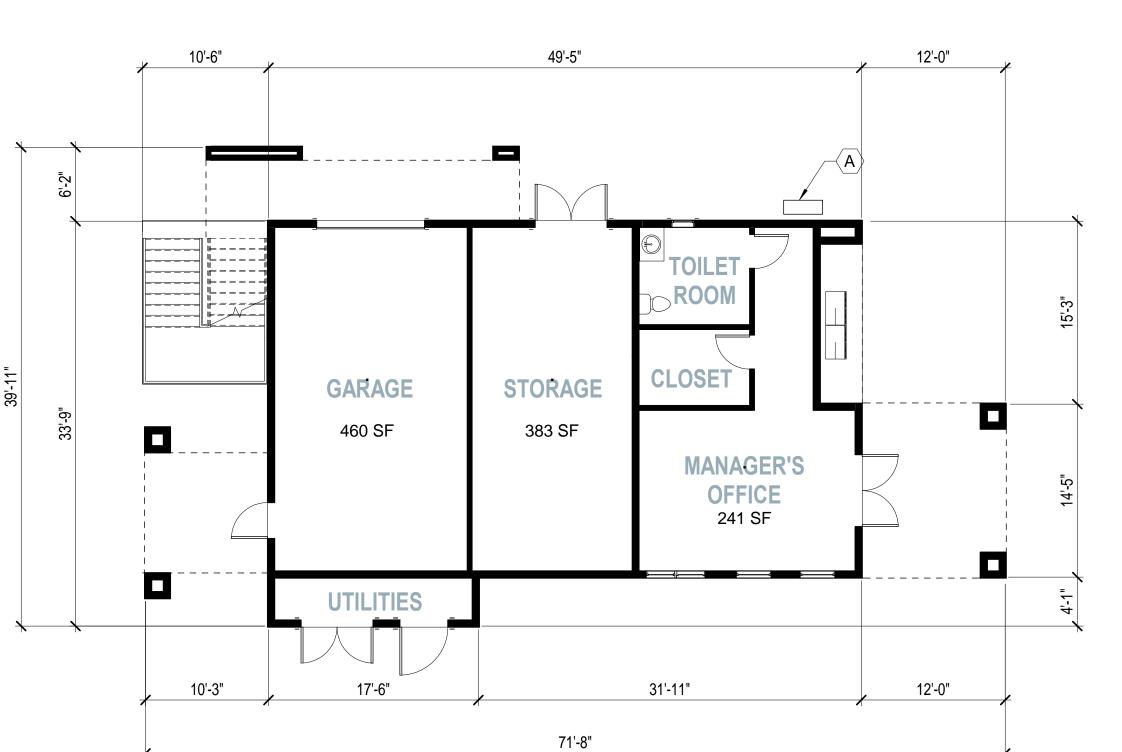
**APARTMENTS** 





1,467 SQUARE FEET
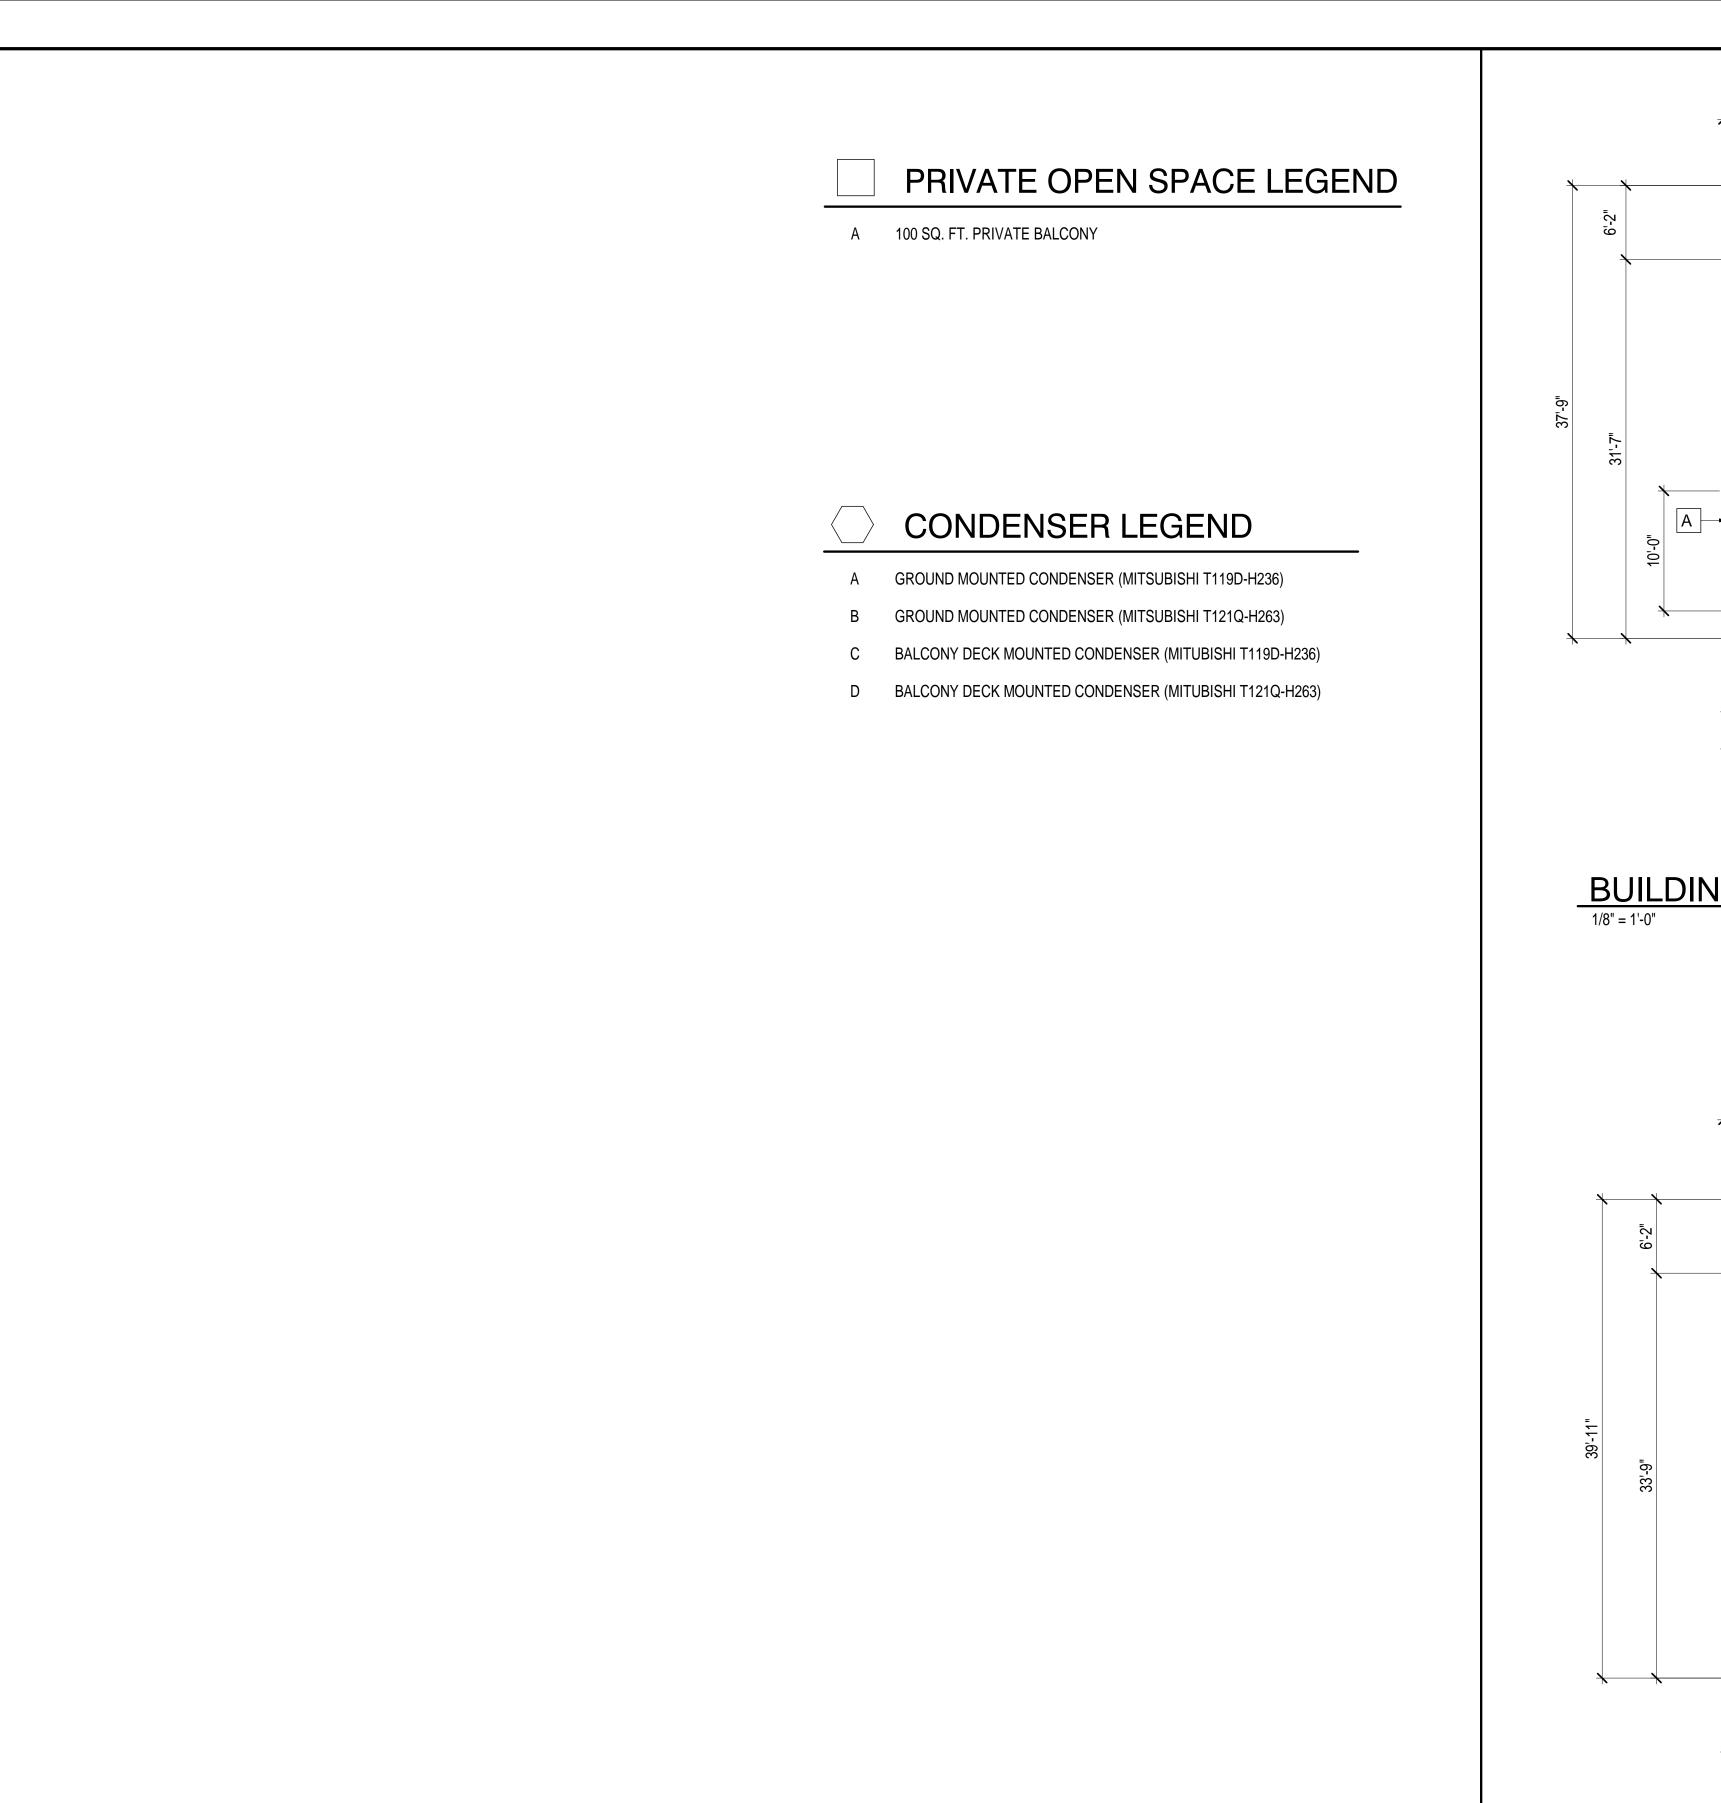
# BUILDING TYPE D: 2nd STORY FLOOR PLAN 1/8" = 1'-0"

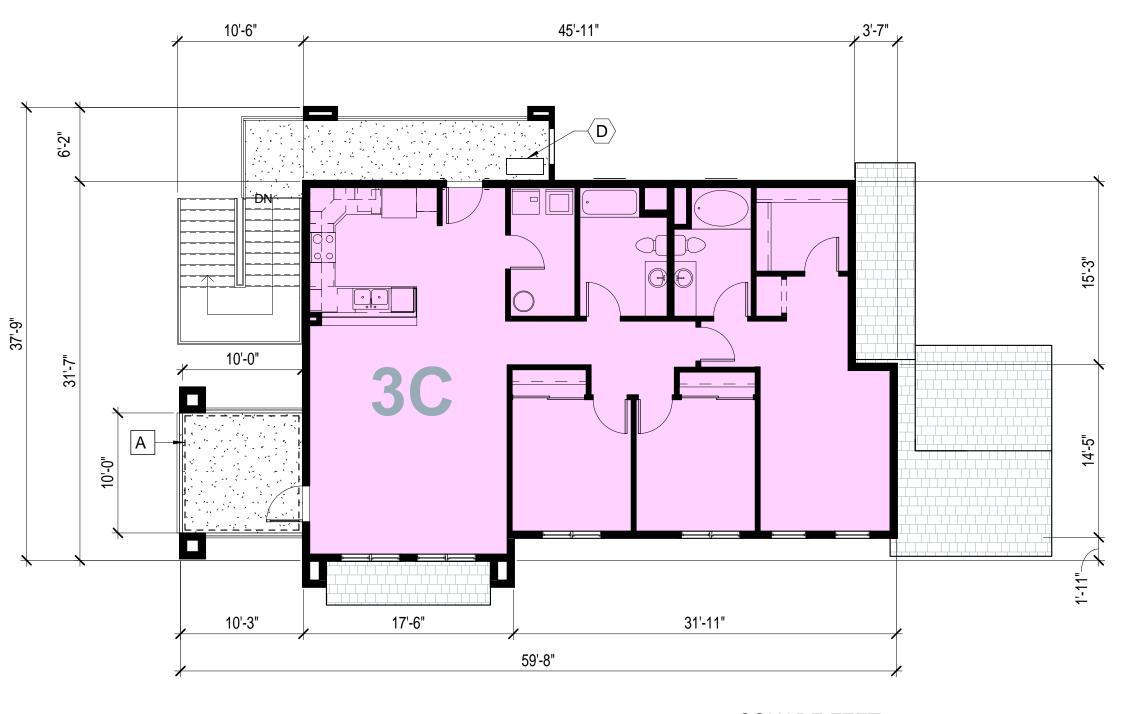

1,510 SQUARE FEET

BUILDING TYPE D: 1st STORY FLOOR PLAN

1/8" = 1'-0"



Sheet Title:

BUILDING TYPE D - FLOOR
PLANS

Project No.: Date:

Sheet No.:

**A-7** 

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RAMONA,

16th


**APARTMENTS** 

GE




### **BUILDING TYPE D: WEST ELEVATION (COLOR SCHEME 2)**

1/8" = 1'-0"

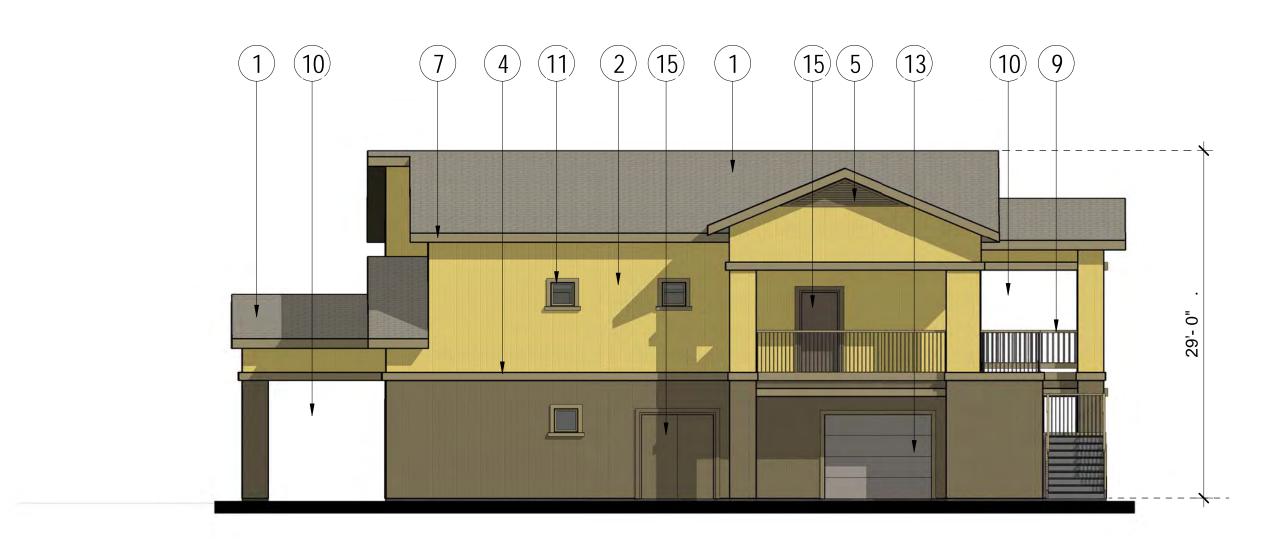

### BUILDING TYPE D: EAST ELEVATION (COLOR SCHEME 2)

1/8" = 1'-0"

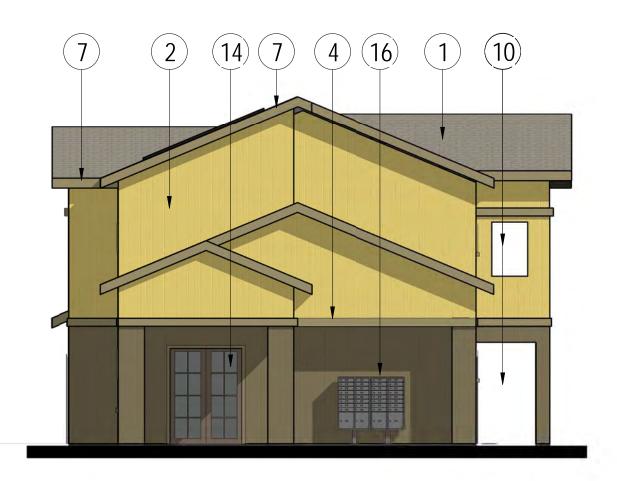

1/8" = 1'-0"



BUILDING TYPE D: SOUTH ELEVATION (COLOR SCHEME 2)

BUILDING TYPE D: NORTH ELEVATION (COLOR SCHEME 2) 1/8" = 1'-0"

### **KEYNOTES**

- SHADDOW-LINE TYPE COMPOSITION SHINGLES
- FIBER CEMENT VERTICAL SIDING
- FIBER CEMENT HORIZONTAL SIDING
- FIBER CEMENT TRIM BOARD
- METAL GABLE VENT
- WOOD GABLE BRACE
- FIBER CEMENT FASCIA BOARD
- FIXED WINDOW
- METAL RAILING
- OPEN
- DOUBLE HUNG WINDOW
- PHOTOVOLTAIC PANEL
- METAL UPWARD ACTING SECTIONAL DOOR
- WOOD FRAMED GLASS DOOR
- WOOD DOOR
- MAIL BOXES

EXTERIOR COLOR SCHEDULE		
DESCRIPTION	EXTERIOR SCHEME TWO	
ROOFING	SIERRA BUFF	
PRIMARY SIDING MARIGOLD		
SECONDARY SIDING	SUEDE	
TRIM	SAVANNAH WICKER	
DOORS	FOOTHILLS	
GARAGE DOORS	ALMOND	

### GENERAL NOTES


- 1. ACTUAL COLORS AND MATERIALS SHALL BE SIMILAR TO THOSE LISTED IN THE SCHEDULE.
- 2. ROOFING COLORS ARE BASED ON THE CERTAINTEED LANDMARK SOLARIS PLATINUM SERIES.
- 3. SIDING AND TRIM COLORS ARE BASED ON ALLURA FIBER CEMENT PRODUCTS.
- 4. DOOR PAINT COLORS ARE BASED ON SHERWIN WILLIAMS PRODUCTS.
- 5. GARAGE DOOR COLORS ARE BASED ON OVERHEAD DOOR CORPORATION PRODUCTS.
- 6. THE PROJECT SHALL CONFORM TO THE ARCHITECTURAL REQUIREMENTS WITHIN THE RAMONA DESIGN GUIDELINES.
- 7. THE ACCESSORY STRUCTURES INCLUDING THE GARAGE BUILDINGS SHALL HAVE THE SAME ARCHITECTURAL STYLE AND BE OF THE SAME MATERIALS AS THE RESIDENTIAL UNITS.


92065 **ARTMENTS** RAMONA CE STREE GE 16th 521

TYPE D -

Sheet No.:

**A-8** 

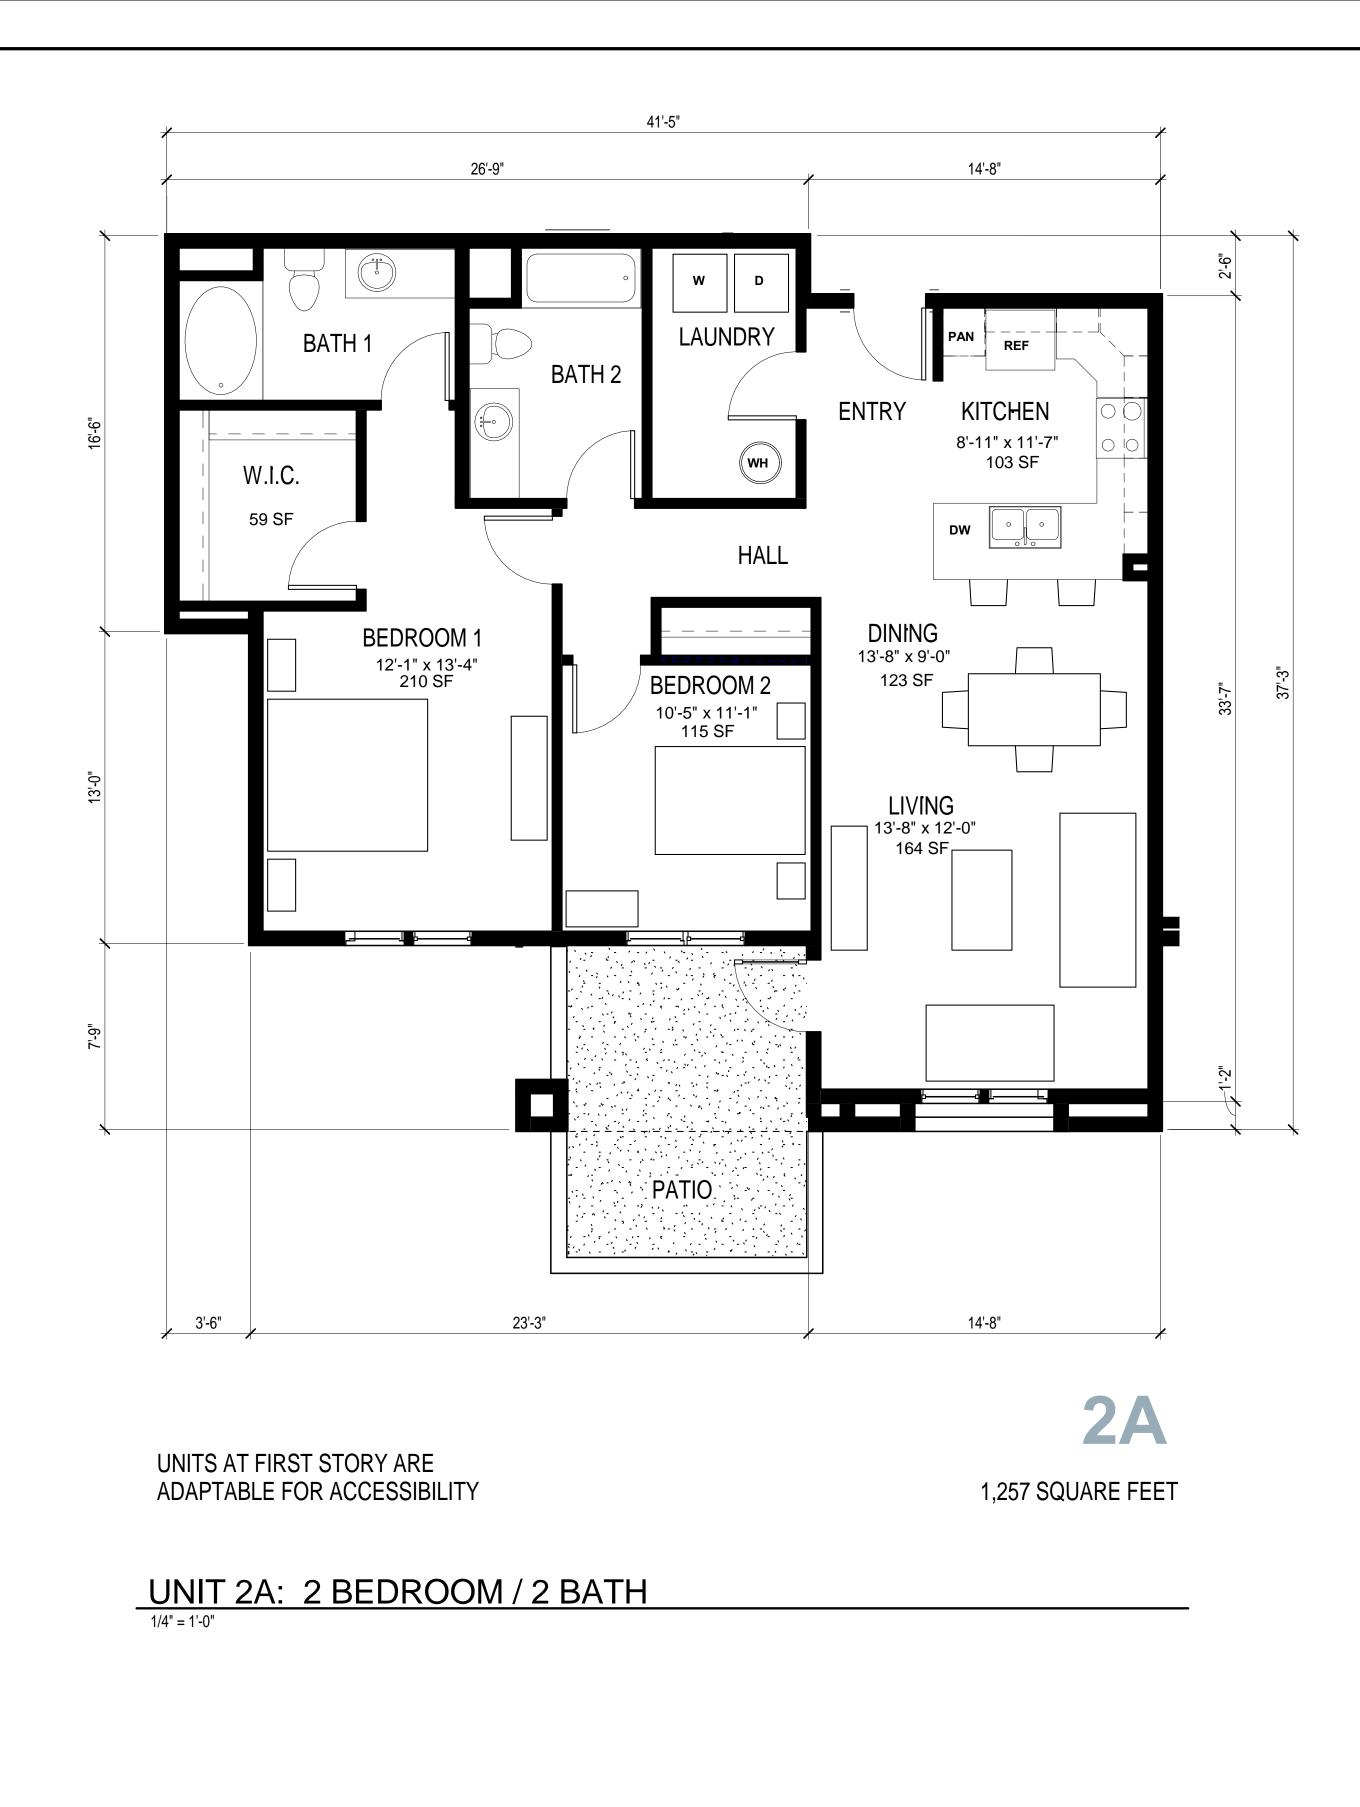

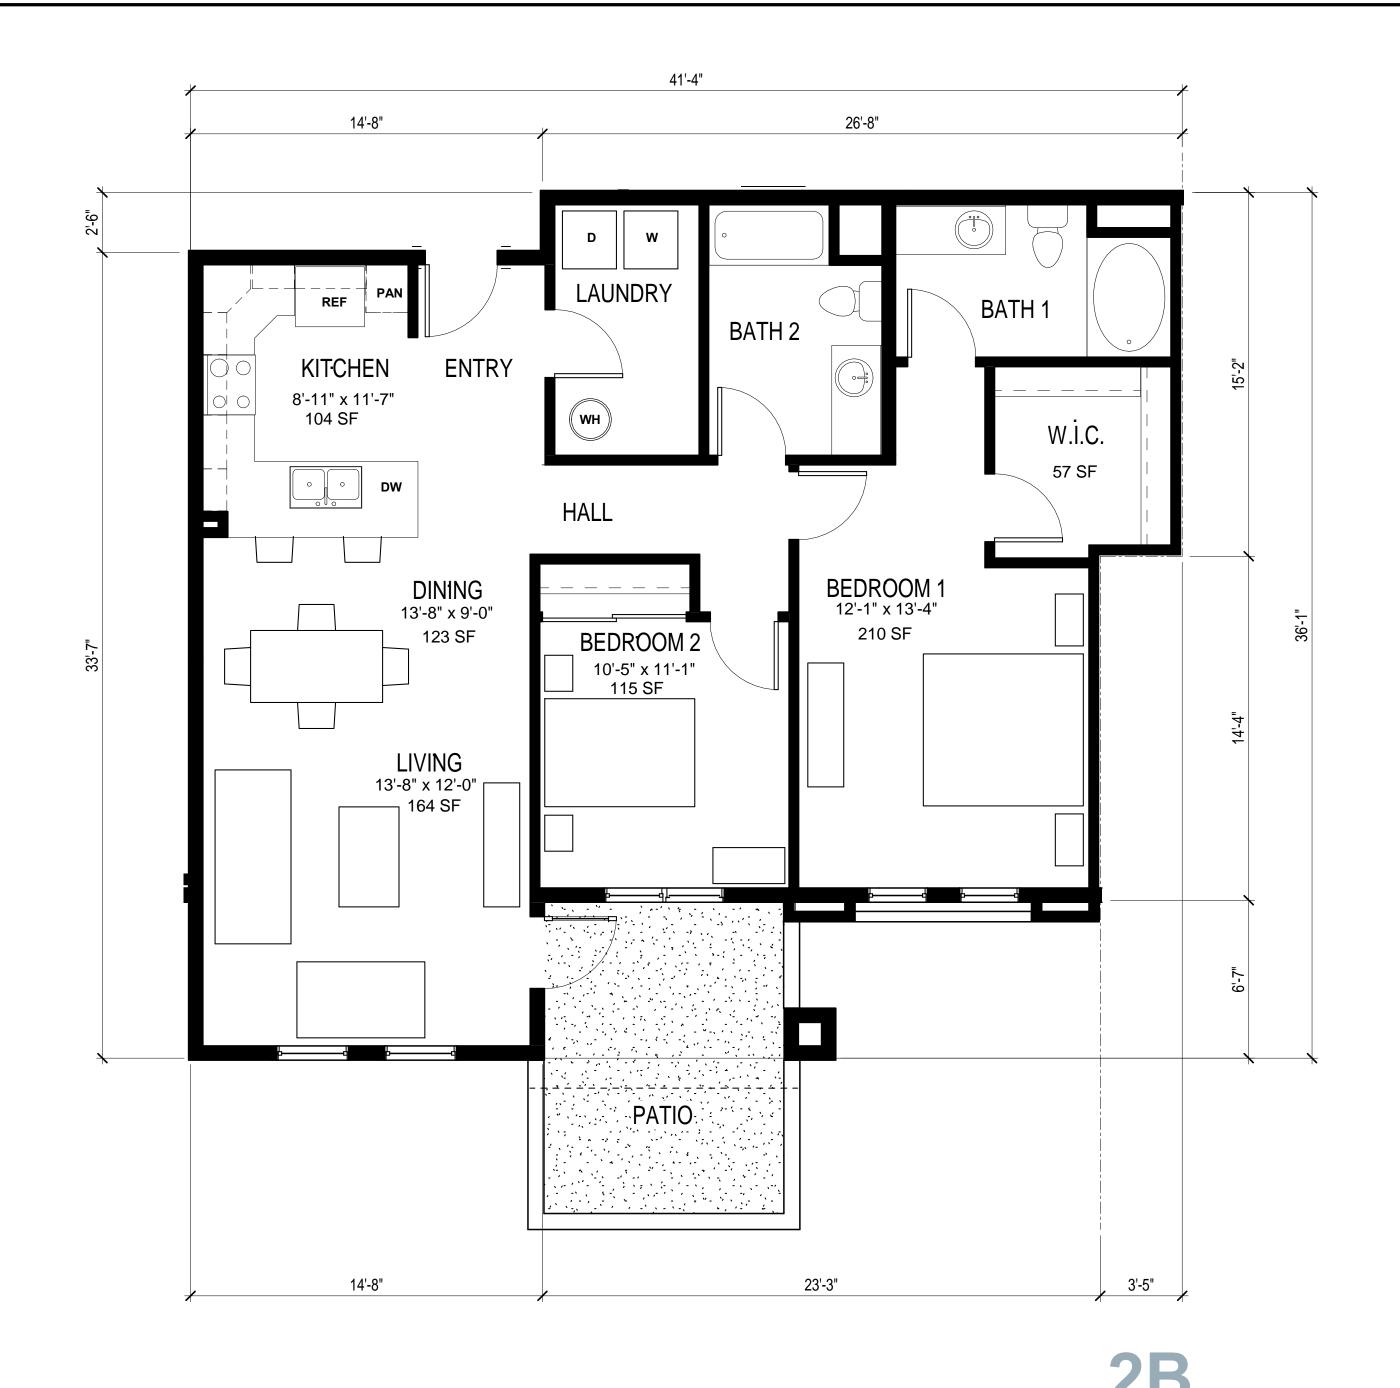

UNITS AT FIRST STORY ARE ADAPTABLE FOR ACCESSIBILITY

1,254 SQUARE FEET

UNIT 2B: 2 BEDROOM / 2 BATH

1/4" = 1'-0"

Sheet Title:

UNIT FLOOR PLANS

UNIT FLOOR PLANS

Project No.: Date:
13017

O6/01/2017

Sevisions:

UNIT FLOOR PLANS

Sevisions:

UNIT FLOOR PLANS

13017

Date:
13017

Wildman & Morris

ARCHITECTS E NGINEERS C ONSULTANTS
SINCE 195 S AN F RANCISCO R AMONA

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E ST., STE. B102, RAMONA, CA 92065
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RAMONA

STREET,

**APARTMENTS** 

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