

1324.09

APN: 6120300100,6120301900,6110910700,6110910300,6 6110600400,6110900200,6111000700,6111100100

I CERTIFY THAT I HAVE READ ALL ZONING REGULATIONS AND BEST MANAGEMENT PRACTICES (BMPs) NOTES AND THAT I AM THE DESIGN OF THE PROPOSED PROJECT:

PARCEL INFORMATION

North of I-8, east of Ribbonwood Road. on both sides of McCain Valley Road

SITE ADDRESS:

APN 611-060-04-00 (79 ACRES)

60' EASEMENT FOR INGRESS & EGRESS REC. 04-13-76, INST,# 108066 REC. 08-16-02, INST,# 02-0698092 & TERMS AGREEMENTS 02-0698093

CONTACT INFORMATION

ADDRESS: 16550 Via Esprillo

EMAIL: patrick.brown@soitec.com

CITY: San Diego

STATE: CA

30' ROAD DEDICATED TO COUNTY SAN DIEGO 74–217683 08–12–74 BK. 1974 O.R,

ADDRESS

CITY:

STATE:

PHONE: FAX: EMAIL:

OWNER INFORMATION

ALTERNATIVE ACCESS
BUILT TO COUNTY
FIRE CODE

VICINITY MAP

	PROJECT INFORMATION	PLOT PLAN INFORMATIO	N	SHEET TITLE	
6110900400,	EXISTING: Rolling, rugged land with two detached land sections made up of many parcels. All land is randomly populated by boulders. The site is minimally developed with unpaved roads.	CPV System Summary Approx. Number of Trackers: No. of Inverter Skids: Total Lease Area (Acres):	3291 57 506	EASEMENT (NORTH W	
NER	PROPOSED: Project located on approximately 506 acres and includes construction and operation of approximately 3291 Concentrated Photovoltaic (CPV) trackers with associated approximately 57 Inverters Skids and Transformers.	Estimated Disturbed Acreage: Coverage Ratio Range:	490 0.3 - 13%	SHEET NUMBER C-111	REV.
	Total and the second se				

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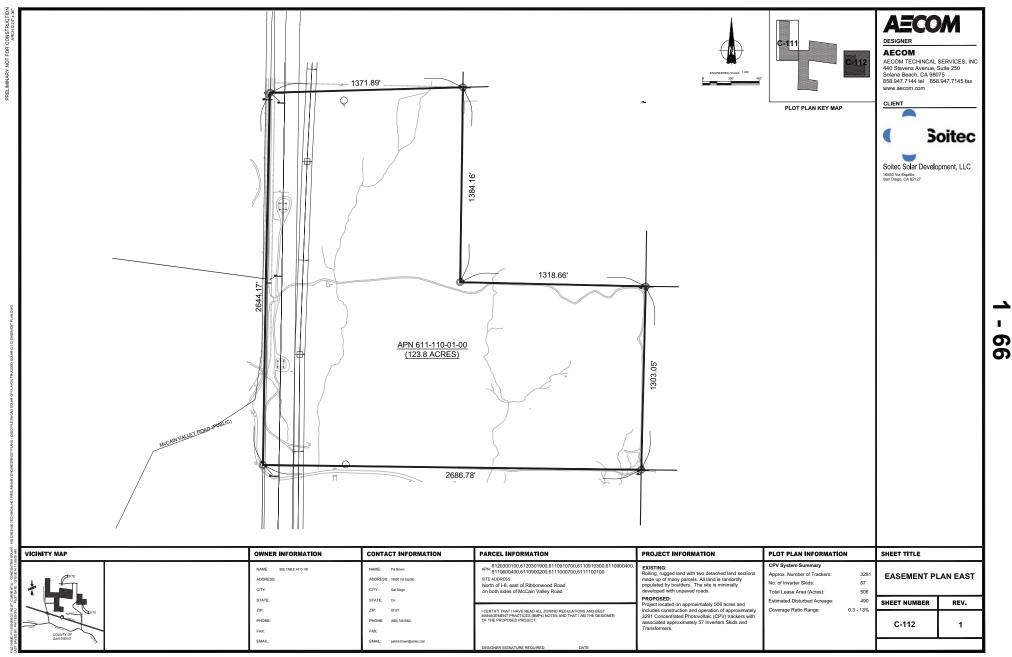
AECOM TECHINCAL SERVICES, INC 440 Stevens Avenue, Suite 250 Solana Beach, CA 98075 858.947.7144 tel 858.947.7145 fax


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PLOT PLAN KEY MAP





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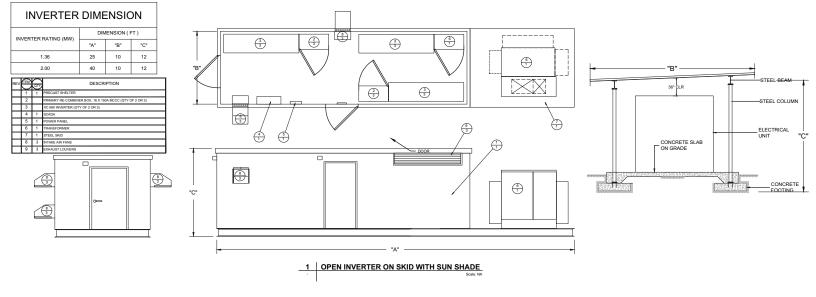
Soitec Solar Development, LLC

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16550 Via Esprillo San Diego, CA 92127

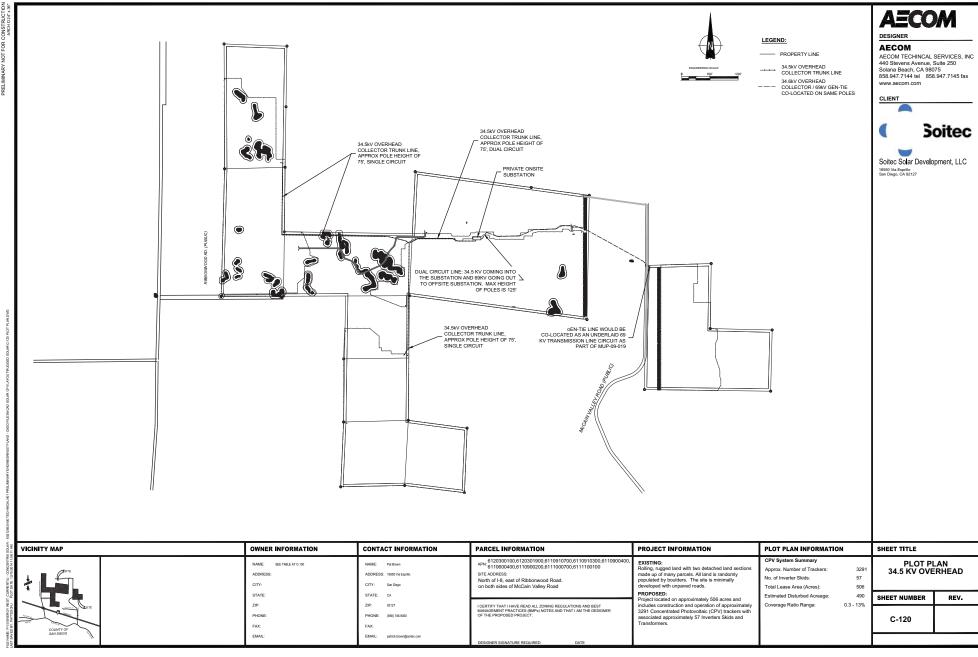


NOTES:


1. ENERGY STORAGE SYSTEM CONTAINERS SHALL BE PAINTED A COLOR CONSISTENT IN HUE AND INTENSITY WITH CPV TRACKER. MATERIALS COATINGS, OR PAINTS HAVING LITTLE OR NO REFLECTIVITY SHALL BE USED WHENEVER POSSIBLE.

2. TO ENSURE NOISE FROM ENERGY STORAGE SYSTEM HVAC UNITS, TRANSFORMERS AND INVERTERS WILL COMPLY WITH COUNTY NOISE ORDINANCE, ONE OF THE FOLLOWING MEASURES SHALL BE IMPLEMENTED: A) IF THE BATTERY STORAGE CONTAINER UNITS ARE EQUIPPED WITH STANDARD HVAC UNIT (NACO MODEL 30RB120, OR EQUIVALENT), EACH HVAC UNIT SHALL BE SURROUNDED BY A SOLID PERIMETER SCREEN WALL WITH ELEVATION ONE FOOT HIGHER THAN THE TOP ELEVATION OF THE HVAC UNIT. IN ADDITION, EACH STEP-UP TRANSFORMER AND RELATED PAIR (2) OF POWER INVERTERS SHALL BE ENCLOSED WITH AN 8-FOOT HIGH SOLID PERIMETER WALL. B) IF THE BATTERY STORAGE CONTAINER UNITS ARE EQUIPPED WITH A QUIETER HVAC UNIT (DAIKIN MCQUAY 025D, OR EQUIVALENT) EACH HVAC UNIT SHALL BE SURROUNDED BY A SOLID PERIMETER SCREEN WALL WITH ELEVATION ONE FOOT HIGHER THAT THE TOP ELEVATION OF THE CHILLER UNIT. NO TRANSFORMER OR INVERTER SCREEN WALLS ARE NECESSARY IF THE DAIKIN MCQUAY 025D. OR SOUND EQUIVALENT HVAC MODEL IS USED.


3. AUTOMATIC FIRE SPRINKLERS ARE NOT REQUIRED IF AN ALTERNATIVE FIRE SUPPRESSION SYSTEM ACCEPTABLE TO THE COUNTY FIRE MARSHALL IS PROVIDED

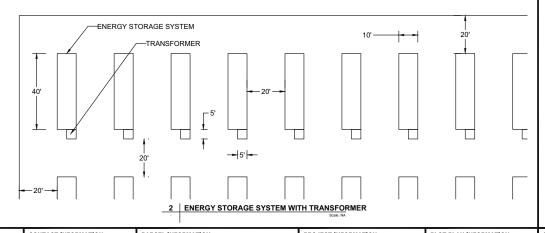

×80€	VICINITY MAP	OWNER INFORMATION	CONTACT INFORMATION	PARCEL INFORMATION	PROJECT INFORMATION	PLOT PLAN INFORMATION	SHEET TITLE	
CURPIENTU - CONCENTRO NOT DATE: 12/16/2014 11:51	÷ 5	NAME: SEE TABLE AT C-100 ADDRESS: CITY: STATE:	NAME: PallBrown ADDRESS: 1650 Via Esyrilo CITY: San Diogo STATE: CA	ABT 213300100,6123301900,6110910700,6110910300,6110900400, 6TH 104600400,6119900200,611000700,6111100100 STEADORESS. North of I-R, east of Ribbonwood Road, on both sides of McCain Valley Road	PROPOSED:	CPV System Summary Approx. Number of Trackers: 3291 No. of Inverter Skids: 57 Total Lease Area (Acres): 506 Estimated Disturbed Acreace: 490	1.36 / 2.0 MW INVE BOX DESIGN / EN STORAGE SYS	NERGY
LE NAME: P.40 ENERGY WEST NST SAVED BY: PATTES CNJ F	COUNTY OF SAIL DESC	ZIP: PHONE: FAX: EMAIL:	ZIP: 92127 PHONE: (838) 146-9200 FAX: EMAIL: patriol.brown@solite.com	I CERTIFY THAT I HAVE READ ALL ZONING REGULATIONS AND BEST MANAGEMENT PRACTICES GRAWS IN NOTES AND THAT I AM THE DESIGNER OF THE PROPOSED PROJECT: DESIGNER SIGNATURE REQUIRED DATE	Project located on approximately 506 acres and includes construction and operation of approximately 3291 Concentrated Photovoltaic (CPV) trackers with associated approximately 57 Inverters Skids and Transformers.	Coverage Ratio Range: 0.3 - 13%	C-130	1

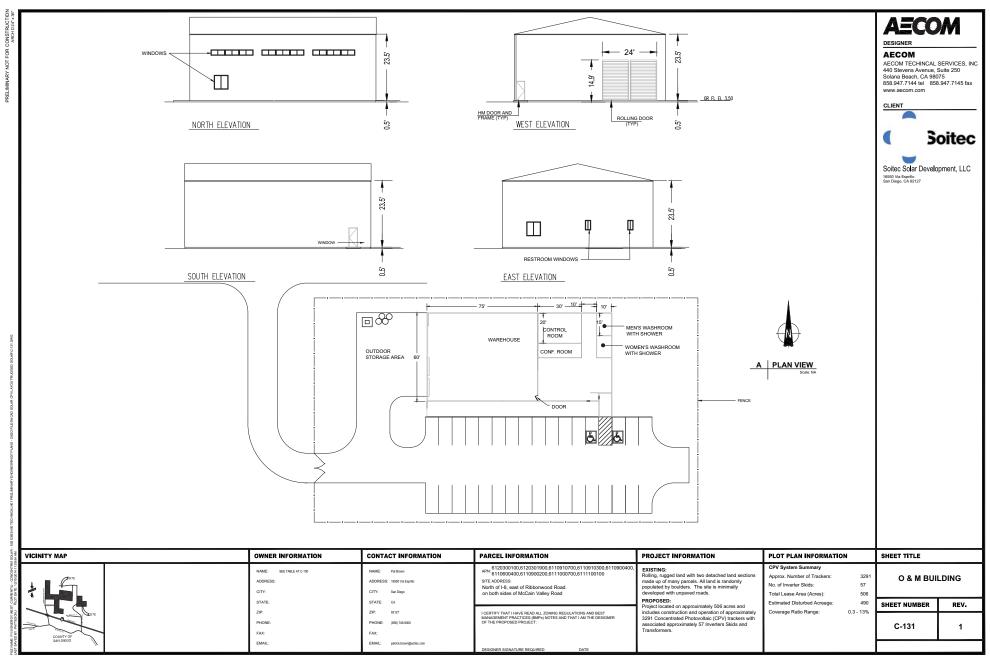




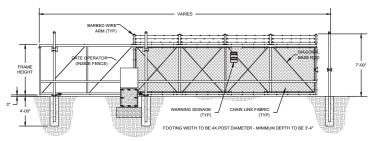

1 DETAIL - GATE
SINGLE MOTORIZED SLIDING GATE NT:

* 4* DIAMETER POST FOR GATE LEAF LENGHT 35'-0" AND LESS

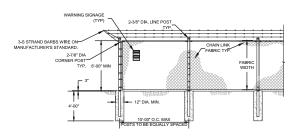

3 DETAIL - CHAIN LINK FENCE


FENCE NOTES:

- 1. CHAIN LINK FABRIC SHALL BE 2" MESH NO.9 GAGE WERE SECURITY FASTED TO LINE
- POSTS AND RAILS.WIRE FASTENERS AND THE CLIPS SHALL BE NO.11 GAGE

 2. WIRE.CONCRETE FOOTINGS SHALL HAVE TOPS CROWNED AT GROUND LEVEL.
- 3. CHAIN LINK FENCE TO BE FITTED WITH UV- RESISTANT MESH FABRIC, COLOR PER
- CUSTOMER REQUEST.
- ELECTRICAL SAFETY SIGNAGE TO BE PLACED ALONG PERIMETER.



2 WARNING SIGNAGE

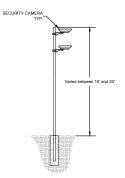

4 DETAIL - SECURITY CAMERA POLE

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Soitec

Soitec Solar Development, LLC 16550 Via Esprillo San Diego, CA 92127

- 602128								
K SOLAR	VICINITY MAP	OWNER INFORMATION	CONTACT INFORMATION	PARCEL INFORMATION	PROJECT INFORMATION	PLOT PLAN INFORMATION	SHEET TITLE	
RRENTU - CONCENTRE F DATE: 12/16/2014 12:0	* L =	NAME: SEE TABLE AT C-100 ADDRESS: CITY:	NAME: Pat Brown ADDRESS: 16550 Via Egyrläo CITY: San Diego	API 5120300100.6120301900.6110910700.6110910300.6110900400, APIN 6110800400.61109002000,6111000700.61111100100 SITE ADDRESS: North of I-B, east of Ribbonwood Road. on both sides of McCain Valley Road	Rolling, rugged land with two detached land sections made up of many parcels. All land is randomly populated by boulders. The site is minimally developed with unpaved roads.	CPV System Summary Approx. Number of Trackers: 3291 No. of Inverter Skids: 57 Total Lease Area (Acres): 506	FENCE/SEC CAMERA ELE DETAI	EVATION
EST CU		STATE:	STATE: CA		PROPOSED: Project located on approximately 506 acres and	Estimated Disturbed Acreage: 490	SHEET NUMBER	REV.
D BY: PATTES CN.	SALVE	ZIP: PHONE: FAX:	ZIP: 92127 PHONE: (858) 746 5000 FAX:	I CERTIFY THAT I HAVE READ ALL ZONING REGULATIONS AND BEST MANAGEMENT PRACTICES (RIMP) NOTES AND THAT I AM THE DESIGNER OF THE PROPOSED PROJECT:	includes construction and operation of approximately 3291 Concentrated Photovoltaic (CPV) trackers with associated approximately 57 Inverters Skids and Transformers.	Coverage Ratio Range: 0.3 - 13%	C-132	1
N. S.	SAN DNEGO	EMAIL:	EMAIL: patrick.brown@soitec.com					

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DESIGNER

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AECOM TECHINCAL SERVICES, INC 440 Stevens Avenue, Suite 250 Solana Beach, CA 98075 858.947.7144 tel 858.947.7145 fax www.aecom.com

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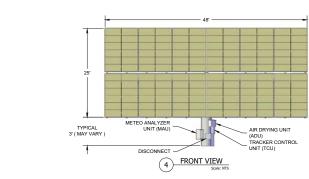


Soitec

Soitec Solar Development, LLC 16550 Via Esprillo San Diego, CA 92127







	3	SIDE
ICINITY MAP		OWNE
SITE STATE		NAME: ADDRESS CITY: STATE:

TCU -

30' MAX.

1 STOW MODE VIEW
Scale: NTS

OWNER INFORMATION	CONTACT INFORMATION
NAME: SEE TABLE AT C-100	NAME: Pat Brown
ADDRESS:	ADDRESS: 16550 Via Esprillo
CITY:	CITY: San Diego
STATE:	STATE: CA
ZIP:	ZIP: 92127
PHONE:	PHONE: (858) 746-9000
FAX:	FAX:
EMAIL:	EMAIL: patrick.brown@soitec.com

PARCEL INFORMATION
AB1233001 00.6 123021900 81 10910700,6110910300,6110900400 APNN
I CERTIFY THAT I HAVE READ ALL ZONING REGULATIONS AND BEST MANAGEMENT PRACTICES (BMPs) NOTES AND THAT I AM THE DESIGNER OF THE PROPOSED PROJECT:

	PROPOSED:
ALL ZONING REGULATIONS AND BEST MPs) NOTES AND THAT I AM THE DESIGNER	Project located on approximately 506 acres and includes construction and operation of approximal 3291 Concentrated Photovoltaic (CPV) trackers w associated approximately 57 Inverters Skids and Transformers.

PROJECT INFORMATION

EXISTING:
Rolling, rugged land with two detached land sections made up of many parcels. All land is randomly populated by boulders. The site is minimally developed with unpaved roads.

PLOT PLAN INFORMATION				
CPV System Summary				
Approx. Number of Trackers:	3291			
No. of Inverter Skids:	57			
Total Lease Area (Acres):	506			
Estimated Disturbed Acreage:	490			
Coverage Patio Pange:	0.2 12%			


TRACKER ELEVATION DETAIL			
SHEET NUMBER REV.			
C-133 1			

SHEET TITLE

IN ACCORDANCE WITH SECTION 507.2.2 IN TITLE 9, DIVISION 6, CHAPTER 1 OF THE SAN DIEGO COUNTY CODE:

- 1. THE SUPPLY OUTLET SHALL BE AT EAST 4 INCHES IN DIAMETER FROM THE BASE OF THE TANK TO THE POINT OF OUTLET AT THE FIRE DEPARTMENT CONNECTION. THE FIRE DEPARTMENT CONNECTION SHALL BE AT LEST ONE 4-MON HATIONAL STANDARD THREAD (MALE, REDUCE TO ONE 2/s INCH NATIONAL STANDARD THREAD (MALE). REDUCE TO ONE 2/s INCH NATIONAL STANDARD THREAD (MALE).
- 2. THE LOCATION OF THE FIRE DEPARTMENT OUTLET TO BE DETERMINED ON THE PLOT PLAN WHEN SUBMITTED TO THE FIRE DEPARTMENT. CONSIDERATION WILL BE GIVEN TO TOPOGRAPHY, ELEVATIONS, AND DISTANCE FROM STRUCTURES, DRIVEWAY ACCESS, PREVAILING WINDS, ETC.
- 3. THE OUTLET SHALL BE LOCATED ADJACENT TO THE FIRE ACCESS ROAD.

WATER TANK

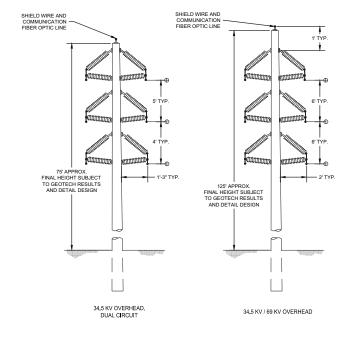

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DESIGNER

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3									
0.28 PM	VICINITY MAP	OWNER INFORMATION	CONTACT INFORMATION	PARCEL INFORMATION	PROJECT INFORMATION	PLOT PLAN INFORMATION	SHEE	ET TITLE	
DATE: 12/15/2014 12:1	★ L C m	NAME: SEE TABLE AT C-100 ADDRESS: CITY:	NAME: Pat Brown ADDRESS: 16550 Via Esprillo CITY: San Diego	APN: 6120300100,6120301900,6110910700,6110910300,6110900400, APN: 6110600400,6110900200,6111000700,6111100100 SITE ADDRESS: North of I-8, east of Ribbornwood Road. on both sides of McClain Valley Road	EXISTING: Rolling, rugged land with two detached land sections made up of many parcels. All land is randomly opulated by boulders. The site is minimally developed with unpaved roads.	CPV System Summary Approx. Number of Trackers: 32! No. of Inverter Skids: 57 Total Lease Area (Acres): 50	34.3	WATER TAI 5kV / 69kV O\ ELEVATION D	/ERHEAD
PLOT		STATE: ZIP:	STATE: CA ZIP: 92127		PROPOSED: Project located on approximately 506 acres and	Estimated Disturbed Acreage: 49 Coverage Ratio Range: 0.3 - 139	PHEE	ET NUMBER	REV.
ED BY: PATTES CN.	COUNT OF SHIPPERS	ZIP- PHONE: FAX:	ZIP: 92127 PHONE: (858) 746-9000 FAX:	I CERTIFY THAT I HAVE READ ALL ZONING REGULATIONS AND BEST MANAGEMENT PRACTICES (BMP.) NOTES AND THAT I AM THE DESIGNER OF THE PROPOSED PROJECT:	includes construction and operation of approximately 3291 Concentrated Photovoltaic (CPV) trackers with associated approximately 57 Inverters Skids and Transformers.	Coverage Ratio Range: 0.3 - 13		C-134	1
ST SAVE	SANDIEGO //	EMAIL:	EMAIL: patrick brown@soltec.com	DESIGNER SIGNATURE REQUIRED DATE					

E P.10 BRIRGY WEST CURRENTU. - CONCENTRX SOARF - 602 2003 A00 TECHNICALAD I PRELMINARY ENGINEERING PLAND BY PLA ED BY: PATTES CNJ – PLOT DATE: 121/6/2014 12.10.20 PM

PRELIMINARY GRADING AND DRAINAGE NOTES

GRADING NOTES

- ALL GRADING SHALL CONFORM OF THE REQUIREMENTS OF THE GRADING ORDINANCE SECTIONS 87.101 THROUGH 87.804 OF THE SAN DIEGO COUNTY CODE OF REGULATORY ORDINANCES.
- 2. A REGISTERED CYL EXGINEER IS REQUIRED TO SUPERVISE NITTILLATION OF THE FILL KEYNINY AND ALL FILL BENCHING AND COMPACTION. A DOLL SECROT WITH CHOMPACT MANTESTS REQUIRED FOR ALL FILL THAT SO VIGIT EYE NOTE THE PLAT FOR ALL SECRIT AND A WAS THESE (3) COPIES OF THE COMPACTION REPORT COMPLETED BY A SOILS ENGINEER SHALL BE SUBMITTED PRIOR TO ROUGH GRADE APPOVIL.
- 3. ALL FILL MATERIAL SHALL BE COMPACTED AS NOTED.
- 4. NATURAL DRAINAGE SHALL NOT BE DIVERTED OR CONCENTRATED ONTO ADJACENT PROPERTY.
- MAINTAIN 116 (MINIMUM) SLOPE AWAY FROM ALL BUILDINGS FOR AT LEAST 5'.
 ALL GRADING DETAILS SHALL BE IN CONFORMANCE WITH THE FOLLOWING SAN DIEGO COUNTY DESIGN STANDARDS OR REGIONAL STANDARD
 PROMISSION.

 - D. D-40 RIP RAP ENERGY DISSIPATER

 - F. D-82 DEBRIS FENCE G. DS-09 FENCING CUT BANKS
- REGARDLESS OF WHICH BMPS ARE IMPLEMENTED THE FACE OF ALL CUT AND FILL SLOPES IN EXCESS OF 3' VERTICAL HEIGHT SHALL BE PLANTED
 AND MAINTAINED WITH A GROUND COVER OR OTHER PLANTING TO PROTECT THE SLOPES AGAINST EROSION AND INSTABLITY. PLANTING SHALL
 COMMENCE AS SOON AS SLOPES ARE COMPLETED. ALL PLANTING MUST HAVE A PERMANENTLY INSTALLED RIGHATON SYSTEM.
- 9. REQUIRED SLOPE RATIOS ARE AS FOLLOWS:
 - A. CUTS 1.5:1 FOR MINOR SLOPES (UP TO 15' VERTICAL HEIGHT)
 B. CUTS 2-1 FOR MAJOR SLOPES (OVER 15' VERTICAL HEIGHT)
 C. FILLS 2:1 (MAXIMUM) FOR ALL FILL SLOPES
- 18. NOTHINESTANGED THE MANUAL STANDARDS SET CONTIN IN THE GRADING PRODUNCE, AND NOTHINESTANDARD. THE APPROVAL OF THESE GRADING PRANTS IT OF OWNER AND FEMBRICE ARE RESENDED. FOR THE PROPERTY LINE AS TO ENDANGER ANY ADDITING OF DAMAGE TO CALECUST PROPERTY. SAY PRESEND SHALL EXCANTE SO CLOSE TO THE PROPERTY LINE AS TO ENDANGER ANY ADDITING STREET OR SIDEWALK, OR THE FUNCTION OF ANY SWAMED EXPORAL SYSTEM OR ANY OTHER PUBLIC OR PRANTE PROPERTY.
- 11. THE DIRECTION OF PLANNING AND LIKE USE MAY TAPPOSE CONDITIONS THAT AND EXPLOSABLE VIBCESSARY TO PREVENT THE CONDITION OF A MISSIANCE ON INJURIED TO PRESIDENCE OF TO PIEUE OF PROVIDE REPORTED YEAR OF BEDIETION MAY AND BOMOSTY OR AND CONDITIONS TO ANY GRACING PERMIT WHEN SUCH MODIFICATIONS OR ADDITIONS ARE RESOURNELLY INDICESSARY TO PREVENT THE CREATION OF A NUISANCE OR MIZSIAND TO PREVEN OR TO THE USE OF PRIVILET PROPERTY. SUCH CONDITIONS MAY INCLUDE BUT HER NOT LIMITED THE FOLLOWING:
 - A. IMPROVEMENT OF EXISTING GRADING TO CONFORM WITH THE GRADING ORDINANCE, AND;
 B. REQUIREMENTS FOR FENCING OF EXCAVATIONS OR FILLS THAT WOULD OTHERWISE BE HAZARDOUS, AND;
 C. ADEQUATE DUST CONTROL MEASURES.
- 12. ALL OPERATIONS CONDUCTED ON THE PREMISES, INCLUDING THE WARMING UP, REPAIR, ARRIVAL, DEPARTURE OR RUANING OF TRUCKS, EARTH MOVING EQUIPMENT, CONSTRUCTION EQUIPMENT OR ANY OTHER ASSOCIATED GRADING EQUIPMENT SHALL BE LIMITED TO THE PERIOD BETWEEN 7,000M AND EXOPM MONDAY THROUGH SATURDAY. NO EARTH MOVING OR GRADING SHALL BE CONDUCTED ON SURDAYS OR HOLIDAYS.
- 13. THE CONTRACTOR SHALL VERIFY THE EXISTENCE AND LOCATION OF ALL UTILITIES BEFORE COMMENCING WORK. NOTICE OF THE PROPOSED WORK SHALL BE PROVIDED TO THE FOLLOWING AGENCIES:
 - A. SAN DIEGO GAS AND ELECTRIC (800) 422-4133 B. PACIFIC BELL (800) 422-4133
- C. CATV (800) 422-4133 D. WATER UTILITY (800) 422-4133 E. SEWER UTILITY (800) 422-4133
- 14. APPROVAL OF THESE PLANS BY THE DIRECTOR OF PLANNING AND LAND USE DOES NOT AUTHORIZE ANY WORK OR GRADING TO BE PERFORMED UNTIL THE PROPERTY OWNER'S PERMISSION IS OBTAINED, RIGHT TO ENTRY FORM COMPLETED AND VALID GRADING PERMIT ISSUED.
- 15. THE ISSUANCE OF A GRADING PERMIT SHALL CONSTITUTE AN AUTHORIZATION TO PERFORM ONLY THAT WORK WHICH IS DESCRIBED OR SHOWN ON THE GRADING PERMIT APPLICATION AND APPROVED GRADING PLANS. ALL WORK SHALL BE PERFORMED IN ACCORDANCE WITH ANY CONDITIONS IMPOSED BY THE DIRECTOR OF PLANING AND LAND USE AND IN ACCORDANCE WITH THE GRADING GRIDINANCE.
- 16. ROADS ARE CLASSIFIED ON THE DRAWING AS THE FOLLOWING:
- A. PRIMARY ACCESS ROAD 20FT WIDE GRADED ROAD IMPROVED TO CARRYING A 50,000LBS VEHICLE.
 B. SECONDARY ACCESS ROAD 30FT WIDE GRADED ROAD WITH AN 18FT LANE CAPABLE OF CARRYING A
 15,000LBS VEHICLE AND A 12FT LANE CAPABLE TO CARRYING A 50,000LBS VEHICLE.

THE GRADING FOR THE SITE SHALL INCLUDE THE CLEARING AND GRUBBING FOR A 19,698,600 SQ.FT. AREA THE GROUNG FOR THE SITE STRUCK WIGGED THE CARRYSTATE OF THE GROWN MODEL (DTM) TIED TO THE COSSS GRID. THE DTM WAS CREATED IN CONJUNCTION WITH AN AREAL TOPOGRAPHICAL BURNEY AT 295 CALE WITH 0.5 FOOT CONTOUR INTERVALS PREFORMED JANUARY 2012.

AREAS DESIGNATED AS "SPECIAL FUEL MOD ZONE" ARE TO BE CLEARED OF EXISTING VEGETATION, THEN COVERED WITH LANDSCAPING RIC AND WEIGHTED DOWN USING AS SURFACING MATERIAL OF CRUSHED STONE

(20.	EARTHWORK QU/	NTITIES:	~~~~)
(EXCAVATION:	28,410	CUBIC YARDS	4
(FILL:	28,410	CUBIC YARDS	4
}	IMPORT:		CUBIC YARDS	4
}	EXPORT:	0	CUBIC YARDS	4
7				

PRELIMINARY GRADING PLAN NOTE

THIS PLAN IS PROVIDED TO ALLOW FOR FULL AND ADEQUATE DISCRETIONARY REVIEW OF A PROPOSED DEVELOPMENT PROJECT. THE PROPERTY OWNER ACKNOWLEDGES THAT ACCEPTANCE OR APPROVACE TO HIS PLAN DOES NOT CONSTITUTE AN APPROVACE TO PERFORM ANY GRADING SHOWN HEREON, AND ACTIVITY. OF A PROPERMINANT OF PREMISSION BEFORE COMMENCED WITH A CONTINUE AND ACTIVITY.

STORMWATER MANAGEMENT NOTES

- DURING THE RAINY SEASON FROM OCTOBER 1ST TO APRIL 30TH THE
 AMOUNT OF EXPOSED SOIL ALLOWED AT ONE TIME SHALL NOT EXCEED THAT
 WHICH CAN BE ADEQUATELY PROTECTED WITHIN 48 HOURS OF A PREDICTED
 RAIN.
- 125% OF ALL NEEDED BMP MATERIALS SHALL BE STORED ONSITE YEAR-ROUND TO ALLOW FULL DEPLOYMENT AND INSTALLATION WITHIN 48 HOURS OF A PREDICTED RAIN.
- THE PROCESTY OWNER SHALL COMEY WITH ALL APPLICABLE STORMWITES REGLATIONS OF ALL TIMES. THE MISS WHITH YARD WERE RECOMPORATED NOT THIS PLAN SHALL BE IMPLEMENTED AND MINTAINED TO PREVENT OWNER ERRORM AND TO PREVENT DISCUSSED SOFT OF THE RESPONSIBILITY OF THE DESTRUCTION OF THE STEEL MAINTENANCE OF BURN IN THE RESPONSIBILITY OF THE BURN WITH THE STEEL THE SHAPE AND THE THE STATE OF THE STATE OWNER OF THE STATE OF THE STATE OWNER OF THE STATE OWNER OWNER OWNER OF THE STATE OWNER OWNE
- PERIMETER SEDIMENT CONTROL BMPs SHALL BE INSTALLED IMMEDIATELY AFTER THE AREA TO BE GRADED IS BRUSHED OR CLEARED, BUT PRIOR TO THE START OF GRADING OPERATIONS.
- EROSION CONTROL BMPs USED FOR SLOPE STABILIZATION SHALL BE INSTALLED AS SOON AS THE FINISHED SLOPES ARE COMPLETE.
- 6. A PERIMETER BMP INSPECTION IS REQUIRED ON THE FIRST DAY OF GRADING WHERE AN EXISTING STORMWATER CONVEYANCE CROSSES OVER A PLANNED SECONDARY SERVICE ROAD, THE ROAD SHALL BE GRADED AND MAINTAINED AS A FORD.
- RIP RAP SHALL BE PLACED AT ALL LOCATIONS WHERE ONE DRAINAGE FEATURE (SUCH AS A DITCH OR A SWALE) DRAINS INTO A LARGER DRAINAGE FEATURE.
- DIP SECTIONS SHALL BE COMPOSED OF 6° OF REINFORCED STRUCTURAL CONCRETE SLABS, WHICH SHALL BE DESIGNED TO WITHSTAND AND CONVEY HUNDRED (100) YEAR FREQUENCY STORM.

	PROPERTY OWNER INFORMATION						
NAME:	Waterstone Support Foundation Inc. John Gibson	Frankie@hibodeau	VistalDaks@usiness@ark John Gibson	Harmony@cove@artners John Gibson			
ADDRESS:	2925 Professional Pl #200	39990@oadrunner&n	1000FloneerWay	10000Figneer@Way			
CITY:	Colorado Springs	Boulevard	ElEajon	tittajon			
STATE:	co	CA	CA	CA			
ZP:	80904	91905	92020	92020			
PHONE:	(619) 440-7424	(619) 766-9105	(519) 440-7424	(619) 440-7424			
APN# 's and (Acreage)	611-110-01 (63.71)	511-091-07 (42:39), 512-030-19 (43:43), 512-030-01 (33:10)	611-090-04 (22.62), 611-091-03 (14.62), 611-090-04 (1.63), 611-090-04 (1.63),	611-100-07 (214.84)			







Soitec Solar Development, LLC

4250 Executive Square, Suite 770

AECOM

AECOM

AECOM TECHINCAL SERVICES, INC 440 Stevens Avenue, Suite 250 Solana Beach, CA 98075 858.947.7144 tel 858.947.7145 fax www.aecom.com

CONTACT INFORMATION ADDRESS: 4250 Executive Square, Suite 770 La Jolla, CA (858) 652-4423 TELEPHONE NUMBER: ---(24 HOUR CONTACT NUMBER) SITE A.P.N. NUMBER: SEE DRAWINGS C-202 THROUGH C-205 ADJACENT A.P.N NUMBERS SEE DRAWINGS C-202 THROUGH C-205

GRADING ON ADJACENT PARCELS PROPERTY OWNER CERTIFICATION I CERTIFY THAT I HAVE READ AND UNDERSTAND THE STORMWATER MANAGEMENT NOTES AND THE GRADING NOTES: OWNER'S SIGNATURE (REQUIRED)


DISTURBED AREA CALCS PAD + SLOPES: DRIVEWAY: ___ IF ≥1 AC, PROVIDE WDID#:

PLAN CHECK/PERMITS BUILDING PERMIT PLAN CHECK NUMBER: ENGINEER OF WORK NAME: Savas E. Kolankaya DATE:

pre No. C 43628

П	PRIVATE CONTRACT					
	COUNTY OF SAN DIEGO DEPARTMENT OF PLANNING AND LAND USE					
	PRELIMINARY GRADING PLAN FOR: 80 MW SOLAR SYSTEM					
П	RUGGED SOLAR LLC					
П	SHEET NUMBER C-200	REV.		SHEET:	OF SHEETS: 7	
-	APPROVED DIRECTOR OF PLANNING AND LAND USE			GRADING PERMIT NUMBER:		
- 1	en	DATE:				

SDC PDS RCVD 12-16-14 3300-12-007

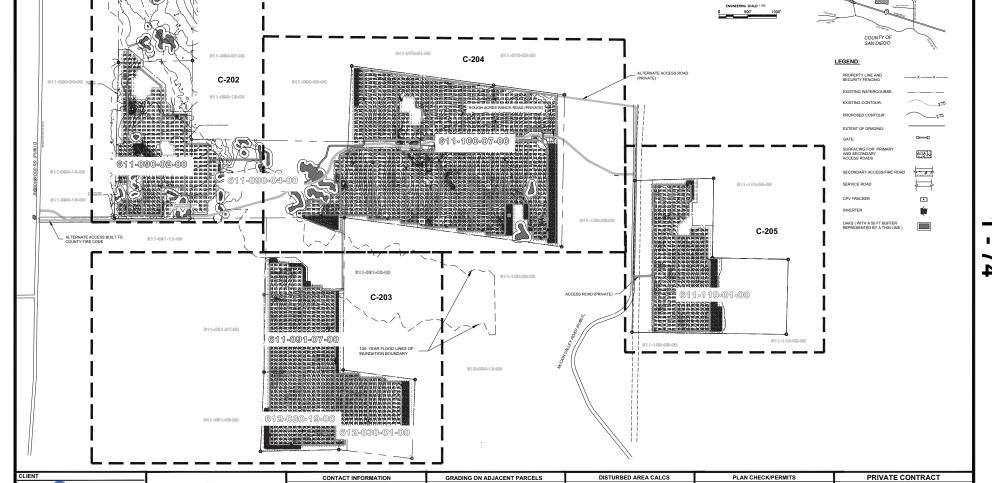

PROPERTY OWNER CERTIFICATION

I CERTIFY THAT I HAVE READ AND UNDERSTAND THE STORMWATER MANAGEMENT NOTES AND THE GRADING NOTES:

PAD + SLOPES: __

IF ≥1 AC, PROVIDE WDID#:

NAME: C:\USERS\OROZCOG\DESKTOP\SO\TEC SO\

611-060-04-00

AECOM

AECOM TECHINCAL SERVICES, INC 440 Stevens Avenue, Suite 250

Solana Beach, CA 98075 858.947.7144 tel 858.947.7145 fax

AECOM

www.aecom.com

Soitec

Soitec Solar Development, LLC

4250 Executive Square, Suite 770 San Diego, CA 92037-9178 PAT BROWN

LA JOLLA, CA

ADDRESS: 4250 EXECUTIVE SQUARE, SUITE 770

612-030-01, 611-100-07, 611-110-01,

RELIMINARY

COUNTY OF SAN DIEGO DEPARTMENT OF PLANNING AND LAND USE

RUGGED SOLAR LLC

PRELIMINARY GRADING PLAN FOR: 80 MW SOLAR SYSTEM

ENGINEER OF WORK

Savas E. Kolankaya DATE:

RCE NO: _____ C 43628

TELEPHONE NUMBER: (510) 260-6544

VICINITY MAP