SPRING VALLEY COLORED ELEVATIONS AND SIGN PACKAGE

11X17 COLORED EXHIBITS SHEET INDEX:

- COLORED ARCI	HITECTURE ELEVATIONS WITH MATERIALS
- ED1.0	PROPOSED BUILDING D ELEVATIONS
-ED2.0	PROPOSED BUILDING D TRASH ENCLOSURE
- EE1.0	EXISTING BUILDING E ELEVATIONS
- EE2.0	PROPOSED BUILDING E ELEVATIONS
- EE3.0	PROPOSED BUILDING E TRASH ENCLOSURE
- EF1.0	PROPOSED BUILDING F ELEVATIONS
- EF2.0	PROPOSED BUILDING F TRASH ENCLOSURE
- EG1.0	PROPOSED BUILDING G ELEVATION
- EG2.0	PROPOSED BUILDING G TRASH ENCLOSURE
- SIGN DEVELOP	MENT PACKAGE
-SA-1	EXISTING TENANT A SIGN ELEVATIONS
-SA-2	EXISTING TENANT B SIGN ELEVATIONS
-SA-3	EXISTING TENANT C SIGN ELEVATIONS
-CVS-1	PROPOSED BUILDING D (CVS) SIGN PLAN
-CVS-2	PROPOSED BUILDING D (CVS) SIGN ELEVATIONS
-SF-1	EXISTING BUILDING E (SMART AND FINAL) SIGN ELEVATIONS

CVS-1 PROPOSED BUILDING D (CVS) SIGN ELEVATIONS
-CVS-2 PROPOSED BUILDING D (CVS) SIGN ELEVATIONS
-SF-3 EXISTING BUILDING E (SMART AND FINAL) SIGN ELEVATIONS
-SF-3 PROPOSED BUILDING E (SMART AND FINAL) SIGN ELEVATIONS
-CFA-1 PROPOSED BUILDING F (CHICK-FIL-A) SIGN PLAN
-CFA-2 NOT USED
-CFA-3 PROPOSED BUILDING F (CHICK-FIL-A) SIGN ELEVATIONS
-CFA-4 PROPOSED BUILDING F (CHICK-FIL-A) SIGN ELEVATIONS
-CFA-5 PROPOSED BUILDING F (CHICK-FIL-A) SIGN INFO
-CFA-6 PROPOSED BUILDING F (CHICK-FIL-A) SIGN INFO
-CFA-7 PROPOSED BUILDING F (CHICK-FIL-A) SIGN INFO
-CFA-10 PROPOSED BUILDING F (CHICK-FIL-A) SIGN INFO
-CFA-11 PROPOSED BUILDING F (CHICK-FIL-A) SIGN INFO
-CFA-12 PROPOSED BUILDING F (CHICK-FIL-A) SIGN INFO
-CFA-11 PROPOSED BUILDING F (CHICK-FIL-A) SIGN INFO
-CFA-12 PROPOSED BUILDING F (CHICK-FIL-A) SIGN INFO
-CFA-12 PROPOSED BUILDING F (CHICK-FIL-A) SIGN INFO

- SIGN DEVELOPMENT PACKAGE continued.

0	EVELO: IIIE: I / IO	TO TOP CONTINUES.
	-SBMT 01	PROPOSED BUILDING G SIGN (STARBUCKS) PLAN
	-SBMT 02	PROPOSED BUILDING G (STARBUCKS) SIGN ELEVATIONS
	-SBMT 03	PROPOSED BUILDING G (STARBUCKS) SIGN INFO
	-SBMT 04	PROPOSED BUILDING G (STARBUCKS) SIGN INFO
	-SBMT 05	PROPOSED BUILDING G (STARBUCKS) SIGN INFO
	-SBMT 06	PROPOSED BUILDING G (STARBUCKS) SIGN INFO
	-SBMT 07	PROPOSED BUILDING G (STARBUCKS) SIGN INFO
	- SBMT 08	PROPOSED BUILDING G (STARBUCKS) SIGN INFO
	-SBMT 09	PROPOSED BUILDING G (STARBUCKS) SIGN INFO
	-SBMT 10	PROPOSED BUILDING G (STARBUCKS) SIGN INFO
	-SBMT 11	PROPOSED BUILDING G (STARBUCKS) SIGN INFO
	-SBMT 12	PROPOSED BUILDING G (STARBUCKS) SIGN INFO
	-SBMT 13	PROPOSED BUILDING G (STARBUCKS) SIGN INFO
	-SBMT 14	PROPOSED BUILDING G (STARBUCKS) SIGN INFO
	-SBMT 15	PROPOSED BUILDING G (STARBUCKS) SIGN INFO
	-SBMT 16	PROPOSED BUILDING G (STARBUCKS) SIGN INFO
	-SBMT 17	PROPOSED BUILDING G (STARBUCKS) SIGN INFO
	-SBMT 18	PROPOSED BUILDING G (STARBUCKS) SIGN INFO
	-SBMT 19	PROPOSED BUILDING G (STARBUCKS) SIGN INFO
	-M-1	EXISTING MONUMENT SIGN 25'
	-M-2	EXISTING MONUMENT SIGN 35'
	-M-3	EXISTING MONUMENT SIGN 18'
	-LI-1	POLE LIGHT ELEVATIONS

PROJECT ADDRESS:

DATE: 04 20 2020

935 SWEETWATER ROAD Spring Valley, CA 91977 PROJECT NO: 16350

PREPARED BY:

ZAAP, INC.

2900 FOURTH AVENUE #204 SAN DIEGO, CA 92103 619-233-6450 WWW.ZAAP.BIZ SHEET NUMBER

TS-1








ADJACENT RETAIL SPACE



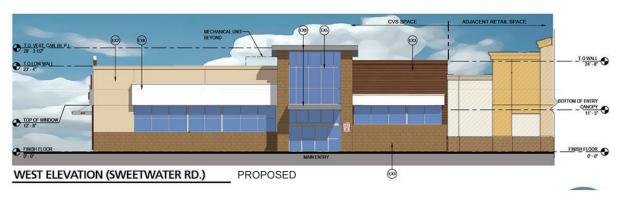

Material Mark	Material: Description	
EX1	WAINSCOT / PILASTER BASE COLOR: RCP - "EL RANCHO"	
EX2	PLASTER / EIFS FINISH COLOR: INTERACTIVE CREAM: SW 6113	
EX3	VINTAGEWOOD, PANEL SYSTEM COLOR: CEDAR, FINISH: TEXTURED	
EX4	PLASTER / EIFS FINISH COLOR: DOVER WHITE: SW 6386	
EXS	STOREFRONT SYSTEM COLOR: CLEAR ANODIZED	
EX6	PLASTER / EIFS FINISH COLOR: 9433 80 STO WHITE	
EX7	VERTICAL CEDAR SLATS ENCLOSURE	
EX8	ALUMINUM FASCIA COLOR: CLEAR ANODIZED	

NOTE: COLOR ELEVATIONS

DUE TO LIMITATIONS OF THE PRINTING PROCESS, SURFACE TEXTURE OF MATERIALS, ETC., THE COLORS SHOWN ON THIS DRAWING WILL VARY, COLORS AND MATERIALS SHOWN ARE APPROXIMATE AND ARE TAKEN FROM SITE PHOTOS OF EXISTING CONDITIONS.

PROJECT ADDRESS:

935 SWEETWATER ROAD Spring Valley, CA 91977 PROJECT NO: 16350

PREPARED BY:

ZAAP, INC. 2900 FOURTH AVENUE #204

SAN DIEGO, CA 92103 619-233-6450 WWW.ZAAP.BIZ SHEET NUMBER


ED1.0 BLDG D PROPOSED


DATE: 10-23-2019

elevations

SHOPPING CENTER - SPRING VALLEY



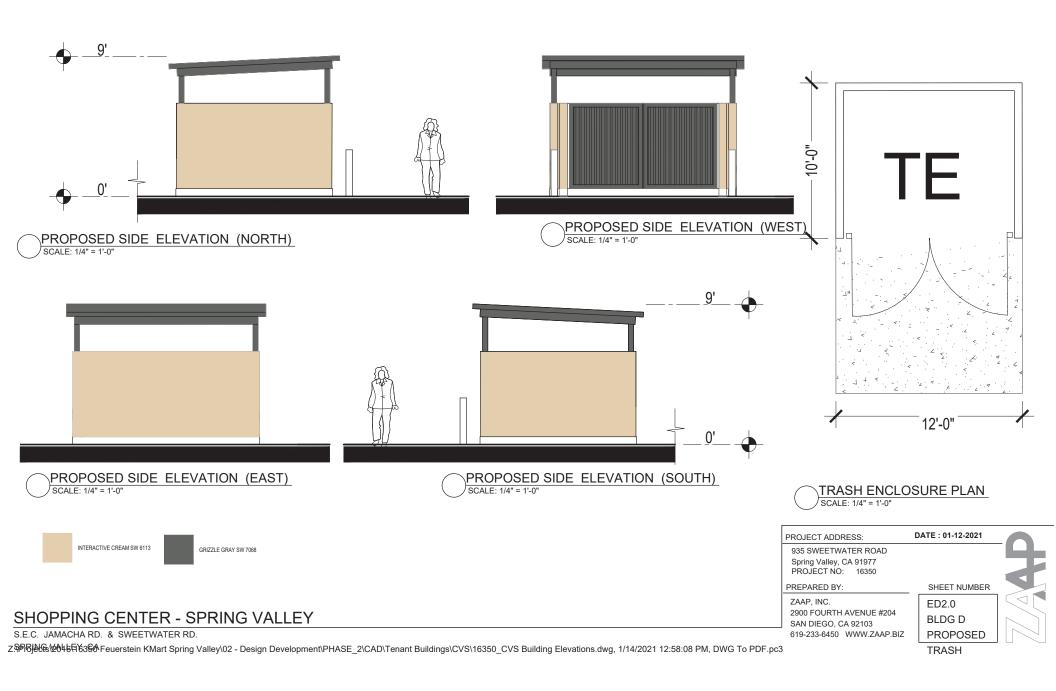

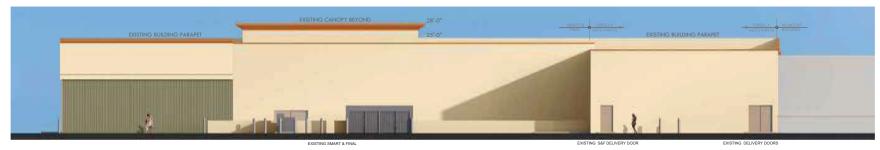

EAST EXISTING ELEVATION



NORTH - EXISTING EXTERIOR ELEVATION



WEST - EXISTING EXTERIOR ELEVATION

EXISTING ELEVATIONS

S.E.C. JAMACHA RD. & SWEETWATER RD. SPRING VALLEY, CA

SHOPPING CENTER - SPRING VALLEY

PROJECT ADDRESS:

DATE: 10-23-2019

935 SWEETWATER ROAD Spring Valley, CA 91977 PROJECT NO: 16350

PREPARED BY:

ZAAP, INC.

2900 FOURTH AVENUE #204 SAN DIEGO, CA 92103 619-233-6450 WWW.ZAAP.BIZ SHEET NUMBER

EE1.0 BLDG E EXISTING ELEVATIONS





EAST - EXISTING EXTERIOR ELEVATION



NORTH - EXISTING EXTERIOR ELEVATION WITH NEW O'REILLY SIGNAGE

PROPOSED: 73.87 SF PER COUNTY CODE = 51x1.5 = 76.5 SF MAX SIGN AREA



WEST - EXISTING EXTERIOR ELEVATION WITH NEW O'REILLY SIGNAGE

PER COUNTY CODE = 143X1.5 = 214.5 SF MAX SIGN AREA (PROPOSED 186.37SF) PER COUNTY CODE= 49X1.5= 73.5 SF MAX (PROPOSED 69.28SF)



EXISTING 1) Dunn Edwards DE6178 Boutique Beige



EXISTING 2) Dunn Edwards DE6222 Weather Board



EXISTING 3) Dunn Edwards DEA164 Autumn Bark



EXISTING 4) Cultured Stone - Natural Ledgestone










BLDG E PROPOSED ELEVATIONS

S.E.C. JAMACHA RD. & SWEETWATER RD.

SPRING VALLEY, CA

EXTERIOR COLORS

EE2.0

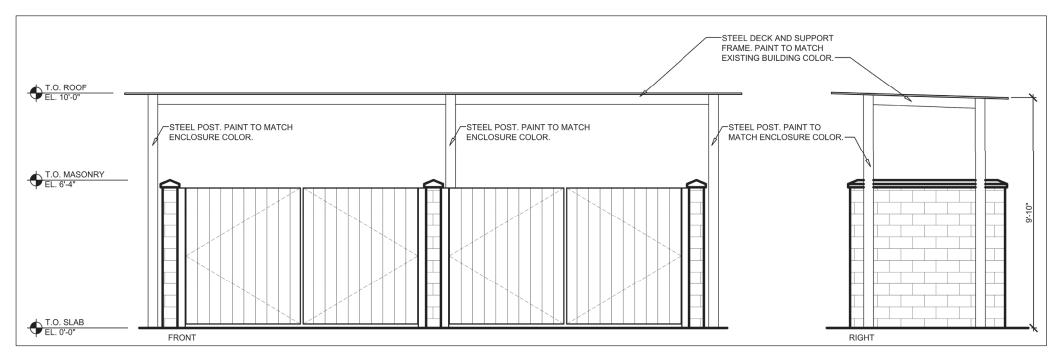

SIDE ELEVATION (SOUTH)
SCALE: 3/32" = 1'-0"

O'REILLY PROPOSED TRASH ENCLOSURE ELEVATIONS


SHOPPING CENTER - SPRING VALLEY

S.E.C. JAMACHA RD. & SWEETWATER RD.

H\$PRJ\\\\G\S\\\Z\\\D\\Tenant Buildings\Oreilly\16350_O'reilly\16350_O'reilly Trash.dwg, 12/5/2019 1:44:27 PM, DWG To PDF.pc3





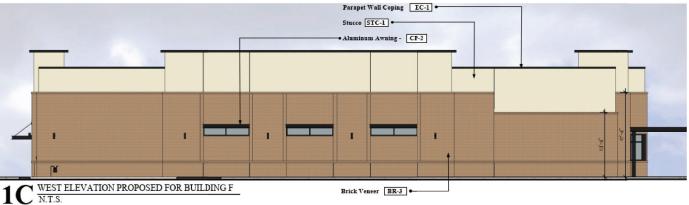



NOTES:

1. BUILDNIG SIGN ON SOUTH ELEVATION TO BE NON-ILLUMINATED.

2. SHOULD ROOFTOP UNITS BE VISIBLE FROM THE PUBLIC RIGHT OF WAY THEN THEY SHALL BE SCREENED



 $1B \tfrac{\text{SOUTH ELEVATION PROPOSED FOR BUILDING F}}{\text{N.T.S.}}$

SHOPPING CENTER - SPRING VALLEY

S.E.C. JAMACHA RD. & SWEETWATER RD. SPRING VALLEY, CA



		E	NTITLEMENTS_FINISH SCHEDULE - E	XTERIOR		
MARK	DESCRIPTION	MANUFACTURER	MODEL NAME	MODEL NUMBER	COLOR	NOTE
EXTERIO	R					
BR-3	BRICK VENEER	H.C. MUDDOX BRICK	MODULAR		SPANISH MOSS	MORTAR: ARGOS SAN TAN
BR-4	BRICK VENEER	BORAL BRICK	MODULAR		V100	MORTAR: ARGOS SAN TAN
BR-A	BRICK VENEER (PRIMARY)		MODULAR			*SEE APPROVED BRICK ALTERNATES
BR-B	BRICK VENEER (ACCENT)		MODULAR			*SEE APPROVED BRICK ALTERNATES
CP-1	CANOPY METAL FASCIA		DURA COAT	DC19ST-2703	DARK BRONZE	OIL RUBBED BRONZE METALLIC TEXTURE PVD
CP-2	CANOPY METAL DECK				WHITE	SMOOTH WHITE, HIGH GLOSS
EC-1	PARAPET WALL COPING	DUROLAST / EXCEPTIONAL METALS			DARK BRONZE (MATTE)	
PT-9	EXTERIOR PAINT	SHERWIN WILLIAMS	SHER-CRYL HIGH PERFORMANCE ACRYLIC #866-350		DARK BRONZE	FINISH: SEMI-GLOSS
PT-100	EXTERIOR PAINT	SHERWIN WILLIAMS	SHER-CRYL HIGH PERFORMANCE ACRYLIC #B66-350	SW 2807	ROOKWOOD	REFUSE ENCLOSURE. FINISH: SEMI-GLOSS ON DOOR FRAMES, SATIN ON WALLS
PT-113	EXTERIOR PAINT	SHERWIN WILLIAMS	SHER-CRYL HIGH PERFORMANCE ACRYLIC #B66-350		DARK BRONZE	FINISH: SEMI-GLOSS
SC-1	STUCCO	sто	POWERWALL		PAINT TO MATCH DE6234 "SERENE THOUGHTS"	FINISH: SAND MEDIUM
ST-1	STOREFRONT	YKK	YES 45		DARK BRONZE (MATTE)	

PROJECT ADDRESS: DATE: 05-11-2020

935 SWEETWATER ROAD Spring Valley, CA 91977 PROJECT NO: 16350


PREPARED BY:


ZAAP, INC.


2900 FOURTH AVENUE #204 SAN DIEGO, CA 92103 619-233-6450 WWW.ZAAP.BIZ SHEET NUMBER

EF 1.0 BLDG F ELEV.




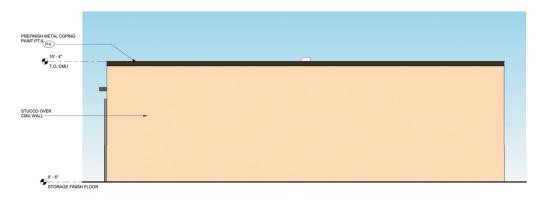

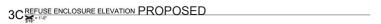


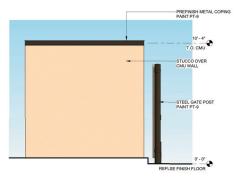

1CREFUSE ENCLOSURE ELEVATION PROPOSED

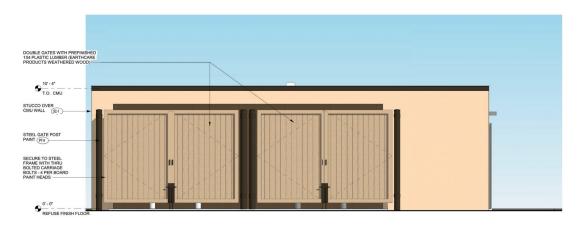



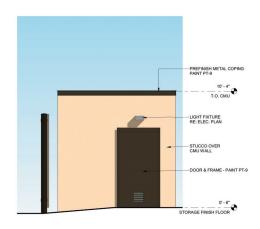

1A REFUSE ENCLOSURE ELEVATION PROPOSED

PROJECT ADDRESS: DATE : 10-21-2019

935 SWEETWATER ROAD
Spring Valley, CA 91977
PROJECT NO: 16350

PREPARED BY:

ZAAP, INC.
2900 FOURTH AVENUE #204
SAN DIEGO, CA 92103
619-233-6450 WWW.ZAAP.BIZ

VG TO PDF.pc3


DATE : 10-21-2019


SHEET NUMBER

EF2.0
TRASH
ENCLOSURE
PROPOSED

SHOPPING CENTER - SPRING VALLEY

S.E.C. JAMACHA RD. & SWEETWATER RD.

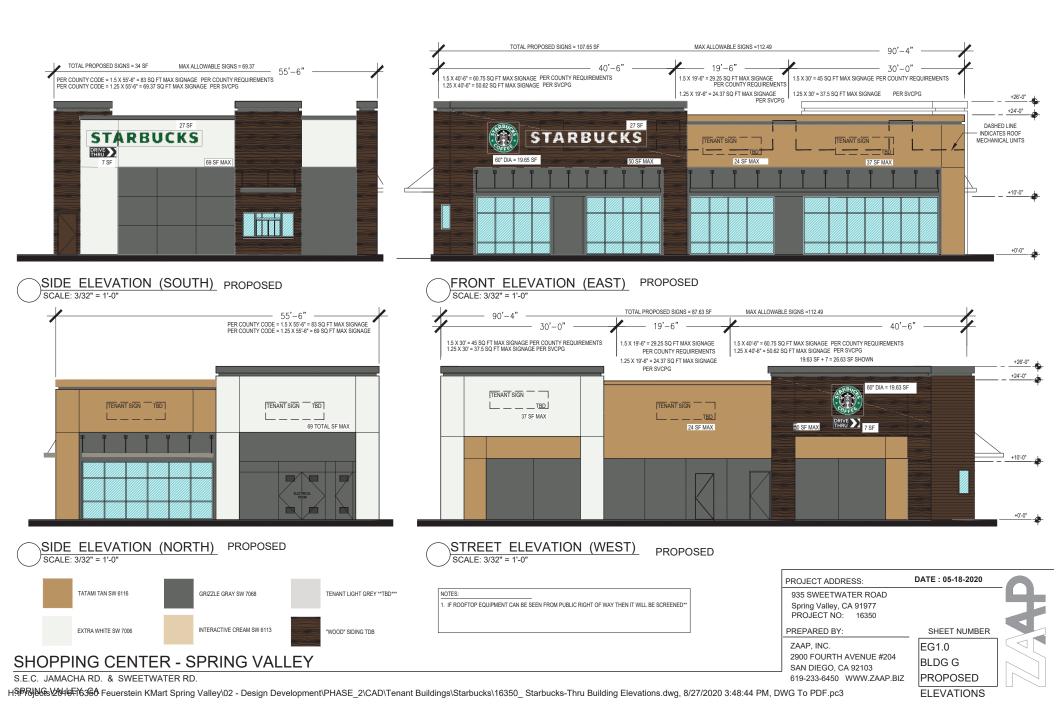

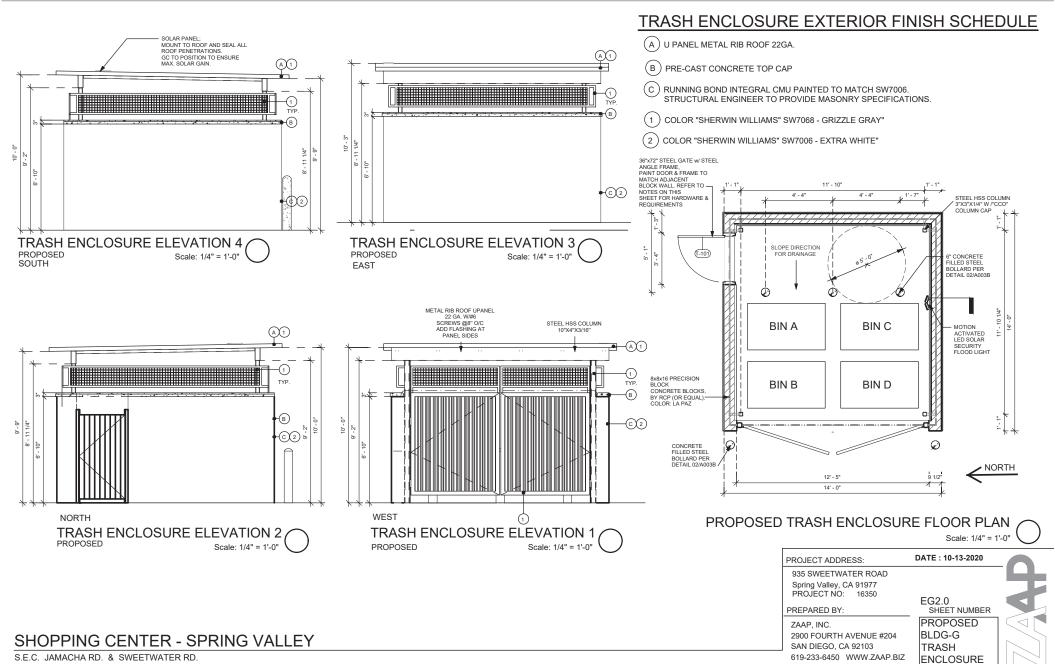

SPRING VALLEY SIGN PACKAGE

PROJECT ADDRESS:

DATE: 12/09/2019

935 SWEETWATER ROAD Spring Valley, CA 91977 PROJECT NO: 16350

PREPARED BY:

ZAAP, INC. 2900 FOURTH AVENUE #204 SAN DIEGO, CA 92103 619-233-6450 WWW.ZAAP.BIZ SHEET NUMBER

TS-2





EXISTING TENANT A, B, AND C SIGN ELEVATIONS

PROJECT ADDRESS:

DATE: 12/09/2019

935 SWEETWATER ROAD Spring Valley, CA 91977 PROJECT NO: 16350

PREPARED BY:

ZAAP, INC. 2900 FOURTH AVENUE #204 SAN DIEGO, CA 92103 619-233-6450 WWW.ZAAP.BIZ SHEET NUMBER

TS-3

SHOPPING CENTER - SPRING VALLEY





250 SQ FT TOTAL WALL SIGN ALLOWED 250 SQ FT TOTAL WALL SIGN USED



SPRING VALLEY SHOPPING CENTER

JANUARY 2019

www.zaap.biz

SHEET SA-1 EXISTING

Notes:

LANDLORD TO PROVIDE:

- ADEQUATE ACCESS BEHIND LOGO LETTERS FOR INSTALLATION AND MAINTENANCE, PER ARTICLE 600 OF THE N.E.C.
- ONE (1) 20 AMP 120V ISOLATED SIGN CIRCUIT AND JUNCTION BOX TO AREA BEHIND SIGN LETTERS CONNECTED TO THE ENERGY MANAGEMENT SYSTEM
- AT LEAST 1/2" THICK PLYWOOD BACKING BEHIND ALL E.I.F.S. WALL SYSTEMS FOR SIGN AND BANNER SUPPORT

SIGN FASCIA TO BE FREE OF JOINTS & REVEALS, AND OF A LIGHT COLOR (MINIMUM 80% L.R.V.) TO PROVIDE HIGH CONTRAST AND VISIBILITY FOR THE SIGN.

ALL COLORS ARE SUBJECT TO ROSS STORES, INC. REVIEW AND APPROVAL. COLOR APPEARANCE MAY BE ALTERED BY PRINTING, SEE APPROVED FINAL CONSTRUCTION DRAWINGS FOR COLOR SPECIFICATIONS.

IF ANY SIGNAGE PROPOSED IN THIS EXHIBIT IS ALTERED BY LOCAL GOVERNMENT AUTHORITIES, ROSS STORES INC. RESERVES THE RIGHT TO, AT NO COST, ADJUST ARCHITECTURAL FEATURES TO BEST ACCOMMODATE THE ALTERED SIGNAGE.

- A 68"H INDIVIDUAL "ROSS" PAN CHANNEL LETTER-LOK LOGO LETTERS:
 FACES: TUF-GLAS SG 21210-E4 MATTE BLUE RETURNS: 8"D ALUM. W/ WHITE FINISH TRIM CAP: 2" WHITE JEWELITE LETTER BACKS: ALUMINUM LEDS: INSEM SS-KDL2CL-RW 9000K WHITE MOUNTING: 1/4"-20 GALV. THRU BOLTS PEG OFF: 1/2" SPACERS
- (B) 28"H INDIVIDUAL "DFL" LOGO LETTERS: ALL CALLOUTS SAME AS "ROSS" EXCEPT: RETURNS: 5"D ALUM. W/ WHITE FINISH TRIM CAP: 1" WHITE JEWELITE
- 23"H X 46"W X 10"D DOUBLE-FACE INTERNALLY ILLUMINATED UNDER-CANOPY SIGN. SEE SHEET UC FOR DETAILS.

APPROVED

MAY 2 2 2019 05

PLANNING AND DEVELOPMENT SERVICES

PREVIOUSLY APPROVED EXISTING TENANT B



2055 ORESS 24 SF FOR CESS 128 SF 15 SF 18.6 SF SIGN AREA ALLOWED: ±195 SF SIGN AREA USED: ±192.82 SF

ROSS

UC SIGN: 1.9 X 3.8' = 7.22 SF

1057 solano ave. p.o. box 6153 albany, ca 94706-0153 510/526-0296 fax 526-6092

bill moore & associates





#2136 SPRING VALLEY
Un-named Shopping Center
SEC Sweetwater Rd. & Jamacha Rd.
Spring Valley, CA

drawn 11/09/18 sign area calc. 12/12/18

SCALE: 3/32" = 1'- 0"

SHEET SB-1 EXISTING

RB-H

Notes:

LANDLORD TO PROVIDE:

- ADEQUATE ACCESS BEHIND LOGO LETTERS AND CABINET FOR INSTALLATION AND MAINTENANCE, PER ARTICLE 600 OF THE N.E.C.
- ONE (1) 20 AMP 120V ISOLATED SIGN CIRCUIT AND JUNCTION BOXES TO AREA BEHIND SIGN LETTERS CONNECTED TO THE ENERGY MANAGEMENT SYSTEM
- AT LEAST 1/2" THICK PLYWOOD BACKING BEHIND ALL E.I.F.S. WALL SYSTEM FOR SIGN AND BANNER SUPPORT

SIGN FASCIA TO BE FREE OF JOINTS & REVEALS, AND OF A LIGHT COLOR (MINIMUM 75% L.R.V.) TO PROVIDE HIGH CONTRAST AND VISIBILITY FOR THE SIGN.

ALL COLORS ARE SUBJECT TO ROSS STORES, INC. REVIEW AND APPROVAL. COLOR APPEARANCE MAY BE ALTERED BY PRINTING, SEE APPROVED FINAL CONSTRUCTION DRAWINGS FOR COLOR SPECIFICATIONS.

IF ANY SIGNAGE PROPOSED IN THIS EXHIBIT IS ALTERED BY LOCAL GOVERNMENT AUTHORITIES, ROSS STORES INC. RESERVES THE RIGHT TO, AT NO COST, ADJUST ARCHITECTURAL FEATURES TO BEST ACCOMMODATE THE ALTERED SIGNAGE.

- (A) 60"H INDIVIDUAL "DD'6" PAN CHANNEL LOGO LETTERS: FACES: 732B 9G WHITE ACRYLIC SHEET W. VINYL OVERLAY 3M 3630-118 INTENSE MAGENTA (3M 3630-236 FOR TURQUOISE APOSTROPHE) RETURNS: 8"D ALUM. W/ WHITE FINISH TRIM CAP: 2" WHITE JEWELITE LETTER BACKS: ALUMINUM LED: PRINCIPAL 9000K COOL WHITE MOUNTING: 1/4"-20 GALVANIZED THRU BOLTS PEG OFF: 1/2" SPACERS
- B 30"H INDIVIDUAL "DISCOUNTS" PAN CHANNEL LOGO LETTERS: FACES: 732B 9G WHITE ACRYLIC SHEET W. VINYL OVERLAY 3M 3630-236 TURQUOISE RETURNS: 8"D ALUM. W. WHITE FINISH TRIM CAP: 2" WHITE JEWELITE LETTER BACKS: ALUMINUM LED. PRINICIPAL SOOOK NATURAL WHITE MOUNTING: 1/4"-20 GALVANIZED THRU BOLTS PEG OFF: 1/2" SPACERS
- C) 20"H X 21'-3"W X 5"D SINGLE-FACE INTERNALLYILLUMINATED CABINET SIGN:
 2" RETAINERS PAINTED TO MATCH MAGENTA,
 RETURNS: 8"D ALUMINUM PAINTED
 MAGENTA TO MATCH PMS #2415C
 MATTHEWS #MPOOBTS GLOSSY
 FACE: TRANSLUCENT SG WHITE SOLAR GRADE
 ACRYLIC WITH 3M 3630-118 INTENSE MAGENTA VINYL
 OVERLAY AND 11"H COPY WEEDED AWAY.
 LED: PRINCIPAL 300OK COOL WHITE
 MOUNTING: 1/4"-20 GALVANIZED THRU BOLTS
- D 12"H X 48"W X 10"D DOUBLE-FACE INTERNALLY-ILLUMINATED UNDERCANOPY SIGN, U.L. SEE SHEET UC FOR DETAILS.

APPROVED

MAY 2 2 2019 (X)

PLANNING AND DEVELOPMENT

PREVIOUSLY APPROVED EXISTING TENANT C



CODE COMPLIANT:

dds 54.5 9F **DISCOUNTS** 53.125 9F 35.27 9F

UNDER-CANOPY SIGN - 4 SF

146.89 SF USED







#5383 SPRING VALLEY

Unnamed Shopping Center 935 Sweetwater Road Spring Valley, CA 91977 drawn 11/15/18

SHEET SHEET SC-1

EXISTING

SPRING VALLEY SIGN PACKAGE BLDG D "CVS"

PROJECT ADDRESS:

DATE: 10-23-2019

935 SWEETWATER ROAD Spring Valley, CA 91977 PROJECT NO: 16350


PREPARED BY:

ZAAP, INC. 2900 FOURTH AVENUE #204 SAN DIEGO, CA 92103 619-233-6450 WWW.ZAAP.BIZ SHEET NUMBER

TS-4

Proposed Signage

......

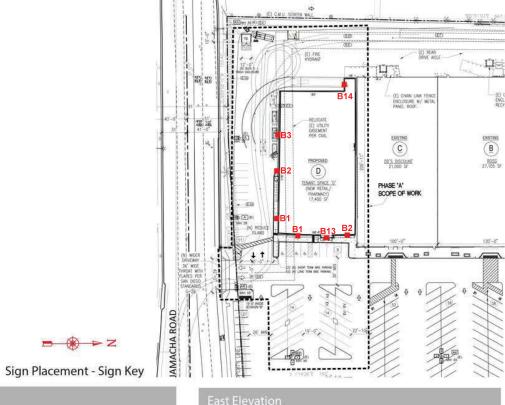

B1	♥CVS pharmacy	39 1/2"H x 371 11/16"W	101.96 SqF1
B2	drive-thru pharmacy	18 3/4"H x 238 5/8"W	31.07 SqFt
B3	drive-thru pharmacy	12"H x 72"W	6.0 SqFt
B3	drive-thru pharmacy	12"H x 121"W	10.0 SqFt
		Total Proposed	149.03 SqF1

B1	♥CVS pharmacy	39 1/2"H x 371 11/16"W	101.96 SqF1
B2	drive-thru pharmacy	18 3/4"H x 238 5/8"W	31.07 SqFt
B13	American Control of the Control of t	18 9/16"H x 14 1/2"W	1.87 SqFt
		Total Proposed	134.9 SqFt

East Elevation			
B14	receiving entrance	18"H x 24"W	3.0 SqFt
		Total Proposed	3.0 SqFt

619-233-6450 WWW.ZAAP.BIZ

8/////N |||

PROJECT ADDRESS: DATE : 10-23-2019


935 SWEETWATER ROAD
Spring Valley, CA 91977
PROJECT NO: 16350

PREPARED BY: SHEET NUMBER

ZAAP, INC.
2900 FOURTH AVENUE #204
SAN DIEGO, CA 92103

CVS 01

SHOPPING CENTER - SPRING VALLEY

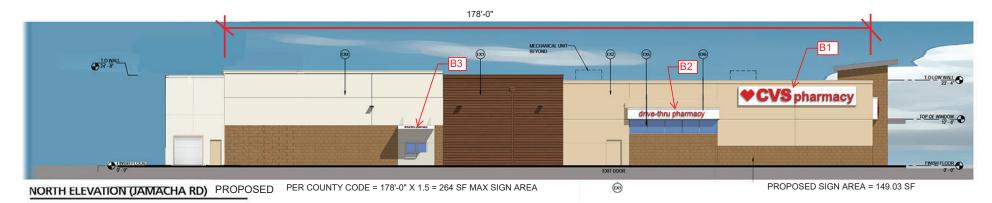





EXTERROR MATERIAL SCHEDULE Material Ma

NOTE: COLOR ELEVATIONS

DUE TO LIMITATIONS OF THE PRINTING PROCESS, SURFACE TEXTURE OF MATERIALS, ETC., THE COLORS SHOWN ON THIS DRAWING WILL VARY, COLORS AND MATERIALS SHOWN ARE APPROXIMATE AND ARE TAKEN FROM SITE PHOTOS OF EXISTING CONDITIONS.

PROJECT ADDRESS: DATE: 3/10/2021

935 SWEETWATER ROAD Spring Valley, CA 91977 PROJECT NO: 16350

PREPARED BY:

ZAAP, INC. 2900 FOURTH AVENUE #204 SAN DIEGO, CA 92103 619-233-6450 WWW.ZAAP.BIZ SHEET NUMBER

CVS 02

SHOPPING CENTER - SPRING VALLEY



SPRING VALLEY
SIGN PACKAGE
BLDG E
"SMART AND FINAL"
"O'REILLY"

PROJECT ADDRESS:

DATE: 10-23-2019


935 SWEETWATER ROAD Spring Valley, CA 91977 PROJECT NO: 16350

PREPARED BY:

ZAAP, INC. 2900 FOURTH AVENUE #204 SAN DIEGO, CA 92103 619-233-6450 WWW.ZAAP.BIZ SHEET NUMBER

TS-6



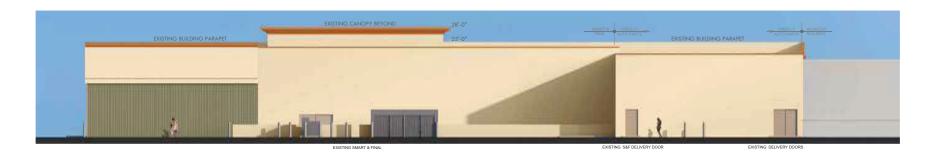



NORTH - EXISTING EXTERIOR ELEVATION



WEST - EXISTING EXTERIOR ELEVATION

EXISTING ELEVATIONS

SHOPPING CENTER - SPRING VALLEY

S.E.C. JAMACHA RD. & SWEETWATER RD. SPRING VALLEY, CA

PROJECT ADDRESS:

DATE: 10-23-2019

935 SWEETWATER ROAD Spring Valley, CA 91977 PROJECT NO: 16350

PREPARED BY:

ZAAP, INC.

2900 FOURTH AVENUE #204 SAN DIEGO, CA 92103 619-233-6450 WWW.ZAAP.BIZ SHEET NUMBER

SF1.0





EAST - EXISTING EXTERIOR ELEVATION



NORTH - EXISTING EXTERIOR ELEVATION WITH NEW O'REILLY SIGNAGE

PROPOSED: 73.87 SFPER COUNTY CODE = $51 \times 1.5 = 76.5 \text{ SF MAX SIGN AREA}$



WEST - EXISTING EXTERIOR ELEVATION WITH NEW O'REILLY SIGNAGE

PER COUNTY CODE = 143X1.5 = 214.5 SF MAX SIGN AREA (PROPOSED 186.37SF) PER COUNTY CODE= 49X1.5 = 73.5 SF MAX (PROPOSED 69.28SF)



EXISTING

1) Dunn Edwards DE6178 Boutique Beige



EXISTING
2) Dunn Edwards DE6222 Weather Board



EXISTING
3) Dunn Edwards DEA164 Autumn Bark



EXISTING
4) Cultured Stone - Natural Ledgestone





PREPARED BY:

Gregory J. Cary
Architect / Principal
gcary@caryarchitects.com
tel: 818.389 - 7415
3901 Foodbill BNd, Suite 106
La Crescenta, CA 91214

PROJECT ADDRESS:

935 SWEETWATER ROAD
Spring Valley, CA 91977
PROJECT NO: 16350

HEET TITLE: O'reilly Color Exterior Elevations SF2.0

S.E.C. JAMACHA RD. & SWEETWATER RD.

SPRING VALLEY, CA

EXTERIOR COLORS



Smart&Final

EXISTING SIGN

Sign Elevation Layout

Oty: One (1) Required Square Footage: 31.00 Scale: 1/2" = 1'-0"

Sign Elevation Layout

Square Footage: 134.37

EXISTING SIGN

Scale: 1/2" = 1'-0"

Existing single face illuminated channel letters to remain as is

Sign Elevation Layout Qty: One (1) Existing

Existing single face illuminated channel letters to remain as is

FRESH MEAT


B Sign Elevation Layout
Oty: One (1) Existing Square Footage: 18.63 Scale: 1/3" = 1'-0"

Existing single face illuminated channel letters to remain as is



Sign Elevation Layout Square Footage: 33.37 Qty: One (1) Existing Scale: 1/2" = 1'-0"

Existing single face illuminated channel letters to remain as is

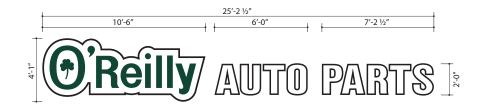

Qty: One (1) Required 10'-6"

Sign Elevation Layout Qty: One (1) Required Square Footage: 42.87 Scale: 1/4" = 1'-0"

Square Footage: 69.28

Scale: 1/4" = 1'-0"

PROJECT ADDRESS:

935 SWEETWATER ROAD Spring Valley, CA 91977

PROJECT NO: 16350

PREPARED BY:

ZAAP, INC. 2900 FOURTH AVENUE #204 SAN DIEGO, CA 92103 619-233-6450 WWW.ZAAP.BIZ SHEET NUMBER

DATE: 10-23-2019

SF3 0

SHOPPING CENTER - SPRING VALLEY

SPRING VALLEY
SIGN PACKAGE
BLDG F
"CHICK-FIL-A"

PROJECT ADDRESS:

DATE: 10-23-2019


935 SWEETWATER ROAD Spring Valley, CA 91977 PROJECT NO: 16350

PREPARED BY:

ZAAP, INC. 2900 FOURTH AVENUE #204 SAN DIEGO, CA 92103 619-233-6450 WWW.ZAAP.BIZ SHEET NUMBER

TS-7



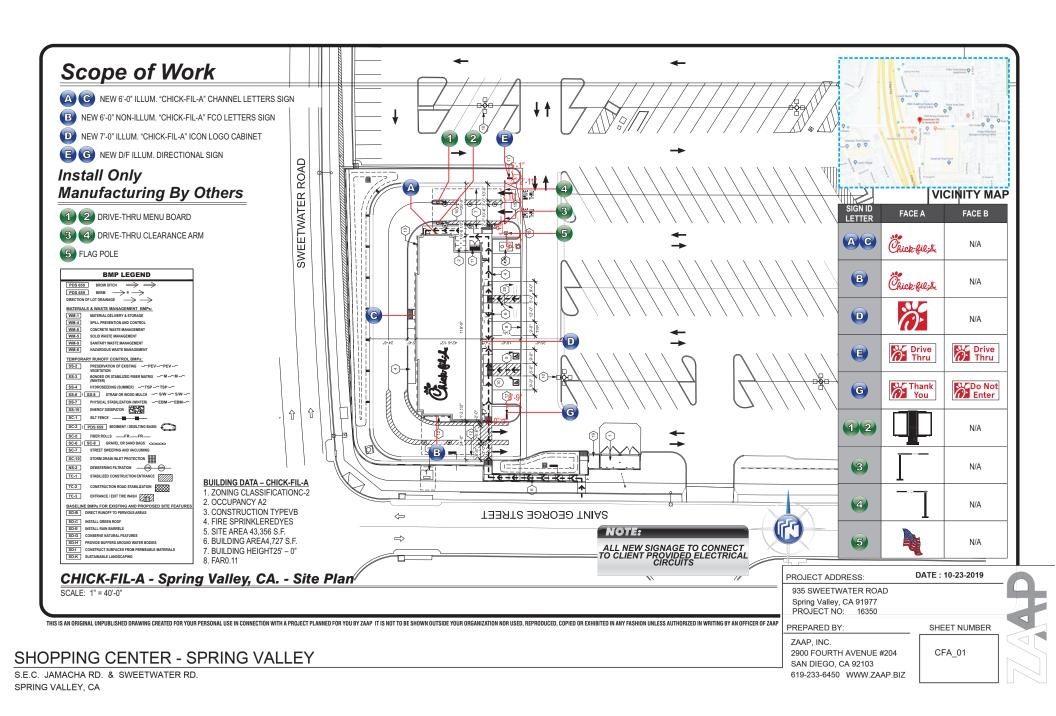

41'-2"

NEW 6'-0" ILLUM. "CHICK-FIL-A" CHANNEL LETTERS SIGN

PROPOSED WALL SIGN "A": 50.6 SF PER COUNTY CODE: 42X1.5=63 SF PER SVCPG: 42X1.25=52.5 SF

North Elevation

SCALE: 3/32" = 1'-0"



B NEW 6'-0" NON-ILLUM. "CHICK-FIL-A" FCO LETTERS SIGN

PROPOSED WALL SIGN "B": 50.6 SF PER COUNTY CODE: 42X1.5=63 SF PER SVCPG: 42X1.25=52.5 SF

South Elevation

SCALE: 3/32" = 1'-0"

THIS IS AN ORIGINAL UNPUBLISHED DRAWING CREATED FOR YOUR PERSONAL USE IN CONNECTION WITH A PROJECT PLANNED FOR YOU BY ZAAP IT IS NOT TO BE SHOWN OUTSIDE YOUR ORGANIZATION NOR USED, REPRODUCED, COPIED OR EXHIBITED IN ANY FASHION UNLESS AUTHORIZED IN WRITING BY AN OFFICER OF ZAAP

SHOPPING CENTER - SPRING VALLEY

S.E.C. JAMACHA RD. & SWEETWATER RD. SPRING VALLEY, CA

935 SWEETWATER ROAD

DATE: 10-23-2019

Spring Valley, CA 91977 PROJECT NO: 16350

PREPARED BY:

ZAAP, INC. 2900 FOURTH AVENUE #204 SAN DIEGO, CA 92103 619-233-6450 WWW.ZAAP.BIZ SHEET NUMBER

CFA 03 SIGN ELEV





THIS IS AN ORIGINAL UNPUBLISHED DRAWING CREATED FOR YOUR PERSONAL USE IN CONNECTION WITH A PROJECT PLANNED FOR YOU BY ZAAP IT IS NOT TO BE SHOWN OUTSIDE YOUR ORGANIZATION NOR USED, REPRODUCED, COPIED OR EXHIBITED IN ANY FASHION UNLESS AUTHORIZED IN WRITING BY AN OFFICER OF ZAAP

SHOPPING CENTER - SPRING VALLEY

S.E.C. JAMACHA RD. & SWEETWATER RD. SPRING VALLEY, CA

935 SWEETWATER ROAD Spring Valley, CA 91977 PROJECT NO: 16350

PREPARED BY:

ZAAP, INC. 2900 FOURTH AVENUE #204 SAN DIEGO, CA 92103 619-233-6450 WWW.ZAAP.BIZ SHEET NUMBER

CFA_04 SIGN ELEV



MOUNTING AND ELECTRICAL PENETRATIONS



RETURNS:

NEW 6'-0" ILLUM. "CHICK-FIL-A" CHANNEL LETTERS SIGN

Specifications:

S/F CUSTOM FABRICATED ALUMINUM CHANNEL LETTERS CONSTRUCTED OF .050 WITH .063 ALUMINUM BACKS.
ALUMINUM RETURNS MECHANICALLY FASTENED TO BACKS. INTERIOR OF SIGN TO BE PAINTED MATTE WHITE.

FACES: 3/16" #2793 RED ACRYLIC OR EQUIVALENT.

TRIM CAP: 1"X.125 TRUE RED JEWELITE TRIM CAP (ADHERED VIA

WELD ON RETURNS) 5" DEEP RETURNS PAINTED TO MATCH MOUNTING

3/8" SLEEVE ANCHORS WITH 1/2" ALUMINUM SPACERS. STANDOFF: REGISTERED:

3/16" ACRYLIC DISK WITH RETURNS PAINTED TO MATCH MOUNTING SURFACE. 3M 3632-53 CARDINAL RED AND

WHITE VINYL® APPLIED FIRST SURFACE. DISCONNECT: ELECTRICAL TOGGLE DISCONNECT SWITCH WITH

WATERPROOF BOOT

ILLUMINATION: RED LED LIGHTING WITH REMOTE TRANSFORMERS.

ALL WIRING & COMPONENTS TO MEET U.L. STANDARDS

R & H 2793 / 3M RED 3632-53 ☐ DUNN EDWARDS DE6234 SERENE THOUGHTS AREA: 50.61 SQ. FT.

note: per SVCPG the south elevation sign will not be illuminated.



PERSPECTIVE VIEW

CHICK-FIL-A S/F LED ILLUMINATED CHANNEL LETTERS

SCALE: 3/8" = 1'-0"

THIS IS AN ORIGINAL UNPUBLISHED DRAWING CREATED FOR YOUR PERSONAL USE IN CONNECTION WITH A PROJECT PLANNED FOR YOU BY NSMC. IT IS NOT TO BE SHOWN OUTSIDE YOUR ORGANIZATION NOR USED, REPRODUCED, COPIED OR EXHIBITED IN ANY FASHIOI

SHOPPING CENTER - SPRING VALLEY

S.E.C. JAMACHA RD. & SWEETWATER RD. SPRING VALLEY, CA

PROJECT ADDRESS:

DATE: 10-23-2019

935 SWEETWATER ROAD Spring Valley, CA 91977 PROJECT NO: 16350

PREPARED BY:


ZAAP, INC. 2900 FOURTH AVENUE #204 SAN DIEGO, CA 92103

619-233-6450 WWW.ZAAP.BIZ

SHEET NUMBER

CFA 05 SIGN INFO




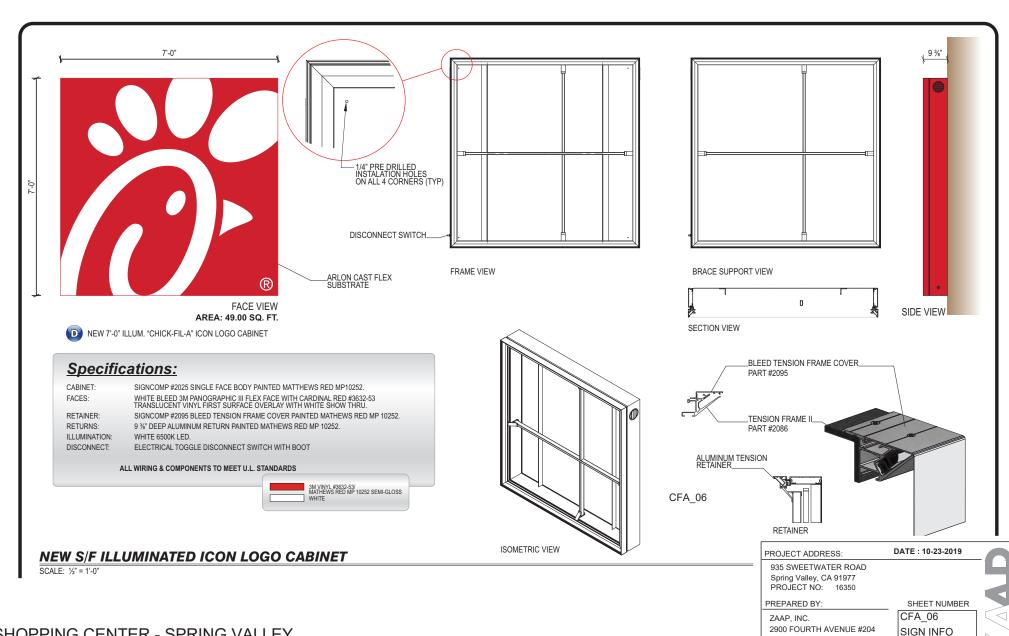

SAN DIEGO, CA 92103

619-233-6450 WWW.ZAAP.BIZ

SHOPPING CENTER - SPRING VALLEY

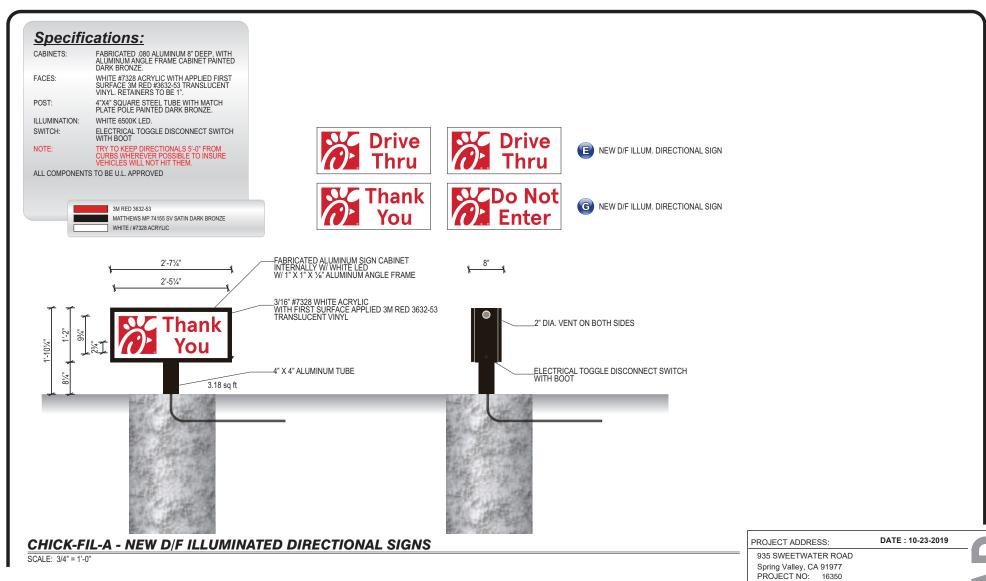


SHOPPING CENTER - SPRING VALLEY


S.E.C. JAMACHA RD. & SWEETWATER RD. SPRING VALLEY, CA


PREPARED BY:

ZAAP, INC. 2900 FOURTH AVENUE #204 SAN DIEGO, CA 92103 619-233-6450 WWW.ZAAP.BIZ SHEET NUMBER


CFA 07 SIGN INFO

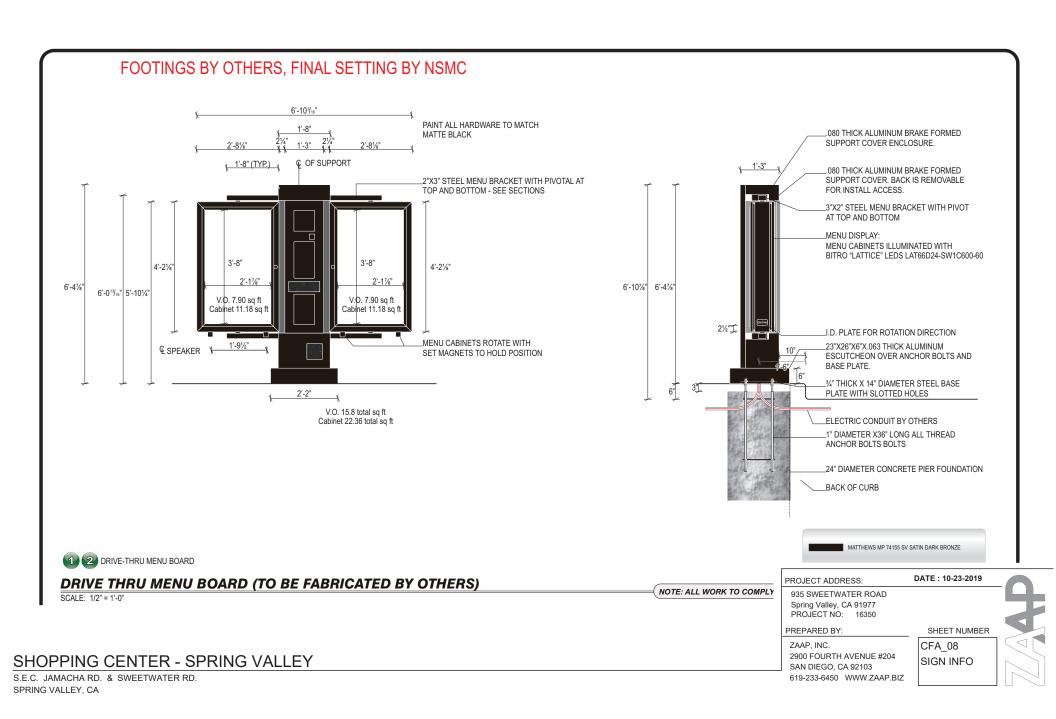

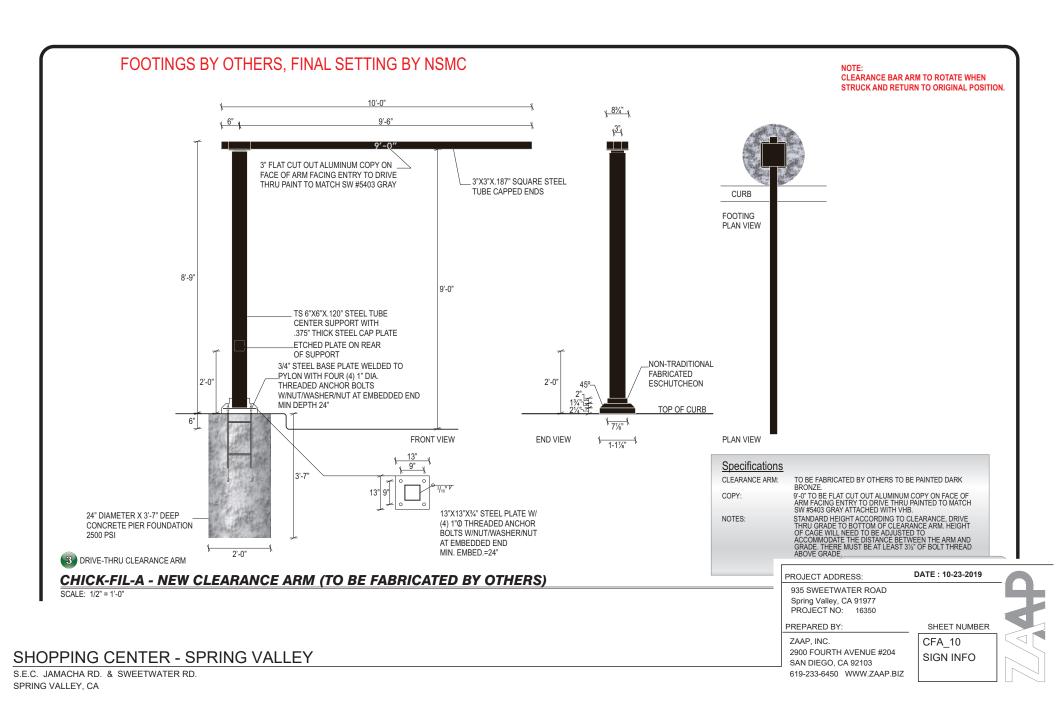

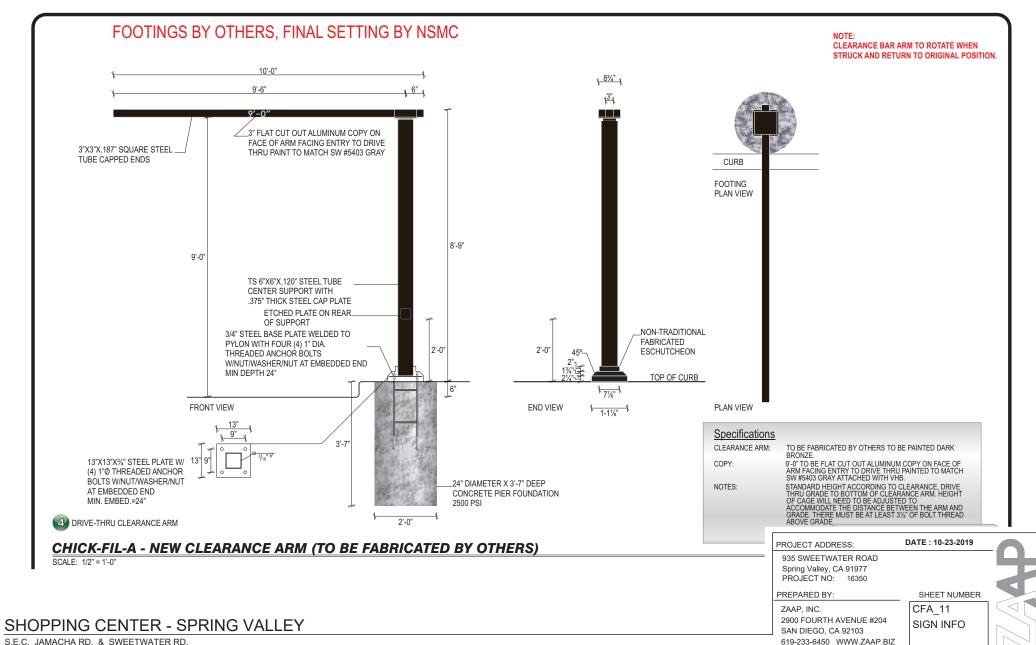

FOOTINGS BY OTHERS, FINAL SETTING BY NSMC

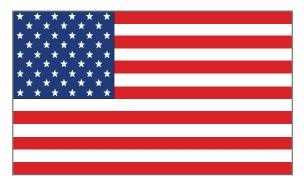

<u>Flag</u>


FOUNDATION SIZES

HEIGHT	Α	В	С	FLAG SIZE
20'	3'-6"	30"	24"	6'-10'
25'	3'-6"	30"	24"	6'-10'
30'	3'-6"	30"	24"	6'-10'
35'	4'-0"	36"	30"	6'-10'
40'	4'-6"	42"	36"	12'-18'
45'	5'-0"	48"	42"	12'-18'
50'	5'-6"	48"	42"	12'-18'

Size Chart

Ground sleeve and concrete installed by the general contractor

Pole installed on pre-installed ground sleeve by sign contractor

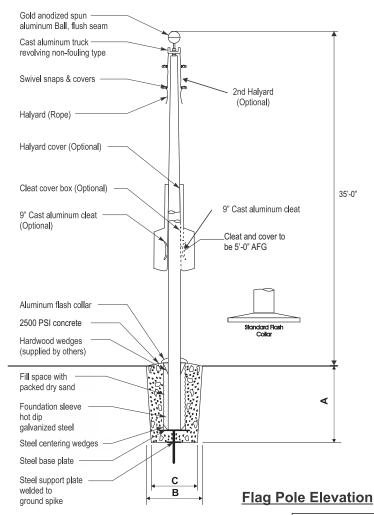



CFA-00108 - CFA FPL E(

PROJECT ADDRESS: DATE: 10-23-2019

935 SWEETWATER ROAD Spring Valley, CA 91977 PROJECT NO: 16350

PREPARED BY:

ZAAP, INC. 2900 FOURTH AVENUE #204 SAN DIEGO, CA 92103 619-233-6450 WWW.ZAAP.BIZ SHEET NUMBER

CFA_12 SIGN

SHOPPING CENTER - SPRING VALLEY



SPRING VALLEY
SIGN PACKAGE
BLDG G
" Starbucks "
MULTI TENANT

PROJECT ADDRESS:

SS: DATE: 10-23-2019


935 SWEETWATER ROAD Spring Valley, CA 91977 PROJECT NO: 16350

PREPARED BY:


ZAAP, INC. 2900 FOURTH AVENUE #204 SAN DIEGO, CA 92103 619-233-6450 WWW.ZAAP.BIZ SHEET NUMBER

TS-8



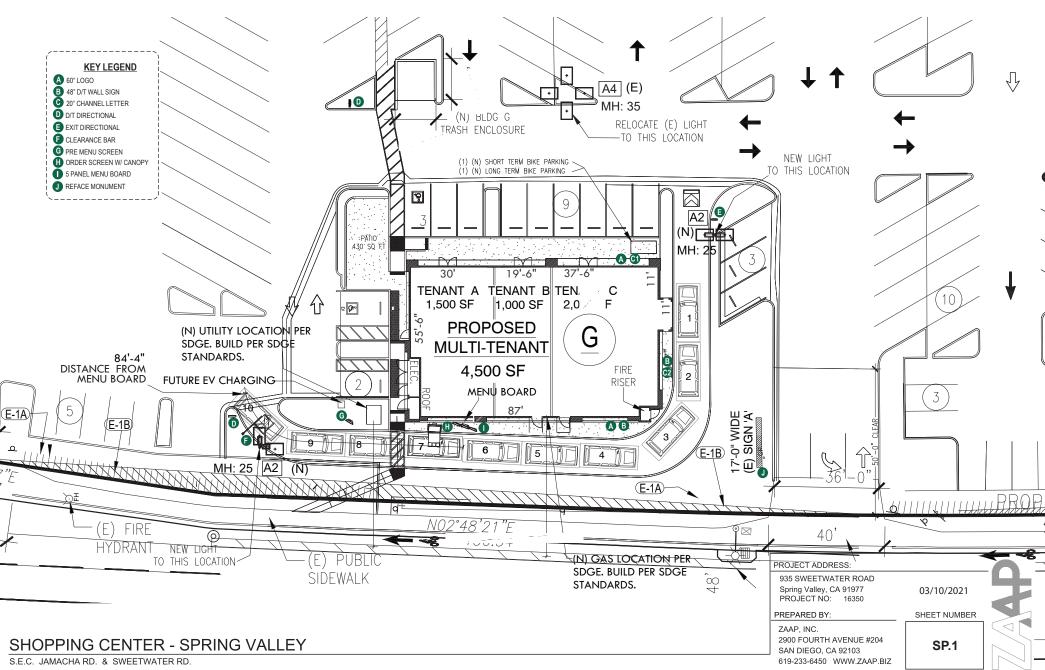


SPRING VALLEY, CA

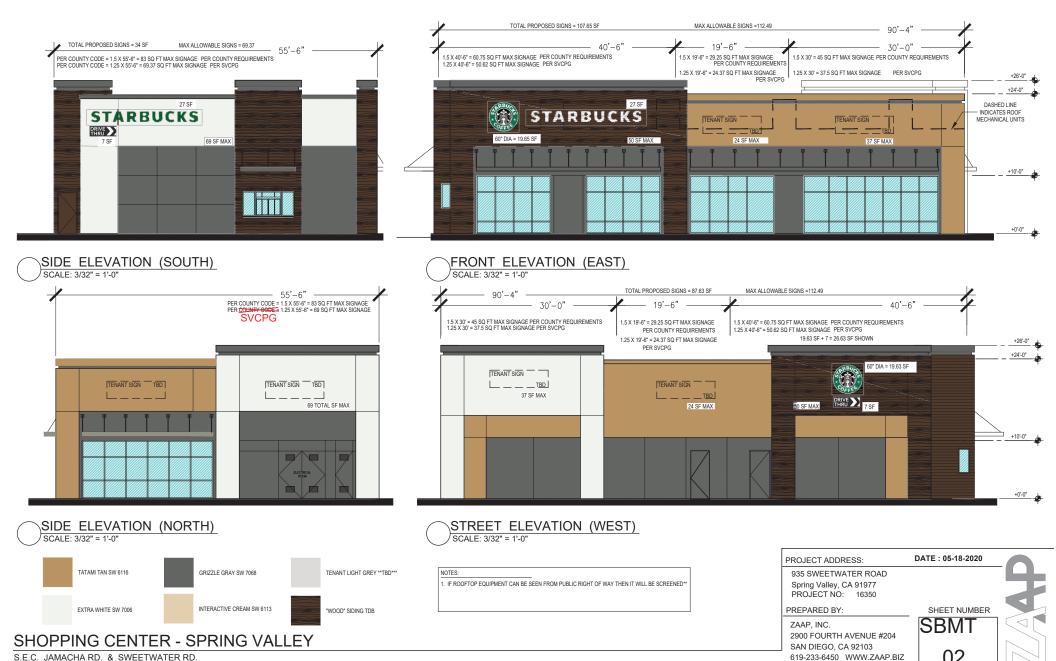

HSPRINGS/2016F16360 Feuerstein KMart Spring Valley\02 - Design Development\PHASE_2\CAD\Tenant Buildings\Starbucks\16350_ Starbucks-Thru Building Elevations.dwg, 8/27/2020 3:48:44 PM, DWG To PDF.pc3



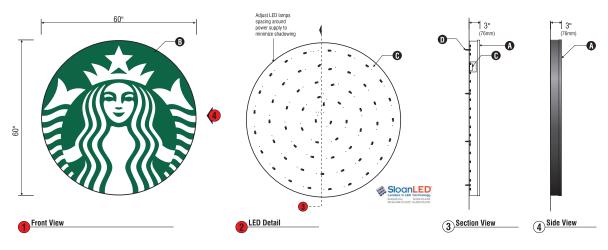

A 60" Illuminated Logo Disc - Wall Mounted ~ Qty (2)

Scale: 1/2"= 1'

SPECIFICATIONS:

- ♠ 60"(ts24mm) Single faced internally illuminated wall mount logo disk. Cabinet to be 3"(75mm) deep, fabricated aluminum sidewalls and back. Paint cabinet black polyurethane. Faces to be 3/16"(5mm) Acrylite 015-2GP. 1"(25mm) black trincap with square head screws retainer edding.
- Graphics of logo to be 1st surface 3M Translucent Scotchcal vinyl-Holly Green #3630-76. Siren to show thru White.
- Internally illuminated logo disc with Sloan Prism Enlightne white 6500k, laid out at 1.5 modules per foot, 6° on center installed to back of disk with self-contained power supply with J.L approved enclosure.

Flushed mounted to wood fascia with #14 Screws.

Sign must be approved by the National Electrical Code, Underwriters Laboratory, CUL, and all applicable local codes. Disconnect switch in primary to be within sight of sign (sign includes power supply enclosure). REP. NEC 110-3[B 160-2, 600-4, Primary electrical source 1/2"(13mm) conduit minimum) REP. NEC 600-6, 600-21 (provided by installer).





Disk 60in S/F Illuminated wall mount EVOLVED					
Size	Sq.Ft.	Sq.M.	Volts		
60" (1524mm)	19.62	1.82	120		

PROJECT ADDRESS:


935 SWEETWATER ROAD Spring Valley, CA 91977 PROJECT NO: 16350


PREPARED BY:

ZAAP, INC. 2900 FOURTH AVENUE #204 SAN DIEGO, CA 92103 619-233-6450 WWW.ZAAP.BIZ SHEET NUMBER

DATE: 10-23-2019



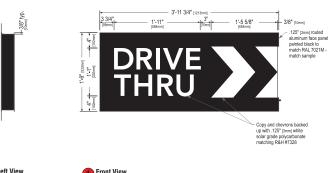

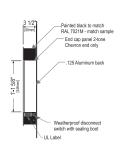


Left View

Front View



48" Illuminated Drive-Thru w/ Right Arrow - Wall Mounted ~ Qty (2)

Scale: 3/4"= 1'

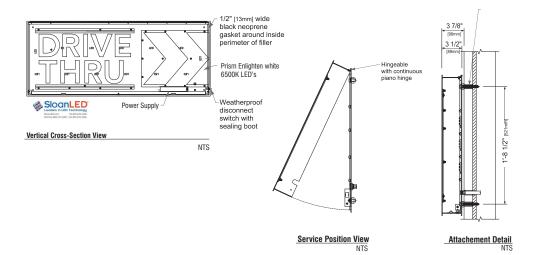

Sign Specifications:

- Cabinet:
 Fabricated .125* [8mm] aluminum housing painted black to match RAL 7021M with 3M #180-10 white viryl end cap as shown.
 Areas using black paint to match RAL 7021M shall have a max
- 20% gloss level, match sample.

 Back to be .125" [3mm] aluminum.

 Directional copy and chevrons backed up with .125" [3mm] white solar grade polycarbonate matching R&H #7328. All polycarbonate face elements to be mechanically retained.

 Interior aluminum surfaces of sign cabinet to be painted white with
- Lacryl Starbrite.

 Welded aluminum construction with no visible fasteners. Fasteners retaining the hinged face will be located on the bottom such that they are not visible. All fasteners used in the assembly of internal
- components shall be coated to prevent corrosion. · Internal structure of cabinet shall be per approved shop drawings.
- Internally illuminated logo disc with Sloan Prism Enlightne white 6500k, laid out at 1.5 modules per foot, 7" on center installed to back of disk with self-contained power supply with U.L approved enclosure.

- Sign must meet all regulations in the National Electric Code as well as any local or state electrical codes.
 As per NEC 600.6, sign is equipped with a service disconnect
- Sign must be listed as an Electric Sign per Underwriters
 Laboratories UL48 and/or CSA and bear the appropriate UL, CUL or CSA relevant certification marks.

 Primary power by electrical contractor per NEC.







These Drawings and Specifications are confidential and shall remain the sole property of Starbucks Corporation, which is the owner of the copyright in this work. They shall not be reproduced (in whole or in copyright in this work. They stain into be reproduced in whole of in-part), shared with third parties or used in any manner on other projects or extensions to this project without the prior written consent of Starbucks Corporation.

This drawing is a Design Development Document. Site specific modifications made under the responsible charge of the Architect and/or Engineer-of-Record will be required prior to using this document for Bidding, Permitting, or Construction.

ı	Size	Sq. Ft!	Sq. Ft?	Volts	Amps
	21" (533mm)	4.52	6.96	120	0.85

PROJECT ADDRESS:

935 SWEETWATER ROAD Spring Valley, CA 91977 PROJECT NO: 16350

PREPARED BY:

ZAAP, INC. 2900 FOURTH AVENUE #204 SAN DIEGO, CA 92103 619-233-6450 WWW.ZAAP.BIZ DATE: 10-23-2019


SHEET NUMBER SBM





C1 18" WHITE CHANNEL LETTERS ~ Qty (1)

SCALE: 3/8"=1"

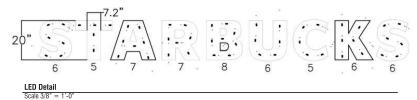



STARBUCKS SPECIFICATION:

- A Internally illuminated channel letters to be fabricated from 0.040 / 3003 aluminum with pre painted White interiors and painted Black polyurethane exteriors, 3"(76mm) deep. Letters backs to be .063 Black & White aluminum popriveted to sidewalls and sealed.
- B Faces to be 3/16" white acrylic faces with black trim cap retainer edging.
- (internally illuminated with Sloan Prism Enlighten white 6500k, laid out 1.5 modules per foot, 6" on center installed to back of letter with sloan power supply with U.L. approved closure.



Fasten letters flush to wall with required fasteners.

Sign must be approved by the National Electrical Code, Underwriters Laboratory, CIU., and all applicable local codes. Disconnect switch in primary to be within sight of sign (sign includes power supply enclosure). REF. NEC 110-3[8] 600-2, 600-4 Primary electrical source (1/2*(13mm) conduit minimum) REF. NEC 600-6, 600-21 (provided by installer)

SloanLED"

3"(76mm) Deep channel letter 1"(25mm) Black Trimcap with square head screws 3/16"(5mm) White acrylic Disconnect switch White LED illumination-Flushed mounted to fasciawith mininum 3/8" lag bolts. - 5"x 5" aluminum transformer Class II supply wire-.063 Aluminum Letter Backs-Fabricated 5"(127mm) raceway Letter Section View Scale: NTS

PROJECT ADDRESS:

DATE: 10-23-2019

935 SWEETWATER ROAD Spring Valley, CA 91977 PROJECT NO: 16350

PREPARED BY:

ZAAP, INC. 2900 FOURTH AVENUE #204 SAN DIEGO, CA 92103 619-233-6450 WWW.ZAAP.BIZ

SHEET NUMBER SBMT

05


SHOPPING CENTER - SPRING VALLEY





C2 18" DAY/NITE CHANNEL LETTERS ~ Qty (1)

SCALE: 3/8"=1"

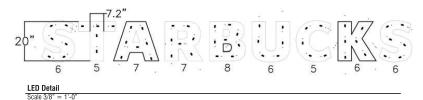



STARBUCKS SPECIFICATION:

- A Internally illuminated channel letters to be fabricated from 0.040 / 3003 aluminum with pre painted White interiors and painted Black polyurethane exteriors, 3"(76mm) deep. Letters backs to be .063 Black & White aluminum popriveted to sidewalls and sealed.
- B Faces to be 3/16" white acrylic faces with 3M day/nite perforated vinyl applied to faces and black trim cap retainer edging.
- (B) Internally illuminated with Sloan Prism Enlighten white 6500k, laid out 1.5 modules per foot, 6" on center installed to back of letter with sloan power supply with U.L. approved closure.



Fasten letters flush to wall with required fasteners.

Sign must be approved by the National Electrical Code, Underwriters Laboratory, CUL, and all applicable local codes. Disconnect switch in primary to be within sight of sign (sign includes power supply enclosure) REF: NEC 110-3[B] 600-2, 600-4
Primary electrical source (1/2"(13mm) conduit minimum) REF: NEC 600-6, 600-21
(provided by installer)

1"(25mm) Black Trimcap with square head screws 3/16"(5mm) White acrylic Disconnect switch White LED illumination-Flushed mounted to fasciawith mininum 3/8" lag bolts. -5"x 5" aluminum transformer Class II supply wire-.063 Aluminum Letter Backs-Fabricated 5"(127mm) raceway Letter Section View Scale: NTS

3"(76mm) Deep channel letter

PROJECT ADDRESS:

DATE: 10-23-2019 935 SWEETWATER ROAD


Spring Valley, CA 91977 PROJECT NO: 16350

PREPARED BY:

ZAAP, INC. 2900 FOURTH AVENUE #204 SAN DIEGO, CA 92103 619-233-6450 WWW.ZAAP.BIZ

SHEET NUMBER SBM1

SHOPPING CENTER - SPRING VALLEY

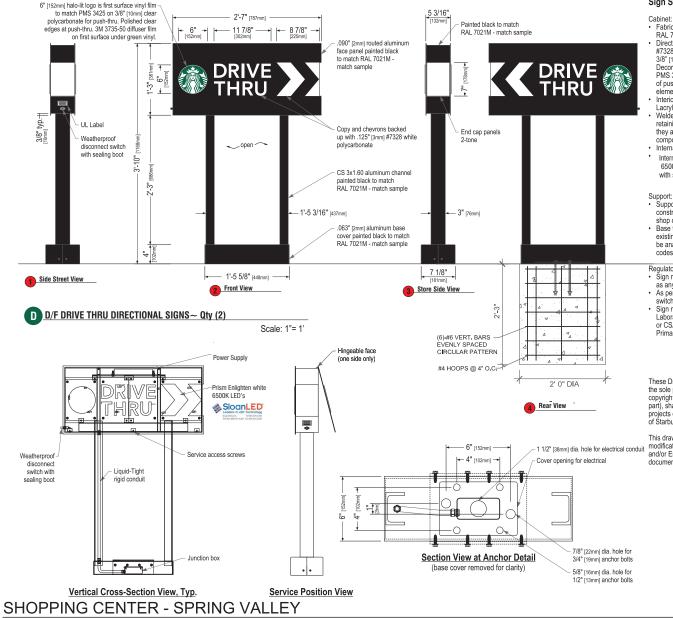

Sign Specifications:



- Fabricated .090" [2mm] aluminum housing painted black to match
- Fabricated Usey Zemij aluminum nousing painted back to match RAL 7021M with white end caps as shown.

 Directional copy and chevrons backed up with .125° [3mm]

 #7328 white polycarbonate. Siren logo is 6° [152mm] diameter, 3/8° [10mm] clear polycarbonate routed to push thru aluminum face. Decorate logo with 1st surface computer cut vinyl film to match PMS 3425 and 3735-50 diffuser film underneath green vinyl. Edges of push thru logo are to be clear polished. All polycarbonate face elements to be attached to aluminum face panel with weld studs.
- Interior aluminum surfaces of sign cabinet to be painted white with Lacryl Starbrite.
- Welded aluminum construction with no visible fasteners. Fasteners retaining the hinged face will be located on the bottom such that they are not visible. All fasteners used in the assembly of internal components shall be coated to prevent corrosion.
- · Internal structure of cabinet shall be per approved shop drawings.
- Internally illuminated logo disc with Sloan Prism Enlighten white 6500k, laid out at 1.5 modules per foot, 7" on center with self-contained power supply with U.L approved enclosure.

- · Supporting structure will be all welded aluminum tube and channel construction painted black to match RAL 7021M as per approved shop drawings and shall be integral to the sign cabinet.
- · Base tube will be constructed so that it can be retro-fittable to existing sign foundations. All foundations, existing and new must be analyzed for suitability and must meet all local city or state codes regulations.

Regulatory:

- Sign must meet all regulations in the National Electric Code as well as any local or state electrical codes.
- As per NEC 600.6, sign is equipped with a service disconnect
- Sign must be listed as an Electric Sign per Underwriters Laboratories UL48 and/or CSA and bear the appropriate UL, CUL or CSA relevant certification marks.

Primary power by electrical contractor per NEC







These Drawings and Specifications are confidential and shall remain the sole property of Starbucks Corporation, which is the owner of the copyright in this work. They shall not be reproduced (in whole or in part), shared with third parties or used in any manner on other projects or extensions to this project without the prior written consent of Starbucks Corporation.

This drawing is a Design Development Document. Site specific -1 1/2" [38mm] dia. hole for electrical conduit and/or Engineer-of-Record will be required prior to using this document for Bidding, Permitting, or Construction.

Size	Sq. Ft.1	Sq. Ft.2	Volts	Amps	
46" (1168mm)	1.51	9.90	120	0.85	

1: Figured as illuminated center part 2: Figured as complete signage

DATE: 10-23-2019 PROJECT ADDRESS: 935 SWEETWATER ROAD


Spring Valley, CA 91977 PROJECT NO: 16350

PREPARED BY: ZAAP, INC.

2900 FOURTH AVENUE #204 SAN DIEGO, CA 92103 619-233-6450 WWW.ZAAP.BIZ

SHEET NUMBER SBM

S.E.C. JAMACHA RD. & SWEETWATER RD. SPRING VALLEY, CA

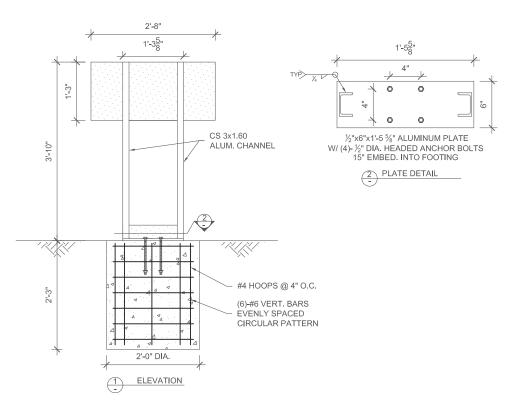

GENERAL NOTES

- 1. DESIGN CODE: CBC 2019/IBC 2018
- 2. DESIGN LOADS: ASCE 7-16
- 3. WIND VELOCITY 117 MPH, RISK CATEGORY II, EXPOSURE C
- CONCRETE MIN. 2500 PSI @ 28 DAYS
- 5. BOLTS AND HARDWARE SHALL BE HOT DIP GALVANIZED PER ASTM A153
- 6. STRUCTURAL STEEL BARS, PLATES AND ROLLED SHAPES ASTM A36
- 7. SOIL PASSIVE PRESSURE PER CBC CLASS 5 (100 PCF)
- 8. STEEL REINFORCEMENT IN CONCRETE ASTM A615 GRADE 60
- 9. PROVIDE MIN. 3" CLEAR COVER ON ALL STEEL EMBEDDED IN CONCRETE
- 10. SCOPE OF WORK IS LIMITED TO THE DESIGN OF SIGN SUPPORT COLUMN(S) AND FOOTING. SCOPE OF WORK EXCLUDES PERFORMING CAPACITY CHECKS OF SIGN FRAMING AND ATTACHMENTS TO COLUMNS, ALL OF WHICH ARE BY OTHERS
- 11. ALL FABRICATING TO BE PERFORMED IN AN APPROVED SHOP
- 2. STRUCTURAL OBSERVATION PER SEC. 1704.6 IS REQUIRED FOR THIS PROJECT
- 13. ANCHOR BOLT STEEL ASTM F1554 GRADE 36
- 14. CONTACT YUNGMAN ENGINEERING IMMEDIATELY IF GROUNDWATER IS DISCOVERED DURING FOOTING EXCAVATION
- 15. STRUCTURAL STEEL WELDS SHALL BE IN COMPLIANCE WITH ANSI/AWS D1.1 AND AISC SPECIFICATIONS CHAPTER J. WELDERS SHALL BE CERTIFIED AS REQUIRED BY GOVERNING CODE AUTHORITY. WELDING SHALL BE PERFORMED BY ELECTRIC ARC PROCESS USING LOW-HYDROGEN ELECTRODES WITH FeXX=70 KSI MIN

SHOPPING CENTER - SPRING VALLEY

S.E.C. JAMACHA RD. & SWEETWATER RD. SPRING VALLEY, CA



2172 FELSPAR ST., UNIT B SAN DIEGO, CA 92109 (858) 705-0557 michael@yungmanengineering.com

PREPARED FOR: SIGN INDUSTRIES

STARBUCKS VARIOUS LOCATIONS, CALIFORNIA

PROJECT NUMBER: 1835C

DATE: 12-23-2019

SCALE: NO SCALE

DRAWN BY: MTY

DESIGNED BY: MTY

DATE

REVISIONS:

<u>/2</u>\

3



PROJECT ADDRESS:

935 SWEETWATER ROAD Spring Valley, CA 91977 PROJECT NO: 16350


PREPARED BY:

ZAAP, INC. 2900 FOURTH AVENUE #204 SAN DIEGO, CA 92103 619-233-6450 WWW.ZAAP.BIZ

DATE: 10-23-2019

SHEET NUMBER
SBMT
08



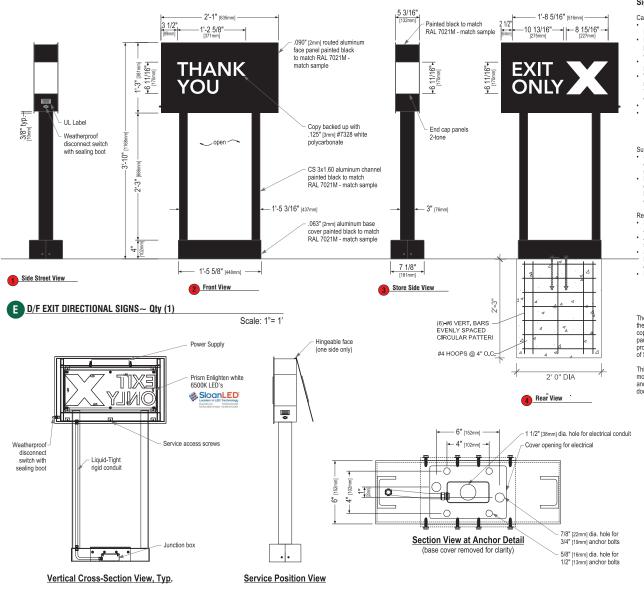

Sign Specifications:





- Fabricated .090" [2mm] aluminum housing painted black to match RAL 7021M with white end caps as shown. Directional copy backed up with .125" [3mm] #7328 white
- polycarbonate. All polycarbonate face elements to be attached to aluminum face panel with weld studs.

 Interior aluminum surfaces of sign cabinet to be painted white with
- Welded aluminum construction with no visible fasteners. Fasteners retaining the hinged face will be located on the bottom such that they are not visible. All fasteners used in the assembly of internal components shall be coated to prevent corrosion.
- Internal structure of cabinet shall be per approved shop drawings. Internally illuminated logo disc with Sloan Prism Enlighten white 6500k, laid out at 1.5 modules per foot, 7" on center with self-contained power supply with U.L approved enclosure.

- Support:

 Supporting structure will be all welded aluminum tube and channel construction painted black to match RAL 7021M as per approved
- shop drawings and shall be integral to the sign cabinet.

 Base tube will be constructed so that it can be retro-fittable to existing sign foundations. All foundations, existing and new must be analyzed for suitability and must meet all local city or state codes regulations.

- Sign must meet all regulations in the National Electric Code as well as any local or state electrical codes.
- As per NEC 600.6, sign is equipped with a service disconnect
- Sign must be listed as an Electric Sign per Underwriters
- Laboratories UL48 and/or CSA and bear the appropriate UL, CUL or CSA relevant certification marks.
- Primary power by electrical contractor per NEC.







These Drawings and Specifications are confidential and shall remain the sole property of Starbucks Corporation, which is the owner of the copyright in this work. They shall not be reproduced (in whole or in part), shared with third parties or used in any manner on other projects or extensions to this project without the prior written consent of Starbucks Corporation

This drawing is a Design Development Document. Site specific modifications made under the responsible charge of the Architect and/or Engineer-of-Record will be required prior to using this document for Bidding, Permitting, or Construction.

Size	Sq. Ft.1	Sq. Ft. ²	Volts	Amps
46" (1168mm)	0.94	7.99	120	0.85

1: Figured as illuminated center part 2: Figured as complete signage

DATE: 10-23-2019 PROJECT ADDRESS:

935 SWEETWATER ROAD Spring Valley, CA 91977 PROJECT NO: 16350

PREPARED BY:


ZAAP, INC. 2900 FOURTH AVENUE #204 SAN DIEGO, CA 92103 619-233-6450 WWW.ZAAP.BIZ SHEET NUMBER

SBM

09

SHOPPING CENTER - SPRING VALLEY

S.E.C. JAMACHA RD. & SWEETWATER RD. SPRING VALLEY, CA

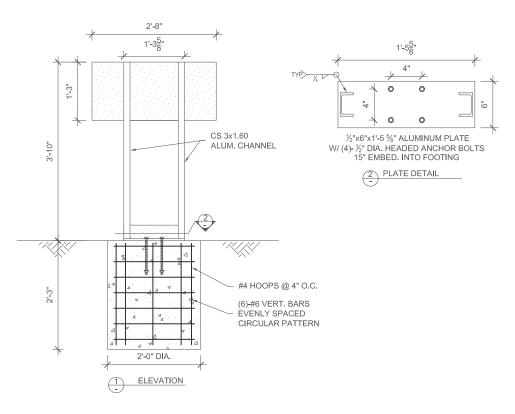

- DESIGN CODE: CBC 2019/IBC 2018
- DESIGN LOADS: ASCE 7-16
- WIND VELOCITY 117 MPH, RISK CATEGORY II, EXPOSURE C
- CONCRETE MIN. 2500 PSI @ 28 DAYS
- BOLTS AND HARDWARE SHALL BE HOT DIP GALVANIZED PER ASTM A153
- STRUCTURAL STEEL BARS, PLATES AND ROLLED SHAPES ASTM A36
- SOIL PASSIVE PRESSURE PER CBC CLASS 5 (100 PCF)
- STEEL REINFORCEMENT IN CONCRETE ASTM A615 GRADE 60
- PROVIDE MIN. 3" CLEAR COVER ON ALL STEEL EMBEDDED IN CONCRETE 9.
- SCOPE OF WORK IS LIMITED TO THE DESIGN OF SIGN SUPPORT COLUMN(S) AND FOOTING. SCOPE OF WORK EXCLUDES PERFORMING CAPACITY CHECKS OF SIGN FRAMING AND ATTACHMENTS TO COLUMNS, ALL OF WHICH ARE BY OTHERS
- ALL FABRICATING TO BE PERFORMED IN AN APPROVED SHOP
- STRUCTURAL OBSERVATION PER SEC. 1704.6 IS REQUIRED FOR THIS PROJECT
- ANCHOR BOLT STEEL ASTM F1554 GRADE 36 13.
- CONTACT YUNGMAN ENGINEERING IMMEDIATELY IF GROUNDWATER IS DISCOVERED DURING FOOTING EXCAVATION
- STRUCTURAL STEEL WELDS SHALL BE IN COMPLIANCE WITH ANSI/AWS D1.1 AND AISC SPECIFICATIONS CHAPTER J. WELDERS SHALL BE CERTIFIED AS REQUIRED BY GOVERNING CODE AUTHORITY. WELDING SHALL BE PERFORMED BY ELECTRIC ARC PROCESS USING LOW-HYDROGEN ELECTRODES WITH Fexx=70 KSI MIN

SHOPPING CENTER - SPRING VALLEY

S.E.C. JAMACHA RD. & SWEETWATER RD. SPRING VALLEY, CA



2172 FELSPAR ST., UNIT B SAN DIEGO, CA 92109 (858) 705-0557 michael@yungmanengineering.com

PREPARED FOR: SIGN INDUSTRIES

STARBUCKS VARIOUS LOCATIONS, CALIFORNIA

> PROJECT NUMBER: 1835C

DATE: 12-23-2019

SCALE: NO SCALE

DRAWN BY: MTY

DESIGNED BY: MTY

DATE

REVISIONS:

1 2

3



PROJECT ADDRESS:

DATE: 10-23-2019 935 SWEETWATER ROAD Spring Valley, CA 91977

PREPARED BY:


ZAAP, INC. 2900 FOURTH AVENUE #204 SAN DIEGO, CA 92103

PROJECT NO: 16350

619-233-6450 WWW.ZAAP.BIZ

SHEET NUMBER SBM 10



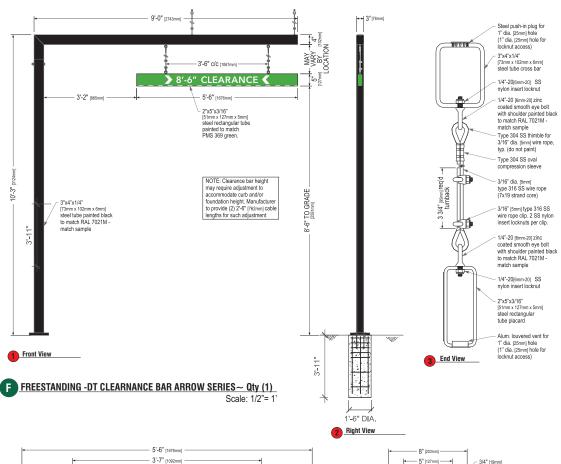

to be 3M #680-10 white

Scotchlite reflective vinyl film

Design ID#14106

SPECIFICATIONS: Scraper Bar:

- 2"x5" 51mm x 127mm] steel tube painted to match PMS 369 green.
- Flush steel end caps painted to match PMS 369 green.
- Copy and chevrons to be 1st surface computer cut 3M #680-10 white Scotchlite reflective vinyl film.
- Bottom striping to be 1st surface computer cut 3M #680-10 white Scotchlite reflective vinyl film. Striping extends 3/8" [10mm] onto front face
- Suspend from support with SS cable & hardware. Cable provided requires field adjustment for proper clearance height.


Support:


- Supporting structure will be all welded steel tube construction painted black to match RAL 7021M as per approved shop drawings
- Base tube will be constructed so that it can be retro-fittable to existing sign foundations. All foundations, existing and new must be analyzed for suitability and must meet all local city or state codes regulations.

These Drawings and Specifications are confidential and shall remain the sole property of Starbucks Corporation, which is the owner of the copyright in this work. They shall not be reproduced (in whole or in part), shared with third parties or used in any manner on other projects or extensions to this project without the prior written consent of Starbucks Corporation.

This drawing is a Design Development Document. Site specific modifications made under the responsible charge of the Architect and/or Engineer-of-Record will be required prior to using this document for Bidding, Permitting, or Construction.


Size	Sq. Ft.		
10'-3" (3124mm)	2.29		

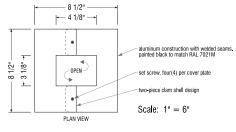

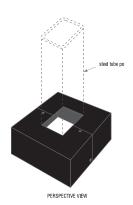

DATE: 10-23-2019

Base Plate Cover Detail

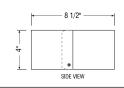

- 7/8"x2 3/4"x30" [22mm x 70mm x 30"] radiused slot for 3/4" [19mm] anchor bolts

3"x4"x1/4"

173mm x 102mm x 6mm

steel tube cross bar

O3/16* I5mml ✓

Scale: 1" = 6"

Base Plate Detail

PROJECT ADDRESS:

935 SWEETWATER ROAD
Spring Valley, CA 91977
PROJECT NO: 16350

PREPARED BY:

ZAAP, INC. 2900 FOURTH AVENUE #204 SAN DIEGO, CA 92103 619-233-6450 WWW.ZAAP.BIZ SHEET NUMBER
SBMT

SHOPPING CENTER - SPRING VALLEY

CLEARANCE

Front View @ Placard - Graphic Details


5'-6" [1676mm]

Bottom View @ Placard - Graphic Details

S.E.C. JAMACHA RD. & SWEETWATER RD. SPRING VALLEY, CA

2" typ. [51mm] 2" typ. [51mm]

painted to match PMS 369 green

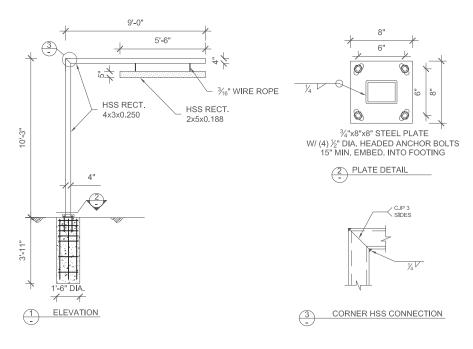

GENERAL NOTES

- 1. DESIGN CODE: CBC 2019/IBC 2018
- DESIGN LOADS: ASCE 7-16
- 3. WIND VELOCITY 117 MPH, RISK CATEGORY II, EXPOSURE C
- 4. CONCRETE MIN. 2500 PSI @ 28 DAYS
- 5. CABLE STEEL ASTM A475
- 6. HSS RECT TUBE STEEL ASTM A500 GRADE B, 46 KSI
- 7. BOLTS AND HARDWARE SHALL BE HOT DIP GALVANIZED PER ASTM A153
- 8. STRUCTURAL STEEL BARS, PLATES AND ROLLED SHAPES ASTM A36
- 9. SOIL PASSIVE PRESSURE PER CBC CLASS 5 (100 PCF)
- 10. STEEL REINFORCEMENT IN CONCRETE ASTM A615 GRADE 60
- 11. PROVIDE MIN. 3" CLEAR COVER ON ALL STEEL EMBEDDED IN CONCRETE
- SCOPE OF WORK IS LIMITED TO THE DESIGN OF SIGN SUPPORT COLUMN(S) AND FOOTING. SCOPE OF WORK EXCLUDES PERFORMING CAPACITY CHECKS OF SIGN FRAMING AND ATTACHMENTS TO COLUMNS, ALL OF WHICH ARE BY OTHERS
- 13. ALL FABRICATING TO BE PERFORMED IN AN APPROVED SHOP
- 14. STRUCTURAL OBSERVATION PER SEC. 1704.6 IS REQUIRED FOR THIS PROJECT
- 15. ANCHOR BOLT STEEL ASTM F1554 GRADE 36
- 16. CONTACT YUNGMAN ENGINEERING IMMEDIATELY IF GROUNDWATER IS DISCOVERED DURING FOOTING EXCAVATION
- 17. STRUCTURAL STEEL WELDS SHALL BE IN COMPLIANCE WITH ANSI/AWS D1.1 AND AISC SPECIFICATIONS CHAPTER J. WELDERS SHALL BE CERTIFIED AS REQUIRED BY GOVERNING CODE AUTHORITY. WELDING SHALL BE PERFORMED BY ELECTRIC ARC PROCESS USING LOW-HYDROGEN ELECTRODES WITH Fexx=70 KSI MIN

SHOPPING CENTER - SPRING VALLEY

S.E.C. JAMACHA RD. & SWEETWATER RD. SPRING VALLEY, CA



2172 FELSPAR ST., UNIT B SAN DIEGO, CA 92109 (858) 705-0557 mlchael@yungmanengineering.com

PREPARED FOR: SIGN INDUSTRIES

STARBUCKS VARIOUS LOCATIONS, CALIFORNIA

PROJECT NUMBER: 1835B

DATE: 12-23-2019

SCALE: NO SCALE

DRAWN BY: MTY

DESIGNED BY: MTY

REVISIONS:

NO. DATE

1

2

<u>/3\</u>



PROJECT ADDRESS:


PROJECT NO: 16350

935 SWEETWATER ROAD
Spring Valley, CA 91977

PREPARED BY:

ZAAP, INC. 2900 FOURTH AVENUE #204 SAN DIEGO, CA 92103 619-233-6450 WWW.ZAAP.BIZ DATE: 10-23-2019

SHEET NUMBER

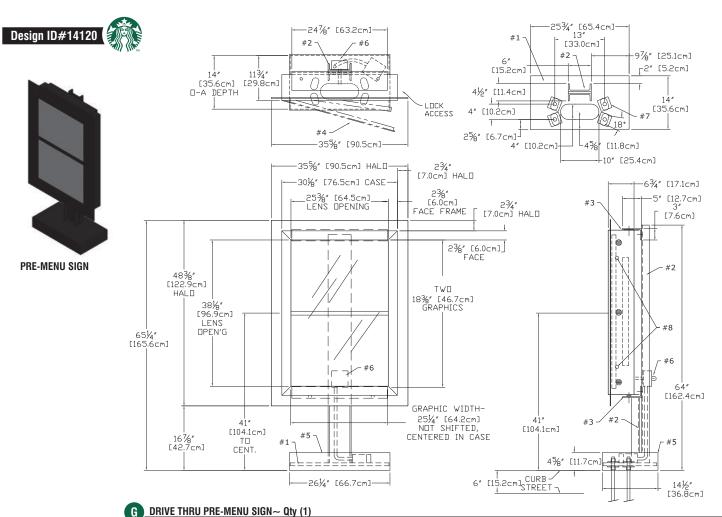

Sign Specifications:

- #1 -¾" [19mm] STEEL BASE PLATE w/ 18deg HOLES PATTERN LEFT SQUARE / SYMETRICAL
- #2 C6X10.5 (6"x2"x5/16") STEEL POST (1x)
- #3 5"x3"X'4" STEEL SUPPORT ANGLES (2x) (WELDED TO STEEL POST) #4 EXTRUDED ALUMINUM MENU BOARD (1x) ONE SPLIT PANEL LIGHTBOX TWO 251/4"x183/8" GRAPHICS GRAPHIC ASSEMBLY CENTERED, NOT SHIFTED STANDARD LED TUBE LIGHTING, SIDE LOCKS
- #5 WELDED ALUMINUM BASE COVER
- #6 WATER-TIGHT BOX w/SWITCHES & SENSOR, RIDGID CONDUIT RUN TO SECOND EXT BOX BELOW BASE COVER, 120 WATT, 0.30Aac
- #7 8 BASE WASHERS, ½" THICK
 #8 TWO SIDE MOUNT LOCKS, RETAIN EXISTING
- KEY #E3-26-819-15

APPROVED 02/04/14

RAL7021 BLACK GREY, 10% SHEEN, EXT

	DT PRE ORDER FREESTANDING				11036584		
OF DISA IT IS DIS REPRODE IN PART	ALL DESIGNAL OPERATIVE AND PROCESS DATA PERTAINING TO THE WITCLE SHOWN ON THIS SHEET IS THE PROPERTY IT IS DISCLOSED IN CONFIDENCE AND IS NOT TO SE COHED, REPRECUCED, REPEALD TO, OR APPRIORMANT DAY OTHERS, IN PACT OR IN WALL, WITHOUT THE OPISSES COMESTING THE OFFICE OF THE OFFICE OF THE OFFICE O		DSA/PHOTOTECH 16961 Central Avenue, Carson, CA 90746 (310) 537-5000 (310) 537-7060 Fax Phubbell@dsaphototech.com				
BE USED			DRIVE THRU PRE ORDER w/ STAND				
PAH	DATE 02/13/14	CQSBEDTPRELED		1:16	s		

INSTALLATION ONLY

Scale: 3/4" = 1'

PROJECT ADDRESS:


DATE: 10-23-2019


935 SWEETWATER ROAD Spring Valley, CA 91977 PROJECT NO: 16350

PREPARED BY:

ZAAP, INC. 2900 FOURTH AVENUE #204 SAN DIEGO, CA 92103 619-233-6450 WWW.ZAAP.BIZ

SHEET NUMBER SBM

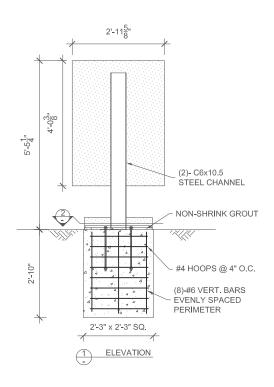

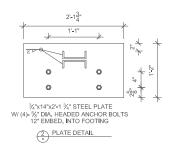

GENERAL NOTES

- DESIGN CODE: CBC 2019/IBC 2018
- DESIGN LOADS: ASCE 7-16
- WIND VELOCITY 117 MPH, RISK CATEGORY II, EXPOSURE C
- CONCRETE MIN. 2500 PSI @ 28 DAYS
- BOLTS AND HARDWARE SHALL BE HOT DIP GALVANIZED PER ASTM A153
- STRUCTURAL STEEL BARS, PLATES AND ROLLED SHAPES ASTM A36
- SOIL PASSIVE PRESSURE PER CBC CLASS 5 (100 PCF)
- STEEL REINFORCEMENT IN CONCRETE ASTM A615 GRADE 60
- PROVIDE MIN. 3" CLEAR COVER ON ALL STEEL EMBEDDED IN CONCRETE
- SCOPE OF WORK IS LIMITED TO THE DESIGN OF SIGN SUPPORT COLUMN(S) AND FOOTING. SCOPE OF WORK EXCLUDES PERFORMING CAPACITY CHECKS OF SIGN FRAMING AND ATTACHMENTS TO COLUMNS, ALL OF WHICH ARE BY OTHERS
- ALL FABRICATING TO BE PERFORMED IN AN APPROVED SHOP
- STRUCTURAL OBSERVATION PER SEC. 1704.6 IS REQUIRED FOR THIS PROJECT
- ANCHOR BOLT STEEL ASTM F1554 GRADE 36
- CONTACT YUNGMAN ENGINEERING IMMEDIATELY IF GROUNDWATER IS DISCOVERED DURING FOOTING EXCAVATION
- STRUCTURAL STEEL WELDS SHALL BE IN COMPLIANCE WITH ANSI/AWS D1.1 AND AISC SPECIFICATIONS CHAPTER J. WELDERS SHALL BE CERTIFIED AS REQUIRED BY GOVERNING CODE AUTHORITY. WELDING SHALL BE PERFORMED BY ELECTRIC ARC PROCESS USING LOW-HYDROGEN ELECTRODES WITH Fexx=70 KSI MIN

SHOPPING CENTER - SPRING VALLEY

S.E.C. JAMACHA RD. & SWEETWATER RD. SPRING VALLEY, CA



2172 FELSPAR ST., UNIT B SAN DIEGO, CA 92109 (858) 705-0557 mlchael@yungmanengineering.com

PREPARED FOR: SIGN INDUSTRIES

STARBUCKS VARIOUS LOCATIONS, CALIFORNIA

> PROJECT NUMBER: 1835K

DATE: 12-23-2019

SCALE: NO SCALE

DRAWN BY: MTY

DESIGNED BY: MTY

REVISIONS: DATE NO.

 \triangle

2

3



PROJECT ADDRESS:

935 SWEETWATER ROAD Spring Valley, CA 91977 PROJECT NO: 16350


PREPARED BY:

ZAAP, INC. 2900 FOURTH AVENUE #204 SAN DIEGO, CA 92103 619-233-6450 WWW.ZAAP.BIZ

DATE: 10-23-2019

SHEET NUMBER **SBM1**



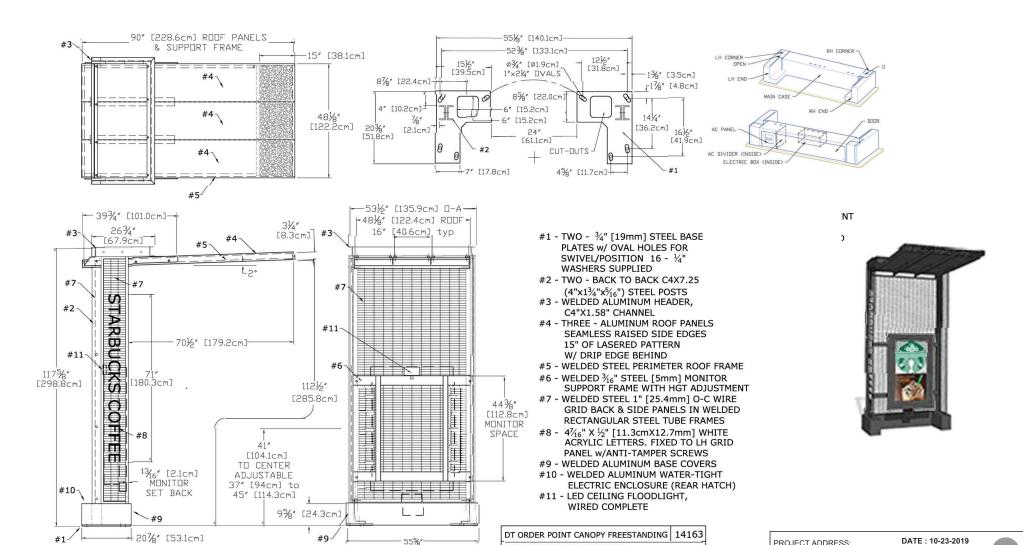

RAL7021 BLACK GREY, 10% SHEEN, EXT

DRIVE THRU CANOPY WITH DIGITAL ORDER SCREEN~ Qty (1) INSTALLATION ONLY

NTS

OPC, NO MONITOR OR ORDER BOARD

SHOPPING CENTER - SPRING VALLEY

S.E.C. JAMACHA RD. & SWEETWATER RD. SPRING VALLEY, CA

PROJECT ADDRESS:


935 SWEETWATER ROAD Spring Valley, CA 91977 PROJECT NO: 16350

PREPARED BY:

ZAAP, INC. 2900 FOURTH AVENUE #204 SAN DIEGO, CA 92103 619-233-6450 WWW.ZAAP.BIZ

SHEET NUMBER SBM1



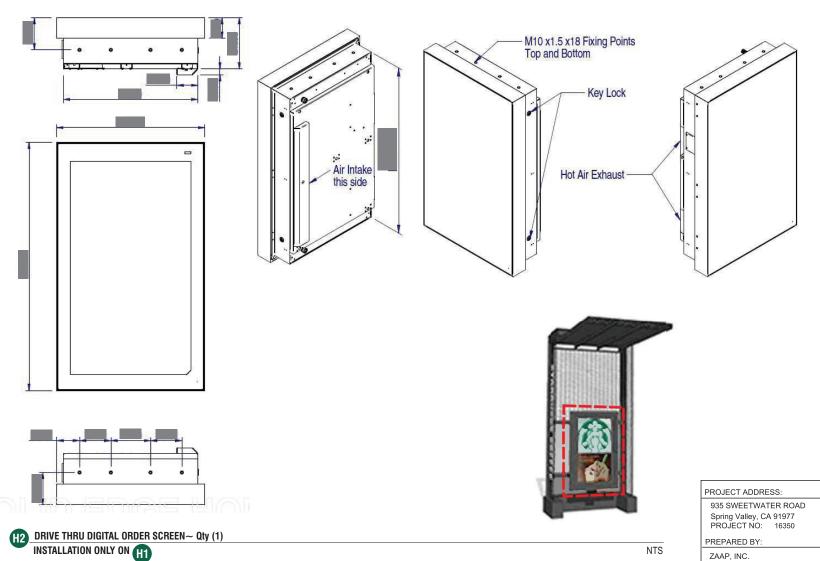

DATE: 10-23-2019

SHEET NUMBER

16


SBMT

2900 FOURTH AVENUE #204

619-233-6450 WWW.ZAAP.BIZ

SAN DIEGO, CA 92103


SHOPPING CENTER - SPRING VALLEY S.E.C. JAMACHA RD. & SWEETWATER RD. SPRING VALLEY, CA

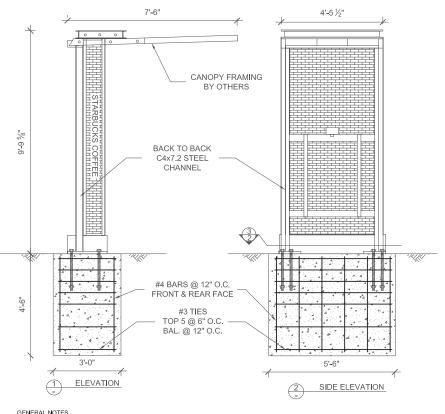


- GENERAL NOTES
 1. DESIGN CODE: CBC 2019/IBC 2018
- DESIGN LOADS: ASCE 7-16
 WIND VELOCITY 117 MPH, RISK CATEGORY II, EXPOSURE C
- CONCRETE MIN. 2500 PSI @ 28 DAYS
- BOLTS AND HARDWARE SHALL BE HOT DIP GALVANIZED PER ASTM A153 STRUCTURAL STEEL BARS, PLATES AND ROLLED SHAPES ASTM A36
- SOIL PASSIVE PRESSURE PER CBC CLASS 5 (100 PCF)
- ROOF LIVE LOAD 20 PSF GROUND SNOW LOAD 20 PSF
- STEEL REINFORCEMENT IN CONCRETE ASTM A615 GRADE 60
- PROVIDE MIN. 3" CLEAR COVER ON ALL STEEL EMBEDDED IN CONCRETE
- SCOPE OF WORK IS LIMITED TO THE DESIGN OF SIGN SUPPORT COLUMN(S) AND FOOTING. SCOPE OF WORK EXCLUDES PERFORMING CAPACITY CHECKS OF SIGN FRAMING AND ATTACHMENTS TO COLUMNS, ALL OF WHICH ARE BY OTHERS
- ALL FABRICATING TO BE PERFORMED IN AN APPROVED SHOP STRUCTURAL OBSERVATION PER SEC. 1704.6 IS REQUIRED FOR THIS PROJECT
- ANCHOR BOLT STEEL ASTM F1554 GRADE 36
- CONTACT YUNGMAN ENGINEERING IMMEDIATELY IF GROUNDWATER IS DISCOVER DURING FOOTING EXCAVATION
- STRUCTURAL STEEL WELDS SHALL BE IN COMPLIANCE WITH ANSI/AWS D1.1 AND / SPECIFICATIONS CHAPTER J. WELDERS SHALL BE CERTIFIED AS REQUIRED BY GOVERNING CODE AUTHORITY. WELDING SHALL BE PERFORMED BY ELECTRIC AR PROCESS USING LOW-HYDROGEN ELECTRICORS WITH Fexx≡70 KSI MIN

SHOPPING CENTER - SPRING VALLEY

S.E.C. JAMACHA RD. & SWEETWATER RD. SPRING VALLEY, CA

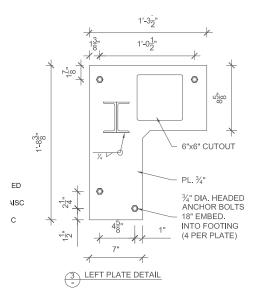

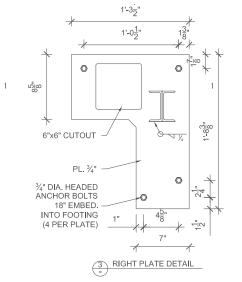



2172 FELSPAR ST., UNIT B SAN DIEGO CA 92109 (858) 705-0557 mlchael@yungmanenglneering.com

PREPARED FOR: SIGN INDUSTRIES

STARBUCKS VARIOUS LOCATIONS, CALIFORNIA

PROJECT NUMBER: 1835H

DATE: 12-23-2019

SCALE: NO SCALE

DRAWN BY: MTY

DESIGNED BY: MTY

REVISIONS: NO.

A

2

<u> 3</u>



PROJECT ADDRESS:

935 SWEETWATER ROAD Spring Valley, CA 91977 PROJECT NO: 16350

PREPARED BY:


ZAAP, INC. 2900 FOURTH AVENUE #204 SAN DIEGO, CA 92103 619-233-6450 WWW.ZAAP.BIZ

DATE: 10-23-2019

SBMT





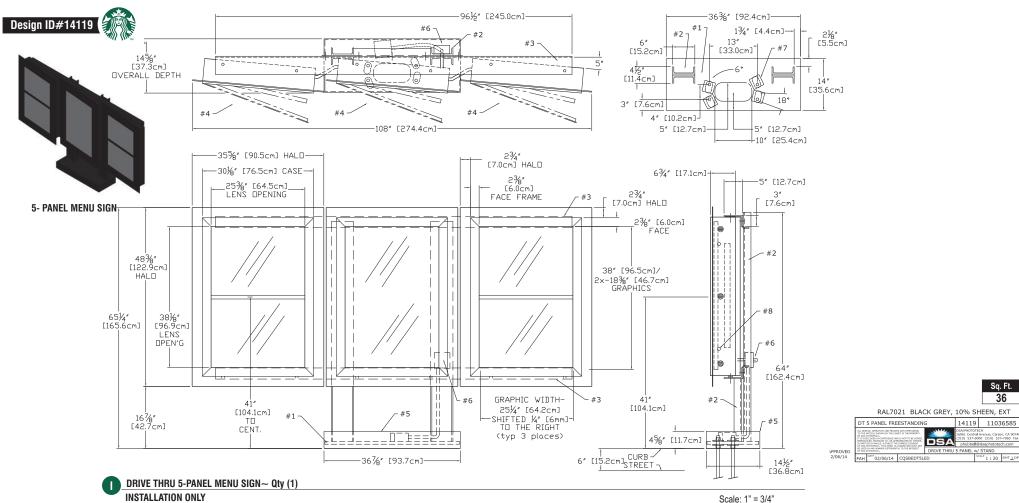

INSTALLATION ONLY

Sign Specifications:

- $\#1\ -34$ " [19mm] STEEL BASE PLATE w/ 18deg HOLES PATTERN ROTATED FOR 15deg THRU 3deg POSITION
- #2 C6X10.5 (6"x2"x5/16") STEEL POST (2x) #3 - 5"x3"X1/4" STEEL SUPPORT ANGLES (2x)
- (BOLTED TO WELDED 1/4" STEEL CROSSBARS)
- #4 EXTRUDED ALUMINUM MENU BOARDS (3x) ONE FULL AND TWO SPLIT PANEL LIGHTBOXES ONE - 251/4"x38" AND FOUR 251/4"x183/8" GRAPHICS ALL GRAPHIC ASSEMBLIES SHIFTED 1/4" TO RIGHT STANDARD LED TUBE LIGHTING, SIDE LOCKS
- #5 WELDED ALUMINUM BASE COVER
- #6 WATER-TIGHT BOX w/SWITCH & SENSOR. RIDGID CONDUIT RUN TO SECOND EXT BOX BELOW BASE COVER, 120 WATT, 0,90Aac
- #7 8 BASE WASHERS, 1/4" THICK
- #8 TWO SIDE MOUNT LOCKS per MENUBOARD RETAIN EXISTING KEY #E3-26-819-15

PROJECT ADDRESS:

DATE: 10-23-2019 935 SWEETWATER ROAD

Spring Valley, CA 91977 PROJECT NO: 16350

PREPARED BY:


ZAAP, INC. 2900 FOURTH AVENUE #204 SAN DIEGO, CA 92103 619-233-6450 WWW.ZAAP.BIZ


SHEET NUMBER SBM1


18

SHOPPING CENTER - SPRING VALLEY

S.E.C. JAMACHA RD. & SWEETWATER RD. SPRING VALLEY, CA

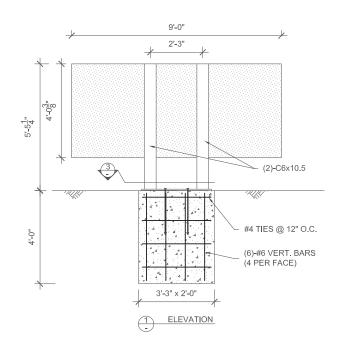

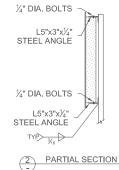

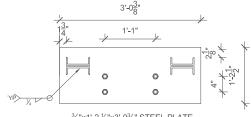

 $\frac{3}{4}$ "x1'-2 $\frac{1}{2}$ "x3'-0 $\frac{3}{8}$ " STEEL PLATE W/ (4)-3/4" DIA. HEADED ANCHOR BOLTS 20" EMBED. INTO FOOTING



- **GENERAL NOTES**
- DESIGN CODE: CBC 2019/IBC 2018
- DESIGN LOADS: ASCE 7-16 3.
- WIND VELOCITY 117 MPH, RISK CATEGORY II, EXPOSURE C
- CONCRETE MIN. 2500 PSI @ 28 DAYS 5.
- BOLTS AND HARDWARE SHALL BE HOT DIP GALVANIZED PER ASTM A153 6.
- STRUCTURAL STEEL BARS, PLATES AND ROLLED SHAPES ASTM A36
- 8. SOIL PASSIVE PRESSURE PER CBC CLASS 5 (100 PCF)
- 9. STEEL REINFORCEMENT IN CONCRETE ASTM A615 GRADE 60
- PROVIDE MIN. 3" CLEAR COVER ON ALL STEEL EMBEDDED IN CONCRETE 10
- SCOPE OF WORK IS LIMITED TO THE DESIGN OF SIGN SUPPORT COLUMN(S) AND FOOTING. SCOPE OF WORK EXCLUDES PERFORMING CAPACITY CHECKS OF SIGN FRAMING AND ATTACHMENTS TO COLUMNS, ALL OF WHICH ARE BY OTHERS
- ALL FABRICATING TO BE PERFORMED IN AN APPROVED SHOP
- STRUCTURAL OBSERVATION PER SEC. 1704.6 IS REQUIRED FOR THIS PROJECT
- ANCHOR BOLT STEEL ASTM F1554 GRADE 36
- CONTACT YUNGMAN ENGINEERING IMMEDIATELY IF GROUNDWATER IS DISCOVERED DURING FOOTING EXCAVATION
- STRUCTURAL STEEL WELDS SHALL BE IN COMPLIANCE WITH ANSI/AWS D1.1 AND AISC SPECIFICATIONS CHAPTER J. WELDERS SHALL BE CERTIFIED AS REQUIRED BY GOVERNING CODE AUTHORITY. WELDING SHALL BE PERFORMED BY ELECTRIC ARC PROCESS USING LOW-HYDROGEN ELECTRODES WITH Fexx=70 KSI MIN

SHOPPING CENTER - SPRING VALLEY

S.E.C. JAMACHA RD. & SWEETWATER RD. SPRING VALLEY, CA



2172 FELSPAR ST., UNIT B SAN DIEGO, CA 92109 (858) 705-0557 mlchael@yungmanenglneering.com

PREPARED FOR: SIGN INDUSTRIES

STARBUCKS VARIOUS LOCATIONS, CALIFORNIA

> PROJECT NUMBER: 1835i

DATE: 12-23-2019

SCALE: NO SCALE

DRAWN BY: MTY

DESIGNED BY: MTY

DATE

 Λ

2

3

PROJECT ADDRESS:

DATE: 10-23-2019 935 SWEETWATER ROAD

Spring Valley, CA 91977 PROJECT NO: 16350

PREPARED BY:

ZAAP, INC. 2900 FOURTH AVENUE #204 SAN DIEGO, CA 92103 619-233-6450 WWW.ZAAP.BIZ SHEET NUMBER **SBM**1



SPRING VALLEY SIGN PACKAGE "EXISTING MONUMENT SIGNS WITH NEW TENANTS"

PROJECT ADDRESS:

DATE: 10-23-2019

935 SWEETWATER ROAD Spring Valley, CA 91977 PROJECT NO: 16350

PREPARED BY:

ZAAP, INC. 2900 FOURTH AVENUE #204 SAN DIEGO, CA 92103 619-233-6450 WWW.ZAAP.BIZ SHEET NUMBER

TS-9

SHOPPING CENTER - SPRING VALLEY

S.E.C. JAMACHA RD. & SWEETWATER RD. SPRING VALLEY, CA

FIELD SURVEY REQUIRED JAMACHA ROAD SIGN



14 3/4",17 1/8" 14 3/4",17 1/8" **Smart&Final** 2'-2 3/4" // VO target ROSS DRESS 2-1" 20" (2'-23/4" 2'-23/4" 2'-23/4" VO (1 VO (1 VO dd's discounts **CVS** pharmacy **ORELLY AUTO PARTS** WHITE ACRYLIC FACE WITH TRANSLUCENT VINYL APPLIED FIRST SURFACE EAST FACING TENANT LAYOUT

NEW D/F ILLUM. PYLON SIGN

NEW D/F ILLUMINATED PYLON SIGN TENANT PANEL

SCALE: 1/4" = 1'-0"

EXISTING MONUMENT SIGN WITH NEW PROPOSED TENANTS

PROJECT ADDRESS:

DATE: 03 24 2020

935 SWEETWATER ROAD Spring Valley, CA 91977 PROJECT NO: 16350

PREPARED BY:

ZAAP, INC. 2900 FOURTH AVENUE #204 SAN DIEGO, CA 92103 619-233-6450 WWW.ZAAP.BIZ SHEET NUMBER

M-1 25' MONUMENT SIGN EXISTING



S.E.C. JAMACHA RD. & SWEETWATER RD. SPRING VALLEY, CA

FIELD SURVEY REQUIRED SWEETWATER ROAD SIGN **Smart&Final Smart&Final** 18" 21" / 18" 21" 3'-6" VO 3'-6" VO / ROSS POR LESS OSS POR LESS dd's discounts dd's discounts 3'-6" VO 21" 21" 3'-6" VO VO 11 VO 11 **♥CVS** pharmacy **CVS** pharmacy WHITE ACRYLIC FACE WITH **O**Refilly TRANSLUCENT VINYL APPLIED 3.8" FIRST SURFACE AUTO PARTS Chick-fil-A AUTO PARTS Chick-fil-A NORTH FACING TENANT LAYOUT SOUTH FACING TENANT LAYOUT

CHICK-FIL-A - NEW S/F ILLUMINATED PYLON SIGN TENANT PANEL

SCALE: 3/16" = 1'-0"

NEW S/F ILLUM. PYLON SIGN

EXISTING MONUMENT SIGN WITH NEW PROPOSED TENANTS

PROJECT ADDRESS:

DATE: 03 24 2020

935 SWEETWATER ROAD Spring Valley, CA 91977 PROJECT NO: 16350

PREPARED BY:

ZAAP, INC. 2900 FOURTH AVENUE #204 SAN DIEGO, CA 92103 619-233-6450 WWW.ZAAP.BIZ SHEET NUMBER

M-2 35' MONUMENT SIGN EXISTING

SHOPPING CENTER - SPRING VALLEY

S.E.C. JAMACHA RD. & SWEETWATER RD. SPRING VALLEY, CA



EXISTING "RALLY'S" MONUMENT SIGN NTS

SHOPPING CENTER - SPRING VALLEY

S.E.C. JAMACHA RD. & SWEETWATER RD. SPRING VALLEY, CA

PROJECT ADDRESS:

DATE: 04 01 2020


935 SWEETWATER ROAD Spring Valley, CA 91977 PROJECT NO: 16350

PREPARED BY:

ZAAP, INC. 2900 FOURTH AVENUE #204 SAN DIEGO, CA 92103 619-233-6450 WWW.ZAAP.BIZ SHEET NUMBER


M-3 18' MONUMENT SIGN EXISTING



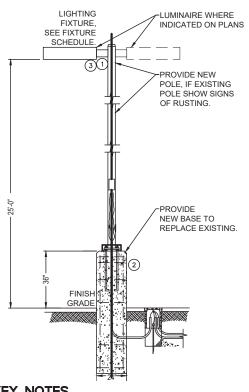



- ROUTE FIXTURE CIRCUIT TO LIGHTING CONTROL PANEL FOR SHUTOFF PHOTOCELL 'ON'. TIMECLOCK 'OFF'.
- 2) PROVIDE 24" DIAMETER CONCRETE BASE 5' DEEP.

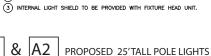



EXISTING 25'TALL POLE LIGHTS AR-2



EXISTING 35'TALL POLE LIGHTS



PROJECT ADDRESS:

DATE: 12/29/2020

935 SWEETWATER ROAD Spring Valley, CA 91977 PROJECT NO: 16350

PREPARED BY:

ZAAP, INC. 2900 FOURTH AVENUE #204 SAN DIEGO, CA 92103 619-233-6450 WWW.ZAAP.BIZ SHEET NUMBER

LI 1 POLE LIGHT **ELEVATIONS**



S.E.C. JAMACHA RD. & SWEETWATER RD. SPRING VALLEY, CA

